



DEPARTMENT OF VETERANS AFFAIRS


GEORGIA NATIONAL CEMETERY

4000 NICHE COLUMBARIUM


NCA PROJECT NO. 922CM3005
1080 VETERANS CEMETERY RD, CANTON, GA 30114



LOCATION MAP

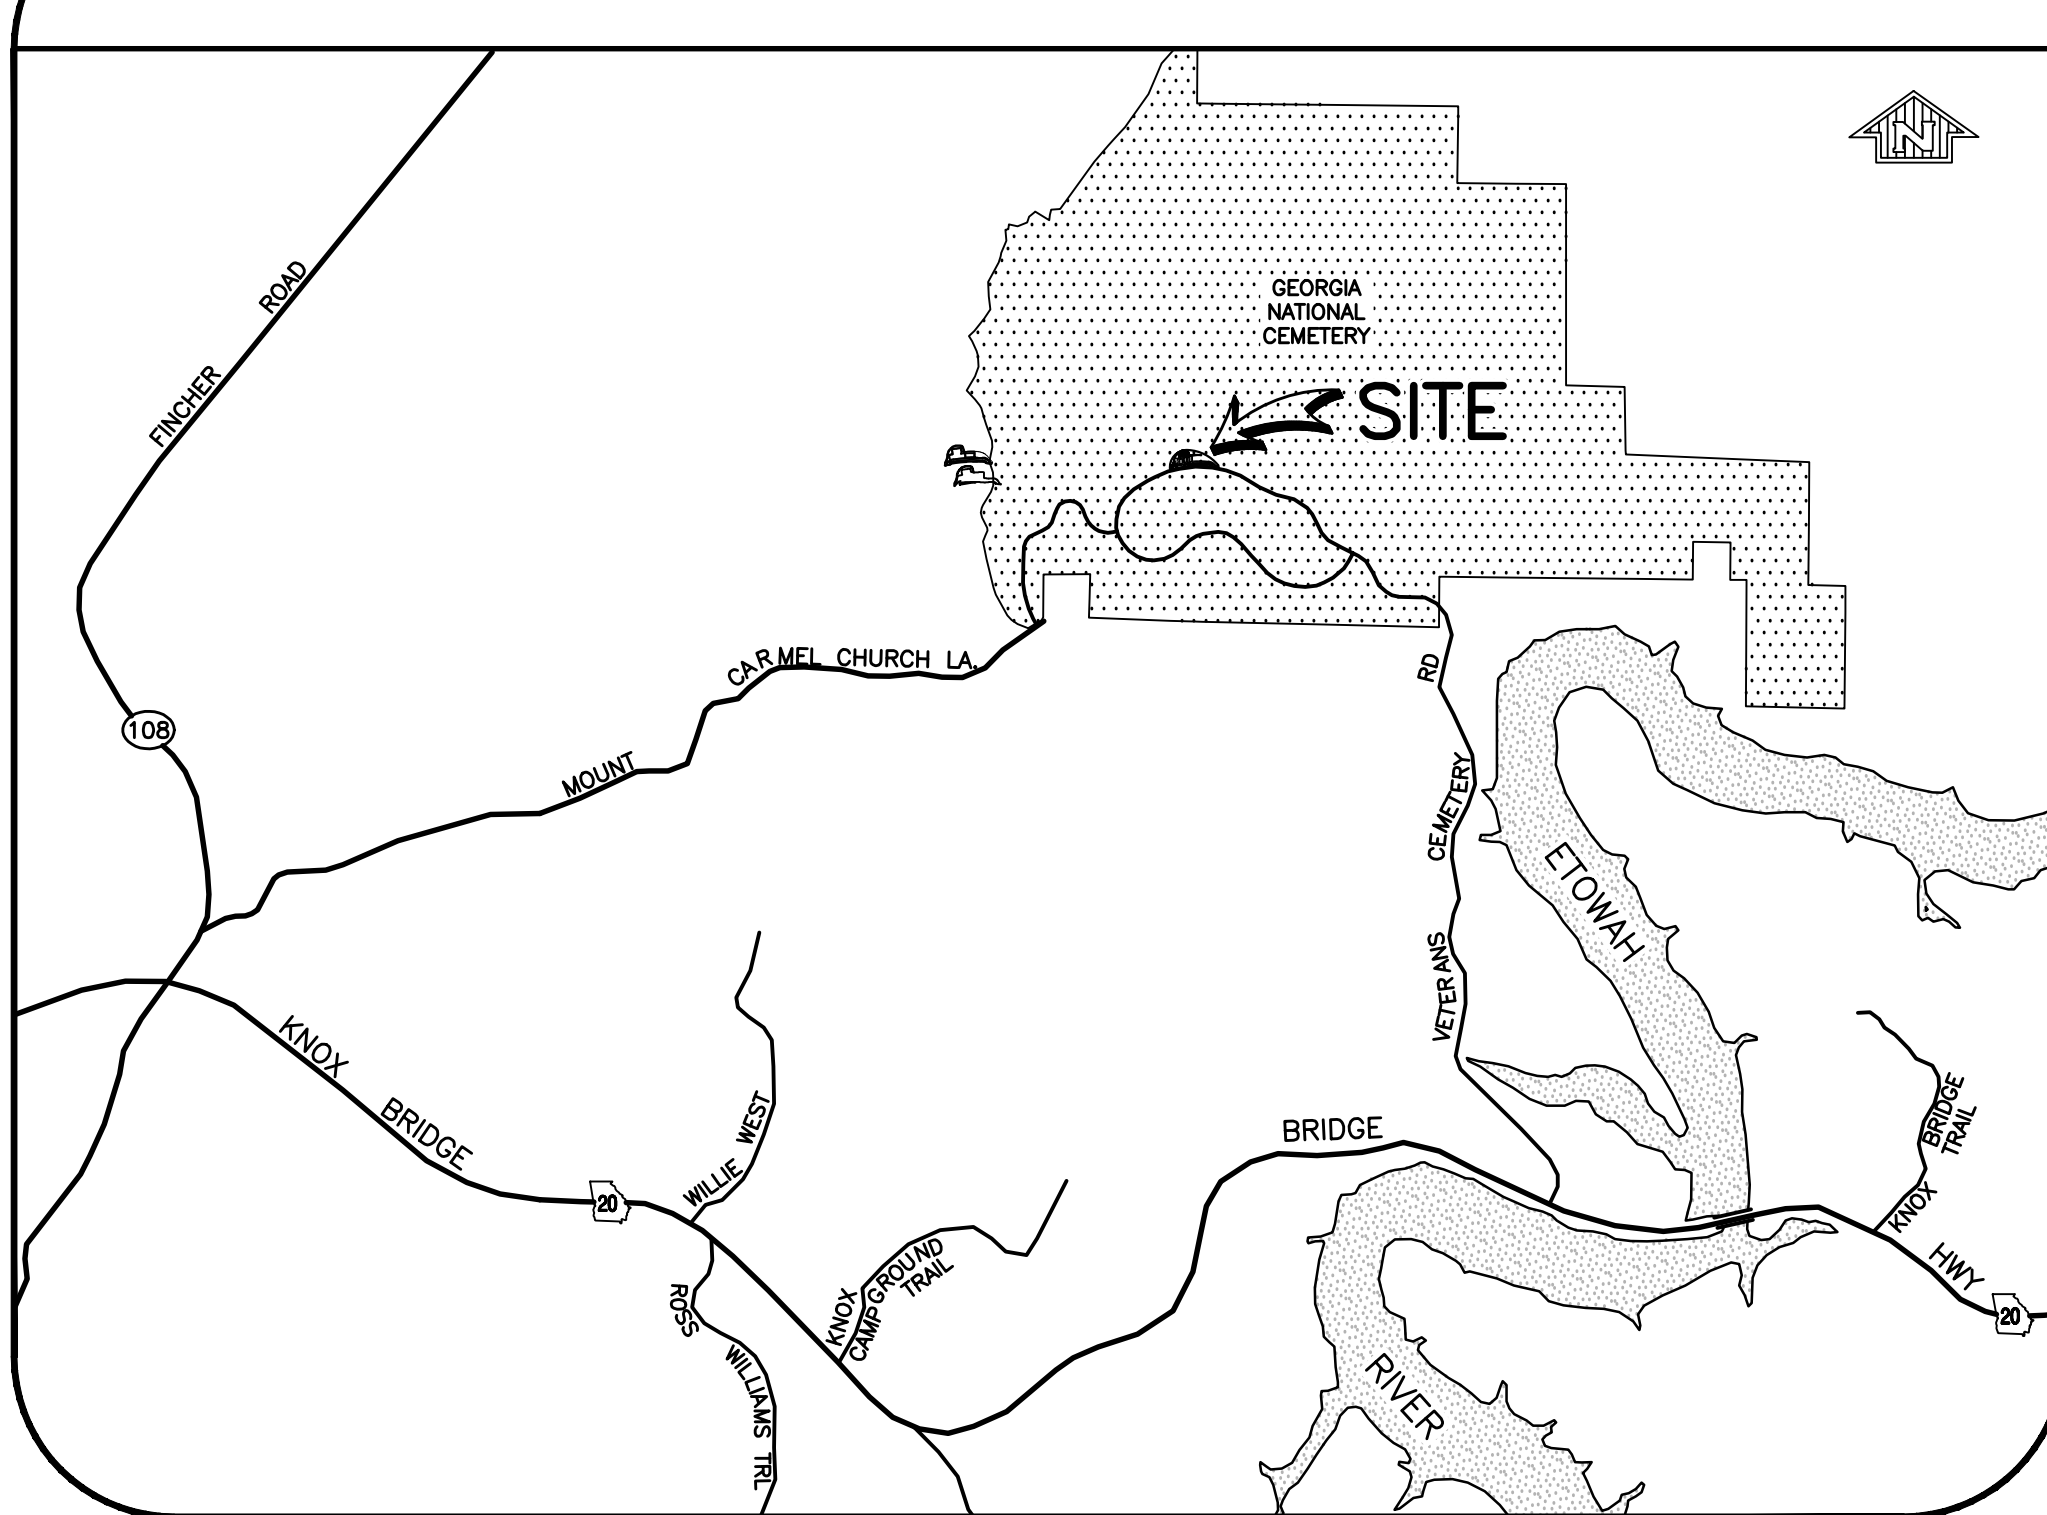

F.I.R.M. PANEL

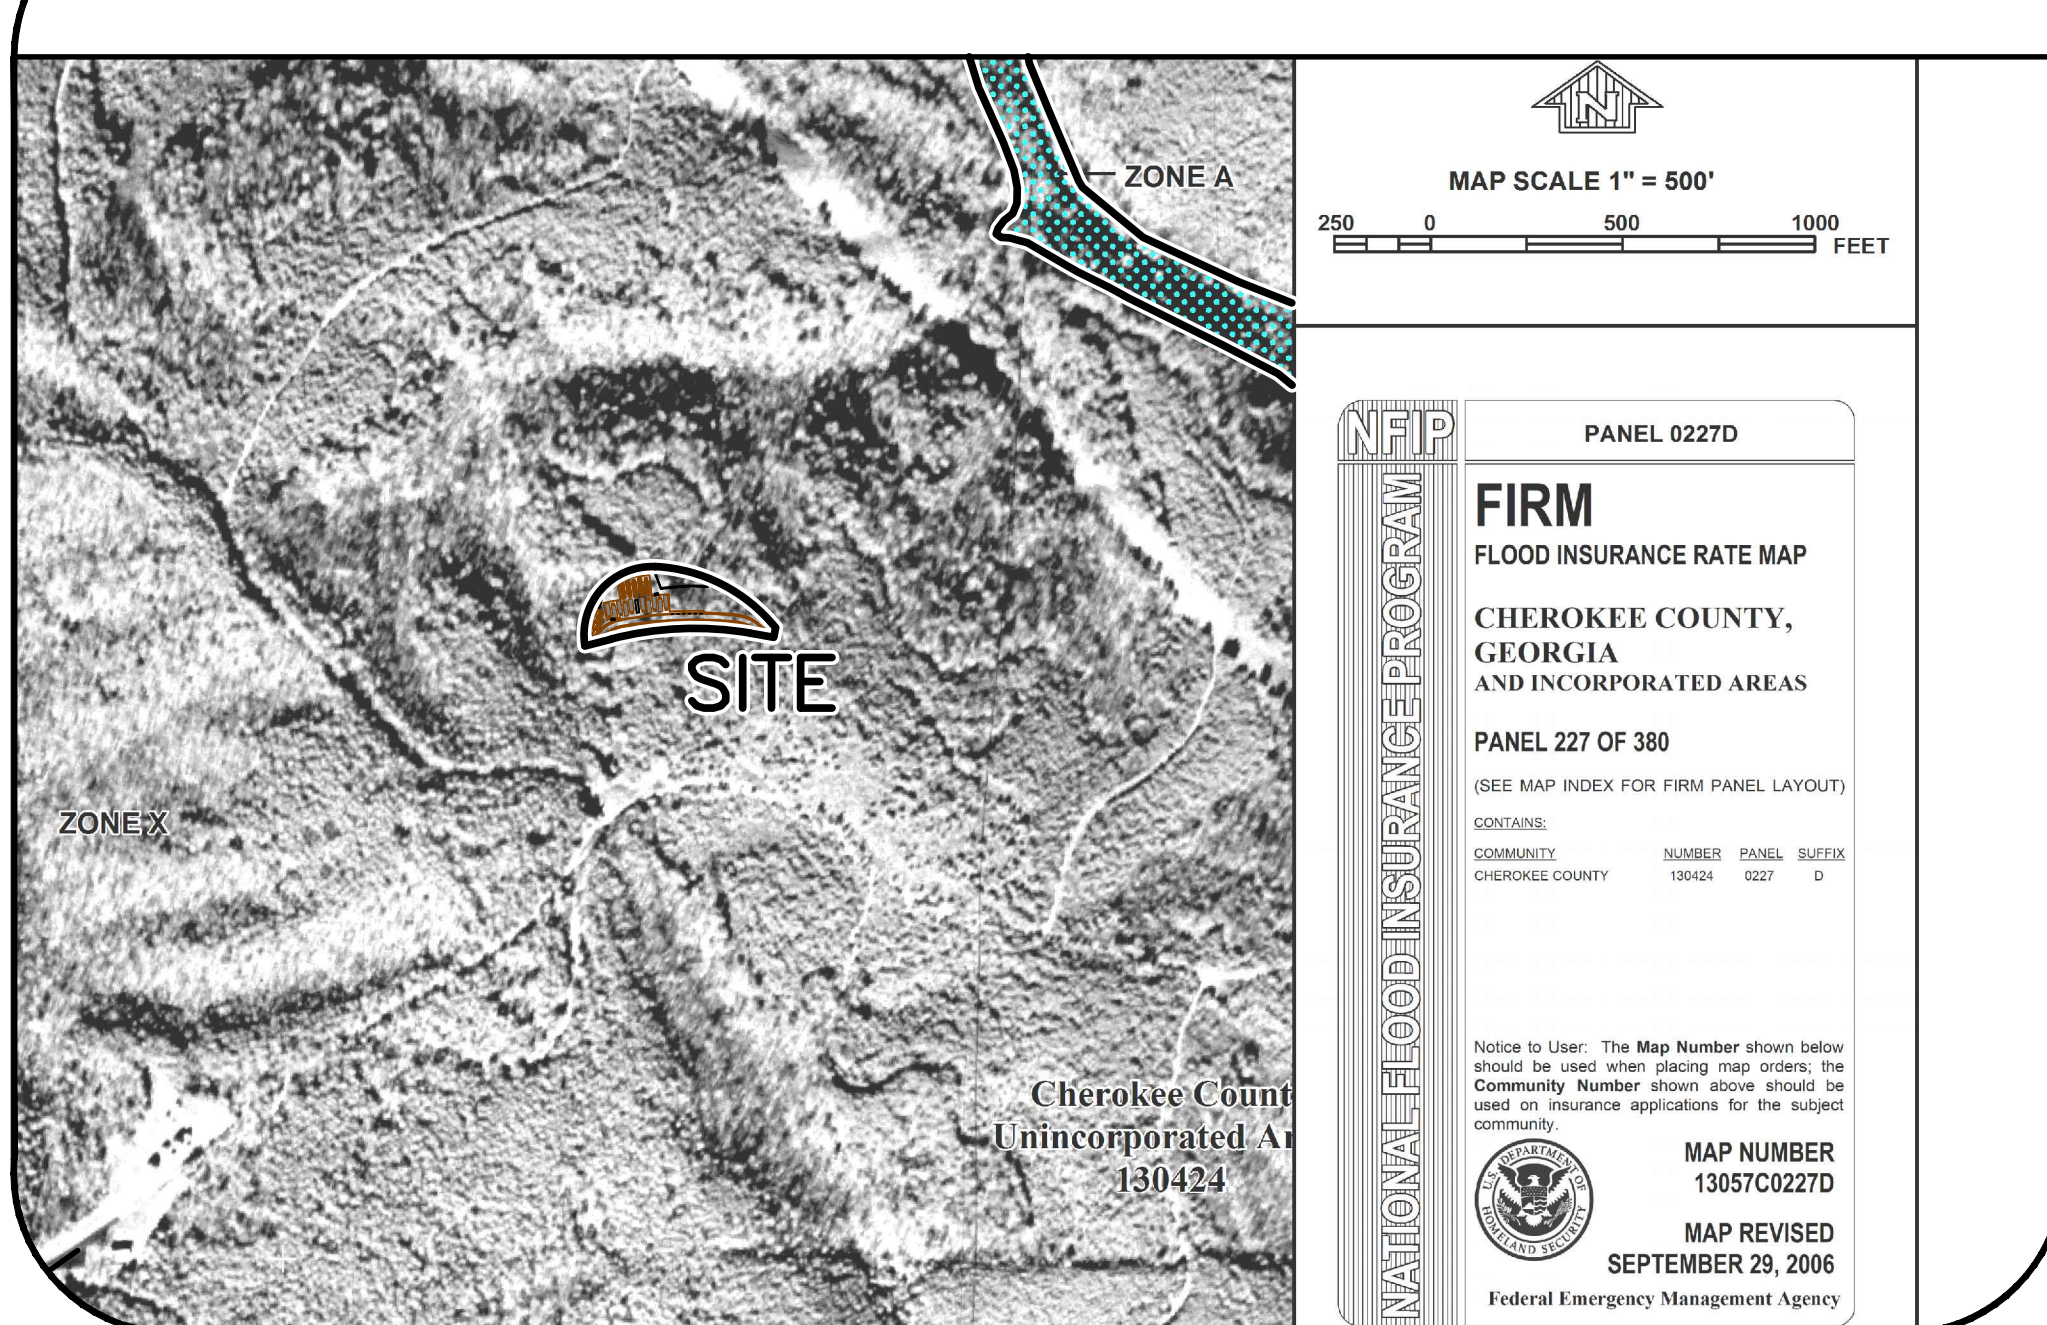

GENERAL NOTES

1. TOPOGRAPHIC INFORMATION PROVIDED FIELD-RUN TOPOGRAPHIC SURVEY PERFORMED BY AMEC FOSTER WHEELER ENVIRONMENT AND INFRASTRUCTURE COMPLETED ON MARCH 12, 2015. THE GENERAL CONTRACTOR SHALL VERIFY ALL SURVEY INFORMATION.
2. VERTICAL CONTROL IS REFERENCED TO THE NORTH AMERICAN VERTICAL DATUM OF 1988 (NAVD 88).
3. THE EXISTING UNDERGROUND UTILITIES SHOWN HEREON ARE BASED UPON AVAILABLE INFORMATION. THE CONTRACTOR SHALL BE RESPONSIBLE FOR DETERMINING THE EXACT LOCATION OF ALL UTILITIES PRIOR TO BEGINNING ANY WORK. IF UTILITIES OTHER THAN THOSE SHOWN HEREON ARE ENCOUNTERED, THE CONTRACTOR SHALL NOTIFY THE ENGINEER IMMEDIATELY AND TAKE APPROPRIATE MEASURES TO PROTECT THE LINE(S) AND ENSURE CONTINUED SERVICE. DAMAGE CAUSED TO EXISTING UTILITIES BY THE CONTRACTOR SHALL BE REPAIRED BY THE CONTRACTOR AT NO ADDITIONAL COST TO THE OWNER. THE CONTRACTOR SHALL VERIFY THE CONNECTION POINTS OF NEW UTILITIES TO EXISTING UTILITIES PRIOR TO BEGINNING CONSTRUCTION.
4. THE CONTRACTOR SHALL INSTALL TREE PROTECTION BARRICADES PRIOR TO BEGINNING EARTHWORK OPERATIONS.
5. THE CONTRACTOR SHALL NOTIFY THE ENGINEER IF UNSUITABLE MATERIAL IS DISCOVERED PRIOR TO BEGINNING ANY REMOVAL OPERATION.
6. THE CONTRACTOR SHALL ADD NEW SOD TO MATCH EXISTING.
7. CONTRACTOR SHALL GRADE ALL DISTURBED AREAS TO DRAIN FOR POSITIVE FLOW PRIOR TO FINAL APPROVAL. ALL DISTURBED AREAS TO BE RESTORED TO PRE-CONSTRUCTION CONDITION.
8. THE DESIGN ADEQUACY AND SAFETY OF ALL BRACING, SHORING AND TEMPORARY SUPPORTS, ETC. IS THE SOLE RESPONSIBILITY OF THE CONTRACTOR.
9. IN PERFORMING CONSTRUCTION OBSERVATION VISITS TO THE JOB SITE, THE ENGINEER SHALL HAVE NEITHER CONTROL OVER NOR RESPONSIBILITY FOR THE CONTRACTOR'S MEANS, METHODS, SEQUENCE, TECHNIQUES OR PROCEDURES IN PERFORMING THE WORK.
10. THE CONTRACTOR'S MEANS, METHODS, SEQUENCE, TECHNIQUES OR PROCEDURES IN PERFORMING THE WORK IS SOLELY THE RESPONSIBILITY OF THE CONTRACTOR, WHO IS ALSO RESPONSIBLE FOR COMPLYING WITH ALL HEALTH AND SAFETY PRECAUTIONS AS REQUIRED BY ANY REGULATORY AGENCY.
11. MATERIAL QUANTITIES ARE ESTIMATED FOR INFORMATION PURPOSES ONLY. CONTRACTOR IS RESPONSIBLE FOR VERIFYING ALL QUANTITIES OF REPAIRED OR REPLACED MATERIALS.
12. BURIAL CEREMONIES WILL BE SCHEDULED THROUGHOUT THE COURSE OF THIS PROJECT. DURING ALL CEREMONIES, ALL WORK SHALL STOP ESPECIALLY WHEN HEAVY EQUIPMENT ACTIVITY OR NOISE PRODUCING WORK IS BEING DONE. LIGHT WORK ACTIVITY MAY CONTINUE IF IT DOES NOT CREATE NOISE OR DISTRACTIONS TO THE CEREMONY. COORDINATE DAILY ACTIVITIES WITH THE CEMETERY DIRECTOR OR HIS APPROVED REPRESENTATIVE TO ACCOMMODATE SCHEDULED BURIALS.
13. BECAUSE OF THE SENSITIVE NATURE OF THE CEMETERY SITE, CONTRACTOR SHALL MAINTAIN EACH WORK AREA IN A CLEAN AND ORDERLY APPEARANCE. TRASH AND WASTE MATERIALS SHALL BE STORED IN APPROVED CONTAINERS AND ROUTINELY DISPOSED OF OFF-SITE. CLEANUP SHALL BE REQUIRED AT THE END OF EACH DAY AND/OR MORE FREQUENTLY AS REQUIRED.
14. THE AFFECT OF WORK ON PUBLIC ACCESS SHALL BE MINIMAL AND SHALL BE COORDINATED WITH THE CEMETERY DIRECTOR. ANY ALTERED PUBLIC TRAFFIC ROUTES SHALL BE WELL DEFINED WITH PROFESSIONALLY MADE SIGNAGE AND/OR OTHER APPROVED CONVENTIONAL METHODS.
15. THERE SHALL BE AT ALL TIMES, WHEN WORK IS BEING DONE, A COMPETENT PERSON WHO IS APPRISED OF THE CONDITION AND PROGRESS OF ALL AREAS OF WORK ON SITE. THIS COMPETENT PERSON SHALL BE ABLE TO SPEAK FOR AND ACT IN THE BEHALF OF THE CONTRACTOR. HE SHALL BE AWARE AND KNOWLEDGEABLE OF ALL THE SAFETY CONCERNS ON THE JOB SITE. HE SHALL BE EMPOWERED TO IMMEDIATELY AND EFFECTIVELY MITIGATE THE ACTIONS OF ANY WORKMAN ON SITE.
16. CONTRACTOR SHALL PREPARE AND SUBMIT A WELDING PLAN TO THE COTR PRIOR TO PERFORMING ANY FIELD WELDING. FOLLOWING APPROVAL ALL WELDS SHALL BE PERFORMED IN ACCORDANCE WITH THE APPROVED PLAN.
17. DO NOT WORK UPON NOR STORE ANY MATERIALS ON OCCUPIED GRAVE PLOTS. MAINTAIN MINIMUM DISTANCE OF 50 FEET BETWEEN CONSTRUCTION AND OCCUPIED GRAVE PLOTS.
18. NO VEHICLES OF THE CONTRACTOR OR HIS SUBS SHALL PARK ON CEMETERY ROADS.

CIVIL ABBREVIATIONS

BW	BOTTOM WALL	MAX	MAXIMUM
CO	CLEANOUT	MIN	MINIMUM
CONC	CONCRETE	NTS	NOT TO SCALE
DIA	DIAMETER	PSI	POUNDS PER SQUARE INCH
HDPE	HIGH DENSITY POLYETHYLENE	PVC	POLYVINYL CHLORIDE
HDWD	HARDWOOD	RCP	REINFORCED CONCRETE PIPE
HWY	HIGHWAY	SD	STORM DRAIN
INV	INVERT	SLCPC	SMOOTH LINED CORRUGATED PLASTIC PIPE
LA	LANDSCAPE AREA	TW	TOP OF WALL
L/P	LOW POINT	TYP	TYPICAL

EROSION CONTROL NOTES

1. ACTIVITIES PERFORMED ON THIS PROJECT MUST COMPLY WITH THE REQUIREMENTS OF GEORGIA NRCS AND GEORGIA SWCC.
2. PROVIDE SILT FENCE AND/OR OTHER CONTROL DEVICES, AS MAY BE REQUIRED, TO CONTROL SOIL EROSION.
3. ALL EROSION CONTROL DEVICES SHALL BE PROPERLY MAINTAINED DURING ALL PHASES OF CONSTRUCTION UNTIL THE COMPLETION OF ALL CONSTRUCTION ACTIVITIES AND ALL DISTURBED AREAS HAVE BEEN STABILIZED, ADDITIONAL CONTROL DEVICES MAY BE REQUIRED DURING CONSTRUCTION IN ORDER TO CONTROL EROSION AND/OR OFF SITE SEDIMENTATION. ALL TEMPORARY CONTROL DEVICES SHALL BE REMOVED ONCE CONSTRUCTION IS COMPLETE AND THE SITE IS STABILIZED.
4. THE CONTRACTOR MUST TAKE NECESSARY ACTION TO MINIMIZE THE TRACKING OF MUD ONTO THE PAVED ROADWAY FROM CONSTRUCTION AREAS, THE CONTRACTOR SHALL DAILY REMOVE MUD/SOIL FROM PAVEMENT, AS MAY BE REQUIRED.
5. ALL SEDIMENT AND EROSION CONTROL DEVICES SHALL BE INSPECTED EVERY SEVEN (7) DAYS OR AFTER EACH RAINFALL OCCURRENCE THAT EXCEEDS ONE-HALF (0.5) INCH. DAMAGED OR INEFFECTIVE DEVICES SHALL BE REPAIRED TO REPLACED, AS NECESSARY.
6. THE CONTRACTOR SHALL GRASS ALL AREAS DISTURBED BY CONSTRUCTION. STABILIZATION MEASURES SHALL BE INITIATED AS SOON AS PRACTICAL IN PORTIONS OF THE SITE WHERE CONSTRUCTION ACTIVITIES HAVE TEMPORARILY OR PERMANENTLY CEASED, BUT IN NO CASE MORE THAN FOURTEEN (14) DAYS AFTER WORK HAS CEASED, UNLESS ACTIVITY IN THAT PORTION OF THE SITE WILL RESUME WITHIN TWENTY-ONE (21) DAYS. IF WORK IS SUSPENDED OR DELAYED FOR MORE THAN 14 DAYS, THE CONTRACTOR SHALL TEMPORARILY STABILIZE THE DISTURBED AREA AT NO ADDITIONAL COST TO THE OWNER.

APPLICABLE CODES AND STANDARDS

- '12 IBC – 2012 International Building Code
- '12 IEBC – 2012 International Existing Building Code
- '12 IFC – 2012 International Fire Code
- '12 IMC – 2012 International Mechanical Code
- '12 IFGC – 2012 International Fuel Gas Code
- '12 IPC – 2012 International Plumbing Code
- '11 NEC – 2011 National Electrical Code
- '06 IECC – 2006 International Energy Conservation Code
- '12 IPMC – 2012 International Property Maintenance Code
- '10 ADA Standards – 2010 ADA Standards for Accessible Design

INDEX OF DRAWINGS

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3	B-102	EXISTING CONDITIONS
4	D-101	DEMOLITION PLAN
5	C-101	SITE PLAN
6	C-102	GRADING AND DRAINAGE PLAN
7	C-103	INITIAL EROSION & SEDIMENT CONTROL PLAN
8	C-104	INTERMEDIATE EROSION & SEDIMENT CONTROL PLAN
9	C-105	FINAL EROSION & SEDIMENT CONTROL PLAN
10	C-201	COLUMBARIUM LAYOUT ENLARGEMENT
11	C-202	COLUMBARIUM STORM ENLARGEMENT
12	C-203	COLUMBARIUM IDENTIFICATION PLAN
13	C-211	ROADWAY PLAN AND PROFILE
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30	I-104	IRRIGATION DETAILS
31	S-501	COLUMBARIUM FOOTING DETAILS



Know what's below.
Call before you dig.


PROJECT SUMMARY

COLUMBARIUM NICHES 4000


THIS PROPERTY IS NOT LOCATED WITHIN A DESIGNATED FLOODPLAIN OR BELOW THE BASE FLOOD ELEVATION ACCORDING TO FLOOD INSURANCE RATE MAP PANEL NO. 13057C00227D, DATED SEPTEMBER 29, 2006. "ZONE A": NO BASE FLOOD ELEVATION DETERMINED.

BID DOCUMENTS


Revisions	Date	PRIME: AMEC FOSTER WHEELER ENVIRONMENT & INFRASTRUCTURE 1075 BIG SHANTY ROAD NW, SUITE 100 KENNESAW, GA. 30144 (770) 421-3400 AMEC PROJECT: 6166-15-0011	MEP ENGINEER: 	IRRIGATION DESIGNER: Irrigation Consultant Services 2231 Weatherstone Circle Conyers, GA 30094 (770) 929-0884, fax (770) 760-8025	 NATIONAL CEMETERY ADMINISTRATION	Drawing Title COVER SHEET	Project Title 4000 NICHE COLUMBARIUM GEORGIA NATIONAL CEMETERY	Date 23 OCTOBER 2015
Approved: Director, Technical Support Service		Building Number	Checked	Drawn	Project No. 922CM3005	DRAWING NO. X-001		Sheet 1 of 31
Approved: Chief, Architectural & Engineering Division		Location 1080 VETERANS CEMETERY RD, CANTON, GA 30114						

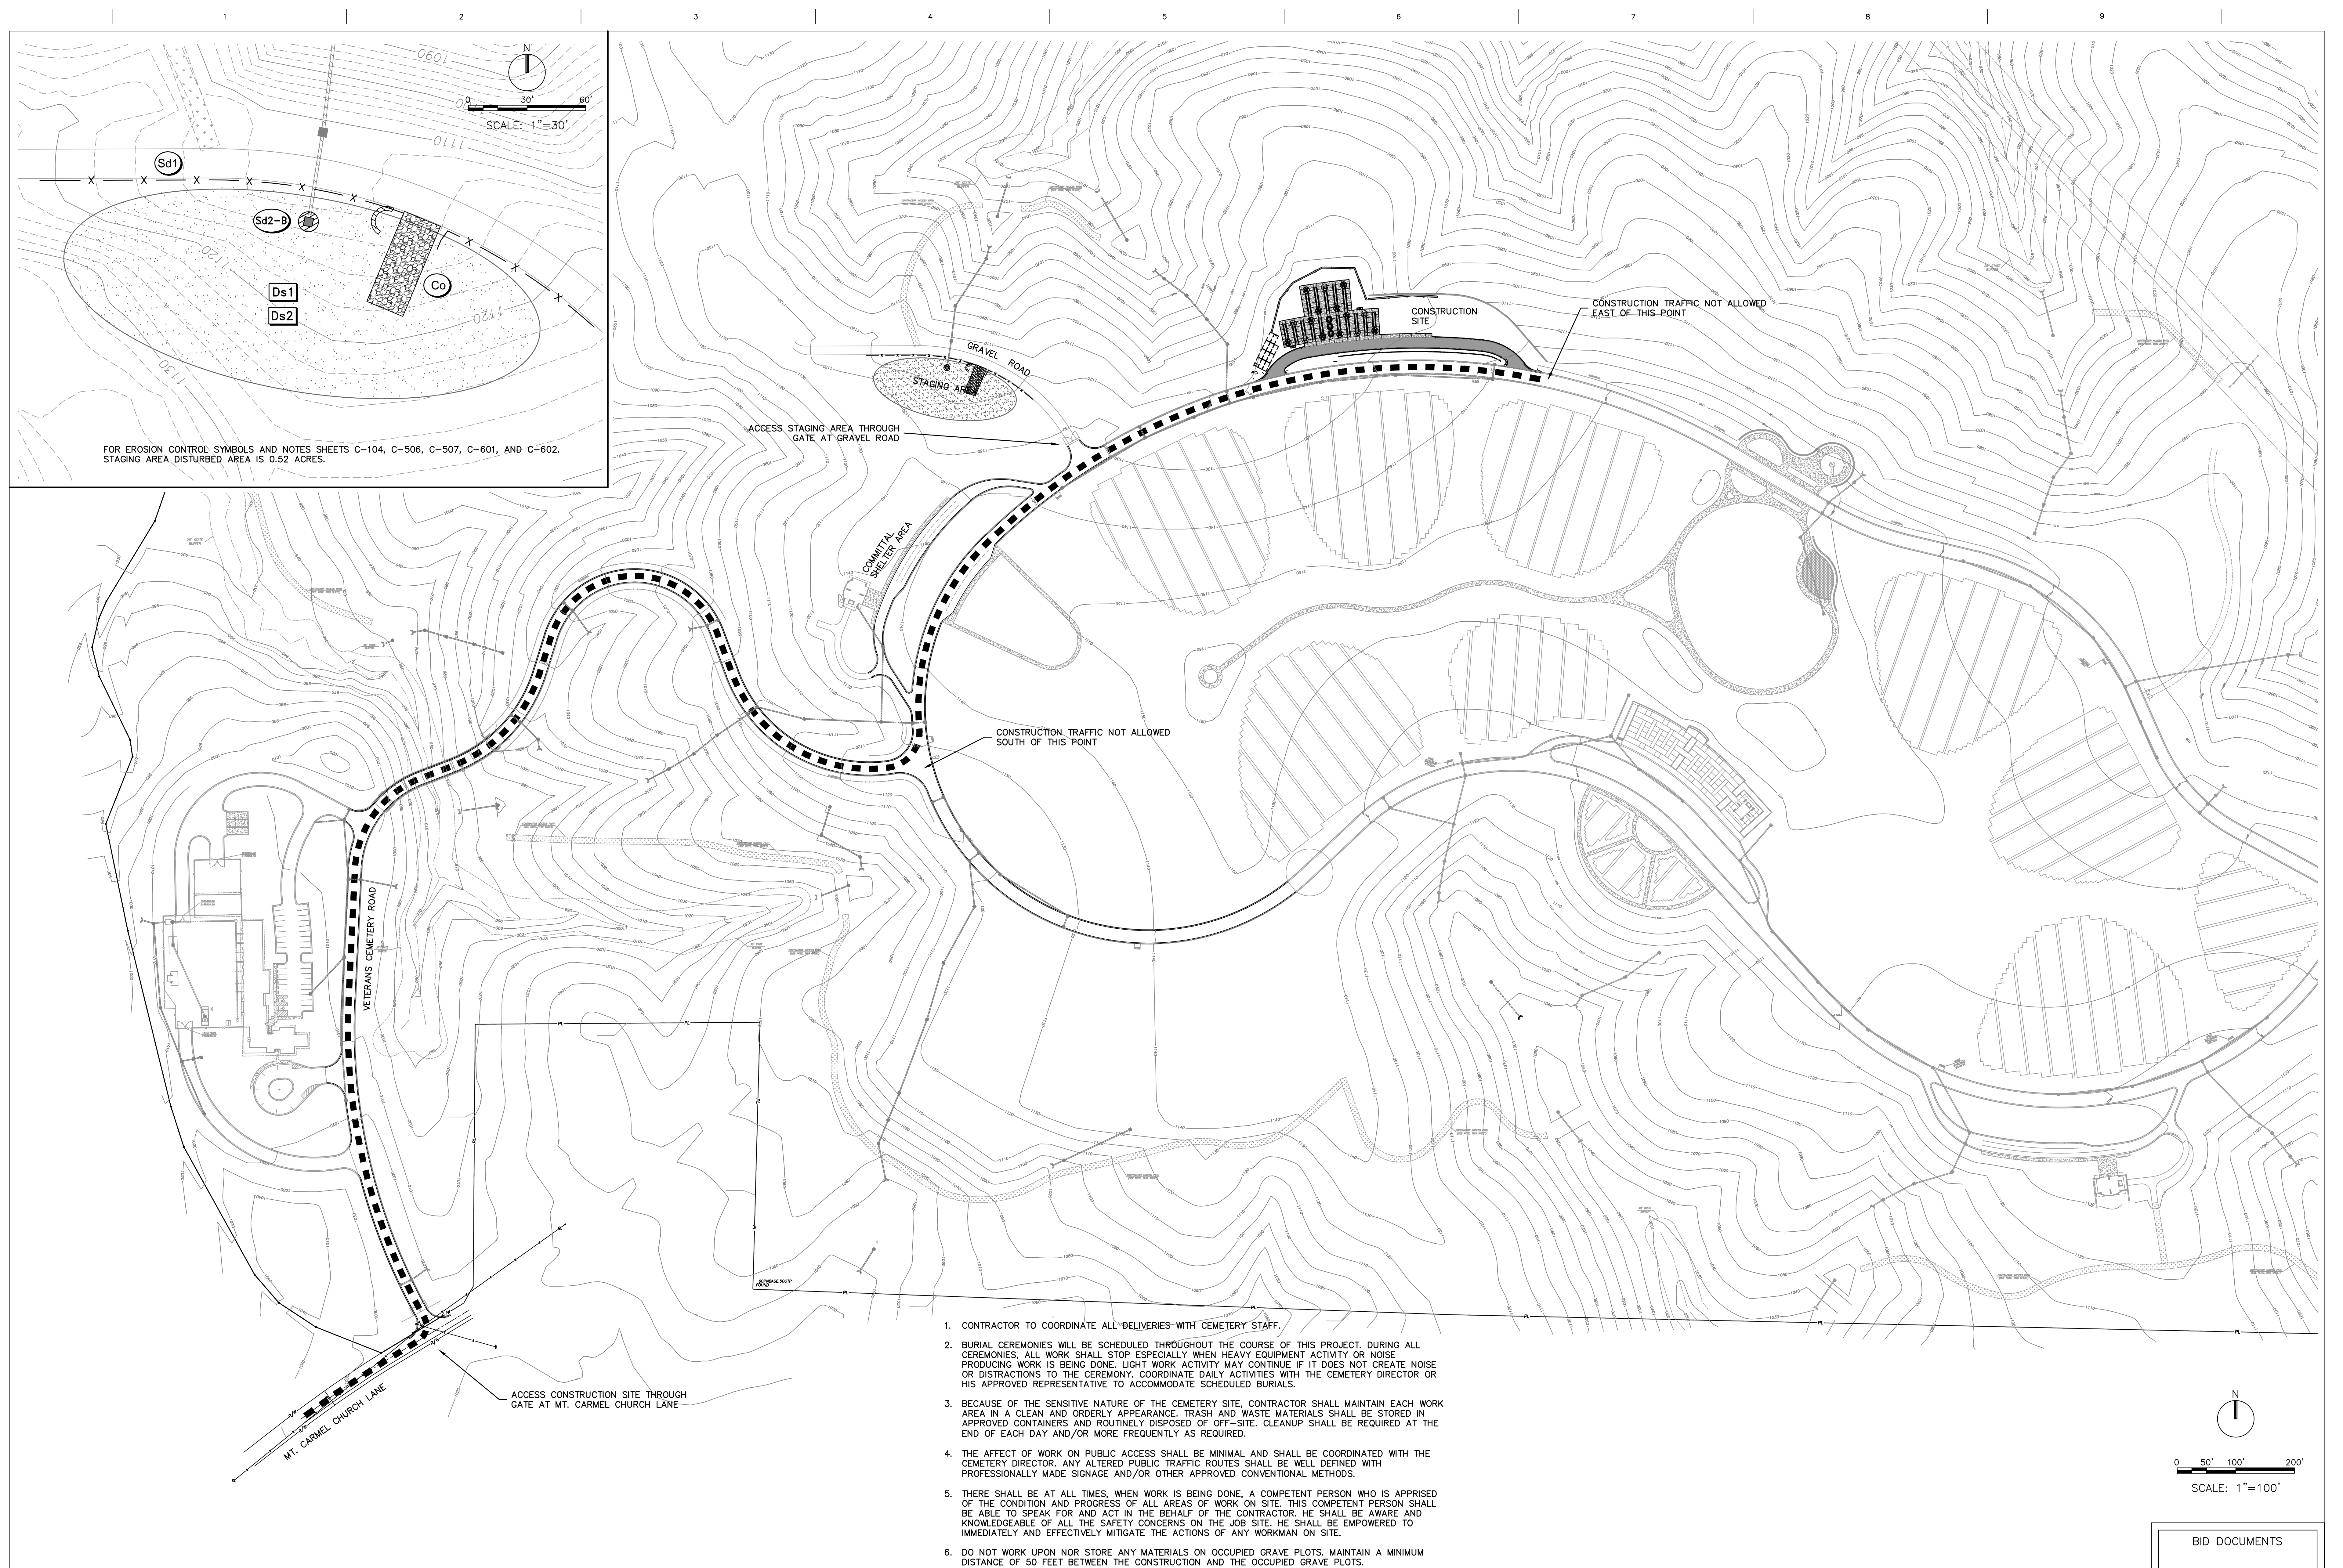

1. CONTRACTOR TO COORDINATE ALL DELIVERIES WITH CEMETERY STAFF.
2. BURIAL CEREMONIES WILL BE SCHEDULED THROUGHOUT THE COURSE OF THIS PROJECT. DURING ALL CEREMONIES, ALL WORK SHALL STOP ESPECIALLY WHEN HEAVY EQUIPMENT ACTIVITY OR NOISE PRODUCING WORK IS BEING DONE. LIGHT WORK ACTIVITY MAY CONTINUE IF IT DOES NOT CREATE NOISE OR DISTRACTIONS. THE CEMETERY DAILY OPERATIONS DIRECTOR WITH THE CEMETERY DIRECTOR OR HIS APPROVED REPRESENTATIVE TO ACCOMMODATE SCHEDULED BURIALS.
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6. DO NOT WORK UPON NOR STORE ANY MATERIALS ON OCCUPIED GRAVE PLOTS. MAINTAIN A MINIMUM DISTANCE OF 50 FEET BETWEEN THE CONSTRUCTION AND THE OCCUPIED GRAVE PLOTS.

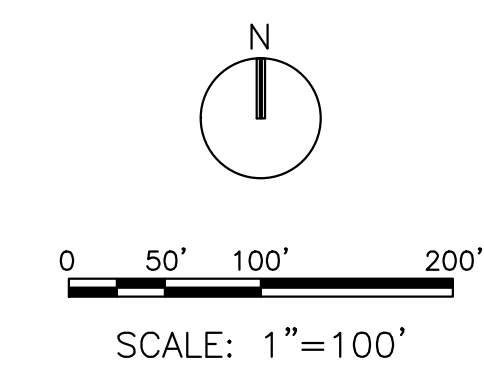


<div>Revisions</div>	<div>Date</div>	<div>PRIME:</div> <div><div><div><div><div></div><div></div><div></div><div></div><div></div><div></div><div></div><div></div></div><div>amec foster wheeler</div></div><div><div>AMEC FOSTER WHEELER ENVIRONMENT & INFRASTRUCTURE 1075 BIG SHANTY ROAD NW, SUITE 100 KENNESAW, GA. 30144 (770) 421-3400 AMEC PROJECT: 6166-15-0011</div></div></div></div>	<div>MEP ENGINEER:</div>	<div><div><div><div><div>GEORGIA</div><div>REGISTERED</div><div>NO. 15966</div><div>PROFESSIONAL</div><div>ENGINEER</div><div>JAMES L. STUDER</div></div></div></div></div>	<div>IRRIGATION DESIGNER:</div> <div><div><div><div><div></div><div></div><div></div><div></div><div></div><div></div><div></div><div></div></div><div>Irrigation Consultant Services 2231 Weatherstone Circle Conyers, GA 30094 (770) 929-0884, fax (770) 760-8025</div></div></div></div>	<div><div><div><div><div></div><div></div><div></div><div></div><div></div><div></div><div></div><div></div></div><div>NATIONAL CEMETERY ADMINISTRATION</div></div></div></div>	<div>Drawing Title</div> <div>CONSTRUCTION ACCESS ROUTE</div> <div>Approved: Director, Technical Support Service</div> <div>Approved: Chief, Architectual & Engineering Division</div>	<div>Project Title</div> <div>4000 NICHE COLUMBARIUM GEORGIA NATIONAL CEMETERY</div> <div><div>Building Number</div><div>Checked</div><div>Drawn</div></div> <div><div>Location</div><div>1080 VETERANS CEMETERY RD, CANTON, GA 30114</div></div>	<div>Date</div> <div>23 OCTOBER 2015</div> <div>Project No.</div> <div>922CM3005</div> <div>DRAWING NO.</div> <div>B-101</div> <div>Sheet 2 Of 31</div>

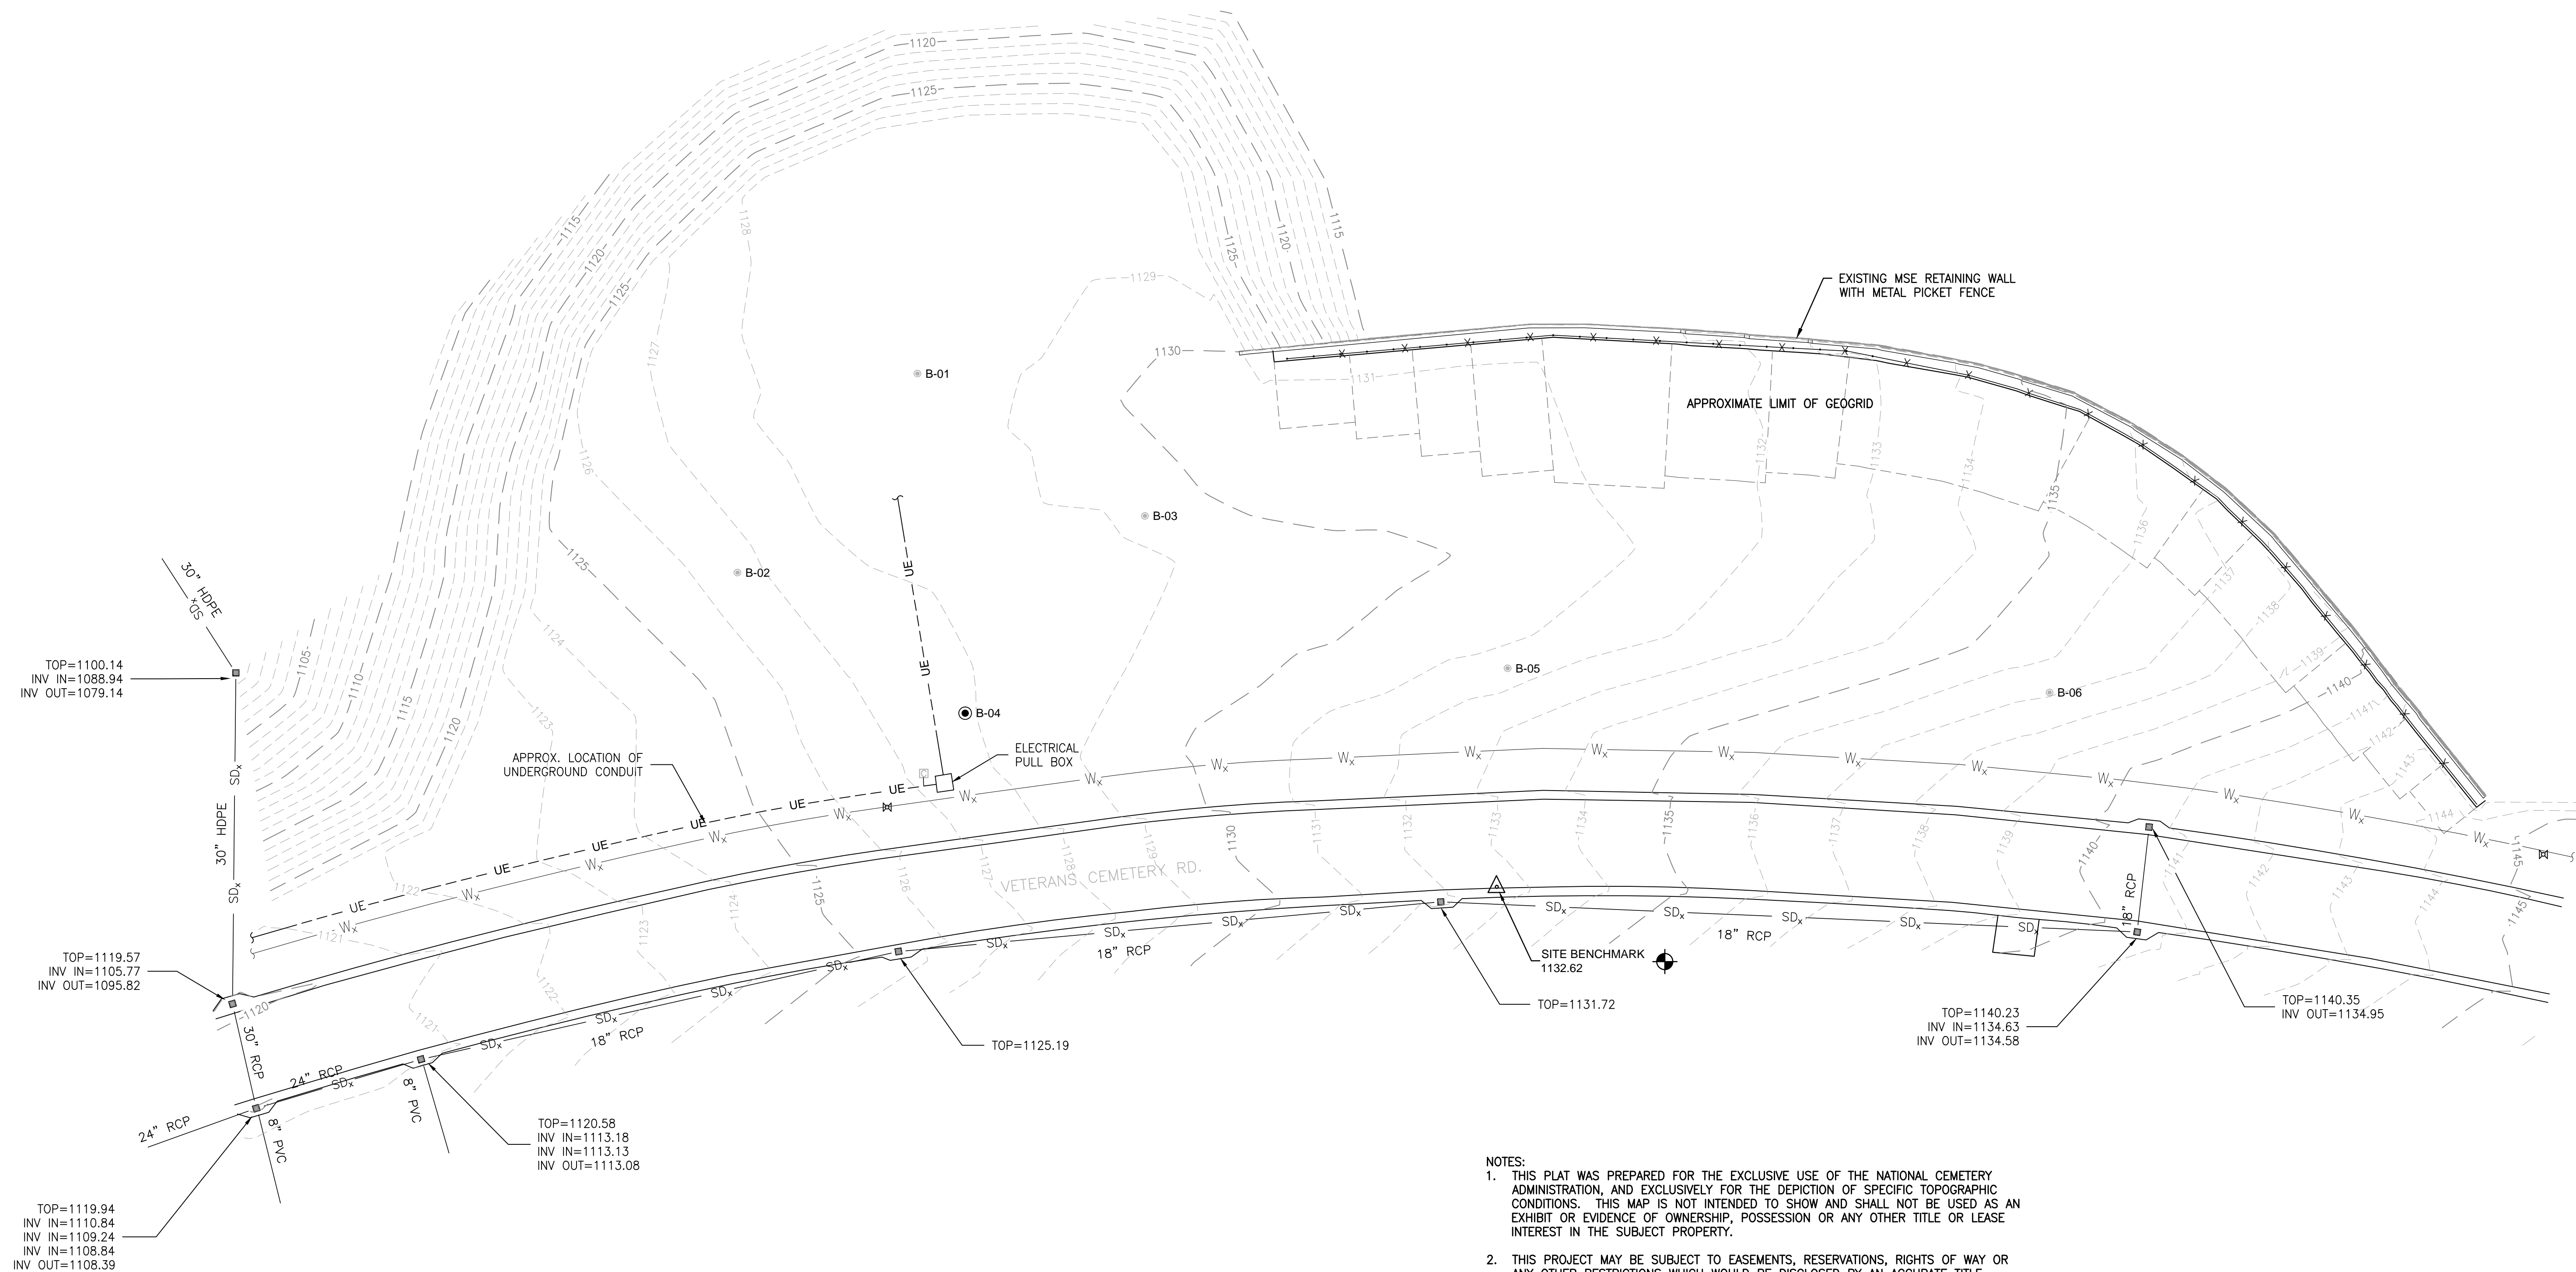

- NOTES:
1. THIS PLAT WAS PREPARED FOR THE EXCLUSIVE USE OF THE NATIONAL CEMETERY ADMINISTRATION, AND EXCLUSIVELY FOR THE DEPICTION OF SPECIFIC TOPOGRAPHIC CONDITIONS. THIS MAP IS NOT INTENDED TO SHOW AND SHALL NOT BE USED AS AN EXHIBIT OR EVIDENCE OF OWNERSHIP, POSSESSION OR ANY OTHER TITLE OR LEASE INTEREST IN THE SUBJECT PROPERTY.
 2. THIS PROJECT MAY BE SUBJECT TO EASEMENTS, RESERVATIONS, RIGHTS OF WAY OR ANY OTHER RESTRICTIONS WHICH WOULD BE DISCLOSED BY AN ACCURATE TITLE SEARCH, AND BOUNDARY SURVEY. THEREFORE EXCEPTION IS TAKEN TO ANY SUCH ITEMS.
 3. THE FIELD DATA UPON WHICH THIS PLAT IS BASED WAS COLLECTED MARCH 12, 2015 USING A TOPCON GPT SERIES TOTAL STATION, AND TOPCON HIPER XT DUAL FREQUENCY GPS RECEIVERS.
 4. THE HORIZONTAL AND VERTICAL DATUM FROM WHICH THIS TOPOGRAPHIC SURVEY WAS PREPARED WAS ESTABLISHED BY GPS STATIC OBSERVATIONS PERFORMED ON MARCH 12, 2015 AND PROCESSED BY THE NATIONAL GEODETIC SURVEY ONLINE POSITIONING USER SERVICE (OPUS) AND IS BASED ON THE NORTH AMERICAN DATUM 83 (NAD 83), AND VERTICAL DATUM IS BASED ON NORTH AMERICAN DATUM 88 (NAVD 88).
 5. THE UTILITIES SHOWN HEREON HAVE BEEN LOCATED FROM ABOVE GROUND, VISIBLE EVIDENCE. THE SURVEYOR MAKES NO GUARANTEE THAT THE UTILITIES SHOWN COMPRISE ALL SUCH UTILITIES IN THE AREA, EITHER IN SERVICE OR ABANDONED. THE SURVEYOR FURTHER DOES NOT WARRANT THAT THE UNDERGROUND UTILITIES SHOWN ARE IN THE EXACT LOCATION INDICATED ALTHOUGH HE DOES CERTIFY THAT THEY ARE LOCATED AS ACCURATELY AS POSSIBLE FROM INFORMATION AVAILABLE. THE SURVEYOR HAS NOT PHYSICALLY LOCATED THE UNDERGROUND UTILITIES.
 6. REFER TO GEOTECHNICAL REPORT FOR BORING INFORMATION TITLED "REPORT OF A GEOTECHNICAL EXPLORATION" DONE BY AMEC FOSTER WHEELER ENVIRONMENT & INFRASTRUCTURE, DATED MARCH 24, 2015.
 7. THE GEOGRID LOCATION AS SHOWN IS BASED UPON THE DOCUMENTS "ATLANTA AREA NATIONAL CEMETERY KEYSTONE CENTURY WALL SYSTEM" PREPARED BY SOIL REINFORCEMENT DESIGN, INC. AND DATED FEB 1, 2005. THE CONTRACTOR IS TO USE EXTREME CARE IN THE CONSTRUCTION OF THIS PROJECT TO INSURE THAT THE STRUCTURAL INTEGRITY OF THE WALL IS MAINTAINED.


LEGEND:

LINE TYPES	
SD _x	STORM SEWER LINE
1140	CONTOUR LINE
x	FENCE
UE	ELECTRICAL CONDUIT
W _x	WATER LINE
SYMBOLS	
●	BORING HOLE
■	STORM CATCH BASIN
⊞	IRRIGATION CONTROL VALVE
□	TELECOMMUNICATION BOX

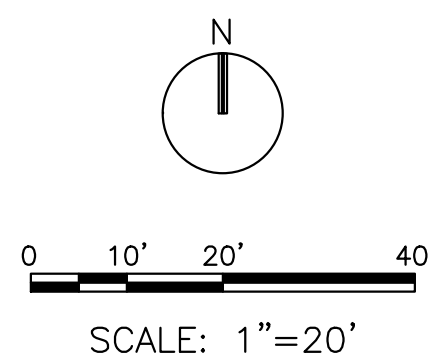

BID DOCUMENTS

Revisions	Date	<div><div><div><div><div></div><div></div><div></div><div></div><div></div><div></div><div></div><div></div><div></div><div></div></div><div>amec foster wheeler</div></div></div><div><div>AMEC FOSTER WHEELER ENVIRONMENT & INFRASTRUCTURE 1075 BIG SHANTY ROAD NW, SUITE 100 KENNESAW, GA. 30144 (770) 421-3400 AMEC PROJECT: 6166-15-0011</div></div></div>	<div>MEP ENGINEER:</div>	<div><div><div>GEORGIA</div><div>REGISTERED</div><div>NO. 18666</div><div>PROFESSIONAL</div><div>ENGINEER</div><div>JAMES L. STUBER</div></div></div>	<div><div><div>IRRIGATION</div><div>Consultant Services</div></div><div>2231 Weatherstone Circle Conyers, GA 30094 (770) 929-0884, fax (770) 760-8025</div></div>	<div><div><div><div>DEPARTMENT OF VETERANS AFFAIRS UNITED STATES OF AMERICA</div><div></div></div></div><div>NATIONAL CEMETERY ADMINISTRATION</div></div>	Drawing Title	Project Title	Date
							EXISTING CONDITIONS	4000 NICHE COLUMBARIUM GEORGIA NATIONAL CEMETERY	23 OCTOBER 2015
							Approved: Director, Technical Support Service	Building Number	Checked
Approved: Chief, Architectual & Engineering Division	Location 1080 VETERANS CEMETERY RD, CANTON, GA 30114		DRAWING NO. B-102		Sheet 3 Of 31				

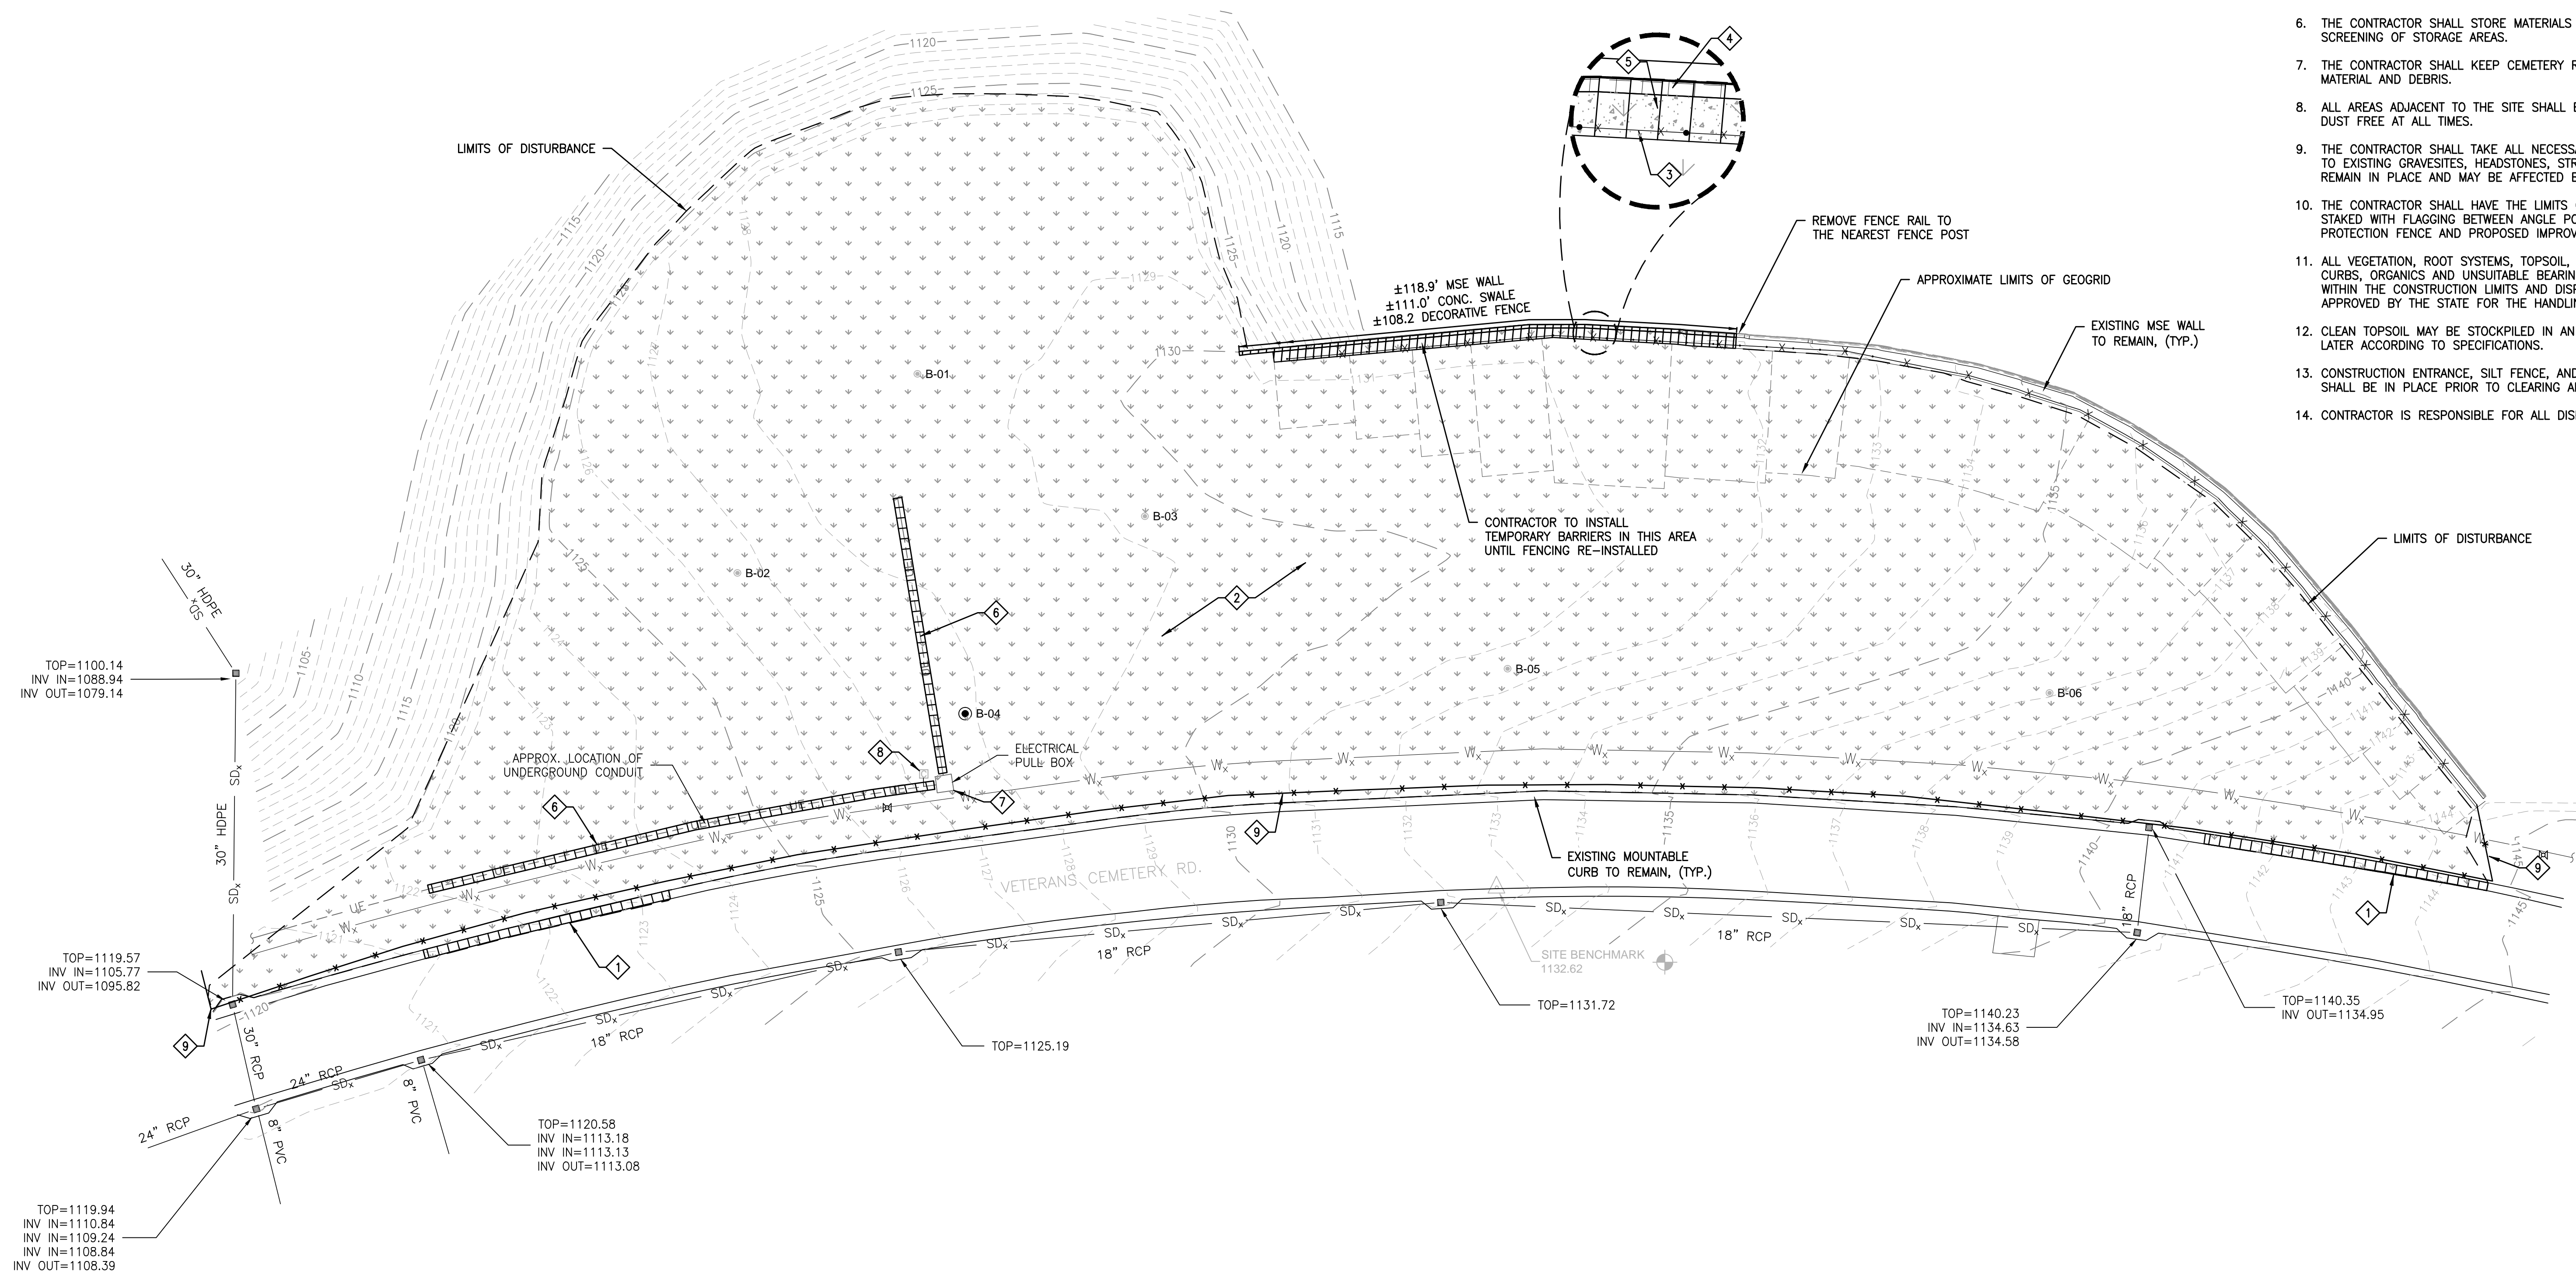


DEMOLITION NOTES:

1. INSTALL AND MAINTAIN PERIMETER SILT BARRIERS IN ACCORDANCE WITH DETAIL. REMOVAL OF SILT BARRIER IS CONTINGENT UPON FINAL APPROVAL FROM THE OWNER.
2. THE CONTRACTOR SHALL COORDINATE WITH THE PROPER LOCAL AUTHORITIES OR RESPECTIVE UTILITY COMPANIES TO LOCATE UNDERGROUND UTILITIES PRIOR TO COMMENCING THE DEMOLITION WORK.
3. THE CONTRACTOR SHALL BE RESPONSIBLE FOR LOCATION, VERIFICATION, SUPPORT, AND PROTECTION OF ALL ABOVEGROUND AND UNDERGROUND UTILITIES TO REMAIN IN PLACE.
4. THE CONTRACTOR WILL COORDINATE WITH THE CEMETERY DIRECTOR DAILY ON THE BURIAL SCHEDULE.
5. THE CONTRACTOR AND SUBCONTRACTOR SHALL NOT PARK OR QUEUE VEHICLES ON CEMETERY ROADS.
6. THE CONTRACTOR SHALL STORE MATERIALS IN AREAS APPROVED BY THE COTR. PROVIDE SCREENING OF STORAGE AREAS.
7. THE CONTRACTOR SHALL KEEP CEMETERY ROADS CLEAN OF ALL CONSTRUCTION RELATED MATERIAL AND DEBRIS.
8. ALL AREAS ADJACENT TO THE SITE SHALL BE MAINTAINED IN A CLEAN CONDITION, MUD AND DUST FREE AT ALL TIMES.
9. THE CONTRACTOR SHALL TAKE ALL NECESSARY PRECAUTIONS TO ENSURE NO DAMAGE OCCURS TO EXISTING GRAVESITES, HEADSTONES, STRUCTURES, TREES AND UTILITIES THAT ARE TO REMAIN IN PLACE AND MAY BE AFFECTED BY CONSTRUCTION OPERATIONS.
10. THE CONTRACTOR SHALL HAVE THE LIMITS OF CLEARING AND DEMOLITION AND ALL BUFFERS STAKED WITH FLAGGING BETWEEN ANGLE POINTS TO ENSURE THE PROPER LOCATION OF TREE PROTECTION FENCE AND PROPOSED IMPROVEMENTS PRIOR TO CLEARING AND DEMOLITION.
11. ALL VEGETATION, ROOT SYSTEMS, TOPSOIL, OTHER DELETERIOUS MATERIAL, EXISTING PAVEMENT, CURBS, ORGANICS AND UNSUITABLE BEARING SOILS SHALL BE STRIPPED FROM THE SURFACE WITHIN THE CONSTRUCTION LIMITS AND DISPOSED OF OFF-SITE TO A DISPOSAL FACILITY APPROVED BY THE STATE FOR THE HANDLING OF CLEARING AND DEMOLITION MATERIALS.
12. CLEAN TOPSOIL MAY BE STOCKPILED IN AN AREA APPROVED BY THE OWNER AND REUSED LATER ACCORDING TO SPECIFICATIONS.
13. CONSTRUCTION ENTRANCE, SILT FENCE, AND ANY OTHER REQUIRED EROSION CONTROL DEVICE SHALL BE IN PLACE PRIOR TO CLEARING AND DEMOLITION OPERATIONS.
14. CONTRACTOR IS RESPONSIBLE FOR ALL DISPOSAL FEES.

KEY NOTES


1. REMOVE EXISTING CURB IN THIS AREA. CONTRACTOR IS RESPONSIBLE FOR PROTECTING EXISTING PAVING AND REPAIRING AT CONTRACTOR'S EXPENSE IF DAMAGED.
2. EXISTING TURF TO BE REMOVED AS NECESSARY FOR PROPOSED CONSTRUCTION. TOPSOIL SHALL BE STOCKPILED AND REUSED.
3. REMOVE AND SALVAGE EXISTING DECORATIVE FENCE AND REINSTALL AFTER CONCRETE SWALE RECONSTRUCTED AND CAP BLOCKS ARE REINSTALLED.
4. REMOVE AND SALVAGE EXISTING RETAINING WALL BLOCKS AND CAP STONES. REINSTALL CAP STONES AFTER RETAINING WALL BLOCKS ARE SET TO NEW ELEVATION.
5. REMOVE EXISTING CONCRETE SWALE.
6. REMOVE EXISTING CONDUIT UP TO NEW LOCATION OF ELECTRICAL PULL BOX.
7. REMOVE AND SALVAGE EXISTING ELECTRICAL PULL BOX. FOR NEW LOCATION SEE SITE PLAN.
8. REMOVE AND SALVAGE EXISTING COMMUNICATION BOX. FOR NEW LOCATION SEE SITE PLAN.
9. CONSTRUCTION FENCE.

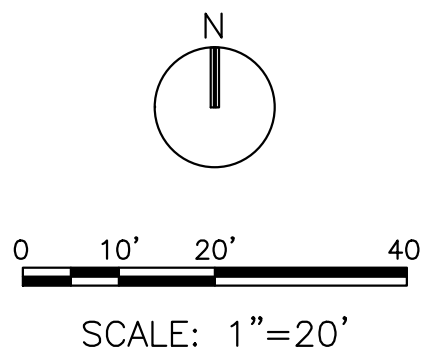


BID DOCUMENTS

		<div><div><div>PRIME:</div><div><div>AMEC FOSTER WHEELER ENVIRONMENT & INFRASTRUCTURE 1075 BIG SHANTY ROAD NW, SUITE 100 KENNESAW, GA. 30144 (770) 421-3400 AMEC PROJECT: 6166-15-0011</div></div></div></div>		<div><div><div>MEP ENGINEER:</div><div></div></div></div>		<div><div><div><div><div>GEORGIA</div><div>REGISTERED PROFESSIONAL ENGINEER</div><div>18866</div><div>James L. Stuber</div></div></div><div>2015</div></div></div>		<div><div><div><div><div>IRRIGATION DESIGNER:</div><div><div>2231 Weatherstone Circle Conyers, GA 30094 (770) 929-0884, fax (770) 760-8025</div></div></div></div></div></div>		<div><div><div><div><div>UNITED STATES OF AMERICA</div><div>DEPARTMENT OF VETERANS AFFAIRS</div><div>OFFICE OF THE ARCHITECT</div><div>WASHINGTON, D.C. 20334</div></div></div><div><div>NATIONAL CEMETERY ADMINISTRATION</div></div></div></div>		<div><div><div><div><div>Drawing Title</div><div>DEMOLITION PLAN</div></div></div></div></div>		<div><div><div><div><div>Project Title</div><div>4000 NICHE COLUMBARIUM GEORGIA NATIONAL CEMETERY</div></div></div></div></div>		<div><div><div><div><div>Date</div><div>23 OCTOBER 2015</div></div></div></div></div>	
										<div><div><div><div><div>Approved: Director, Technical Support Service</div></div></div></div></div>		<div><div><div><div><div>Building Number</div><div>922CM3005</div></div></div></div></div>		<div><div><div><div><div>Checked</div><div></div></div><div><div>Drawn</div><div></div></div></div></div></div>		<div><div><div><div><div>DRAWING NO.</div><div>D-101</div></div></div></div></div>	
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<div><div><div>Revisions</div></div></div>		<div><div><div>Date</div></div></div>															

	<p>PRIME:</p>  <p>AMEC FOSTER WHEELER ENVIRONMENT & INFRASTRUCTURE 1075 BIG SHANTY ROAD NW, SUITE 100 KENNESAW, GA. 30144 (770) 421-3400 AMEC PROJECT: 6166-15-0011</p>	<p>MEP ENGINEER:</p>		<p>IRRIGATION DESIGNER:</p>  <p>2231 Weatherstone Circle Conyers, GA 30094 (770) 929-0884, fax (770) 760-8025</p>	 <p>NATIONAL CEMETERY ADMINISTRATION</p>	<p>Drawing Title</p> <p>SITE PLAN</p> <p>Approved: Director, Technical Support Service</p> <p>Approved: Chief, Architectural & Engineering Division</p>	<p>Project Title</p> <p>4000 NICHE COLUMBARIUM GEORGIA NATIONAL CEMETERY</p> <p>Building Number</p> <p>Checked</p> <p>Drawn</p> <p>Location</p> <p>1080 VETERANS CEMETERY RD, CANTON, GA 30114</p>	<p>Date</p> <p>23 OCTOBER 2015</p> <p>Project No.</p> <p>922CM3005</p> <p>DRAWING NO.</p> <p>C-101</p> <p>Sheet 5 of 31</p>
	Revisions	Date						

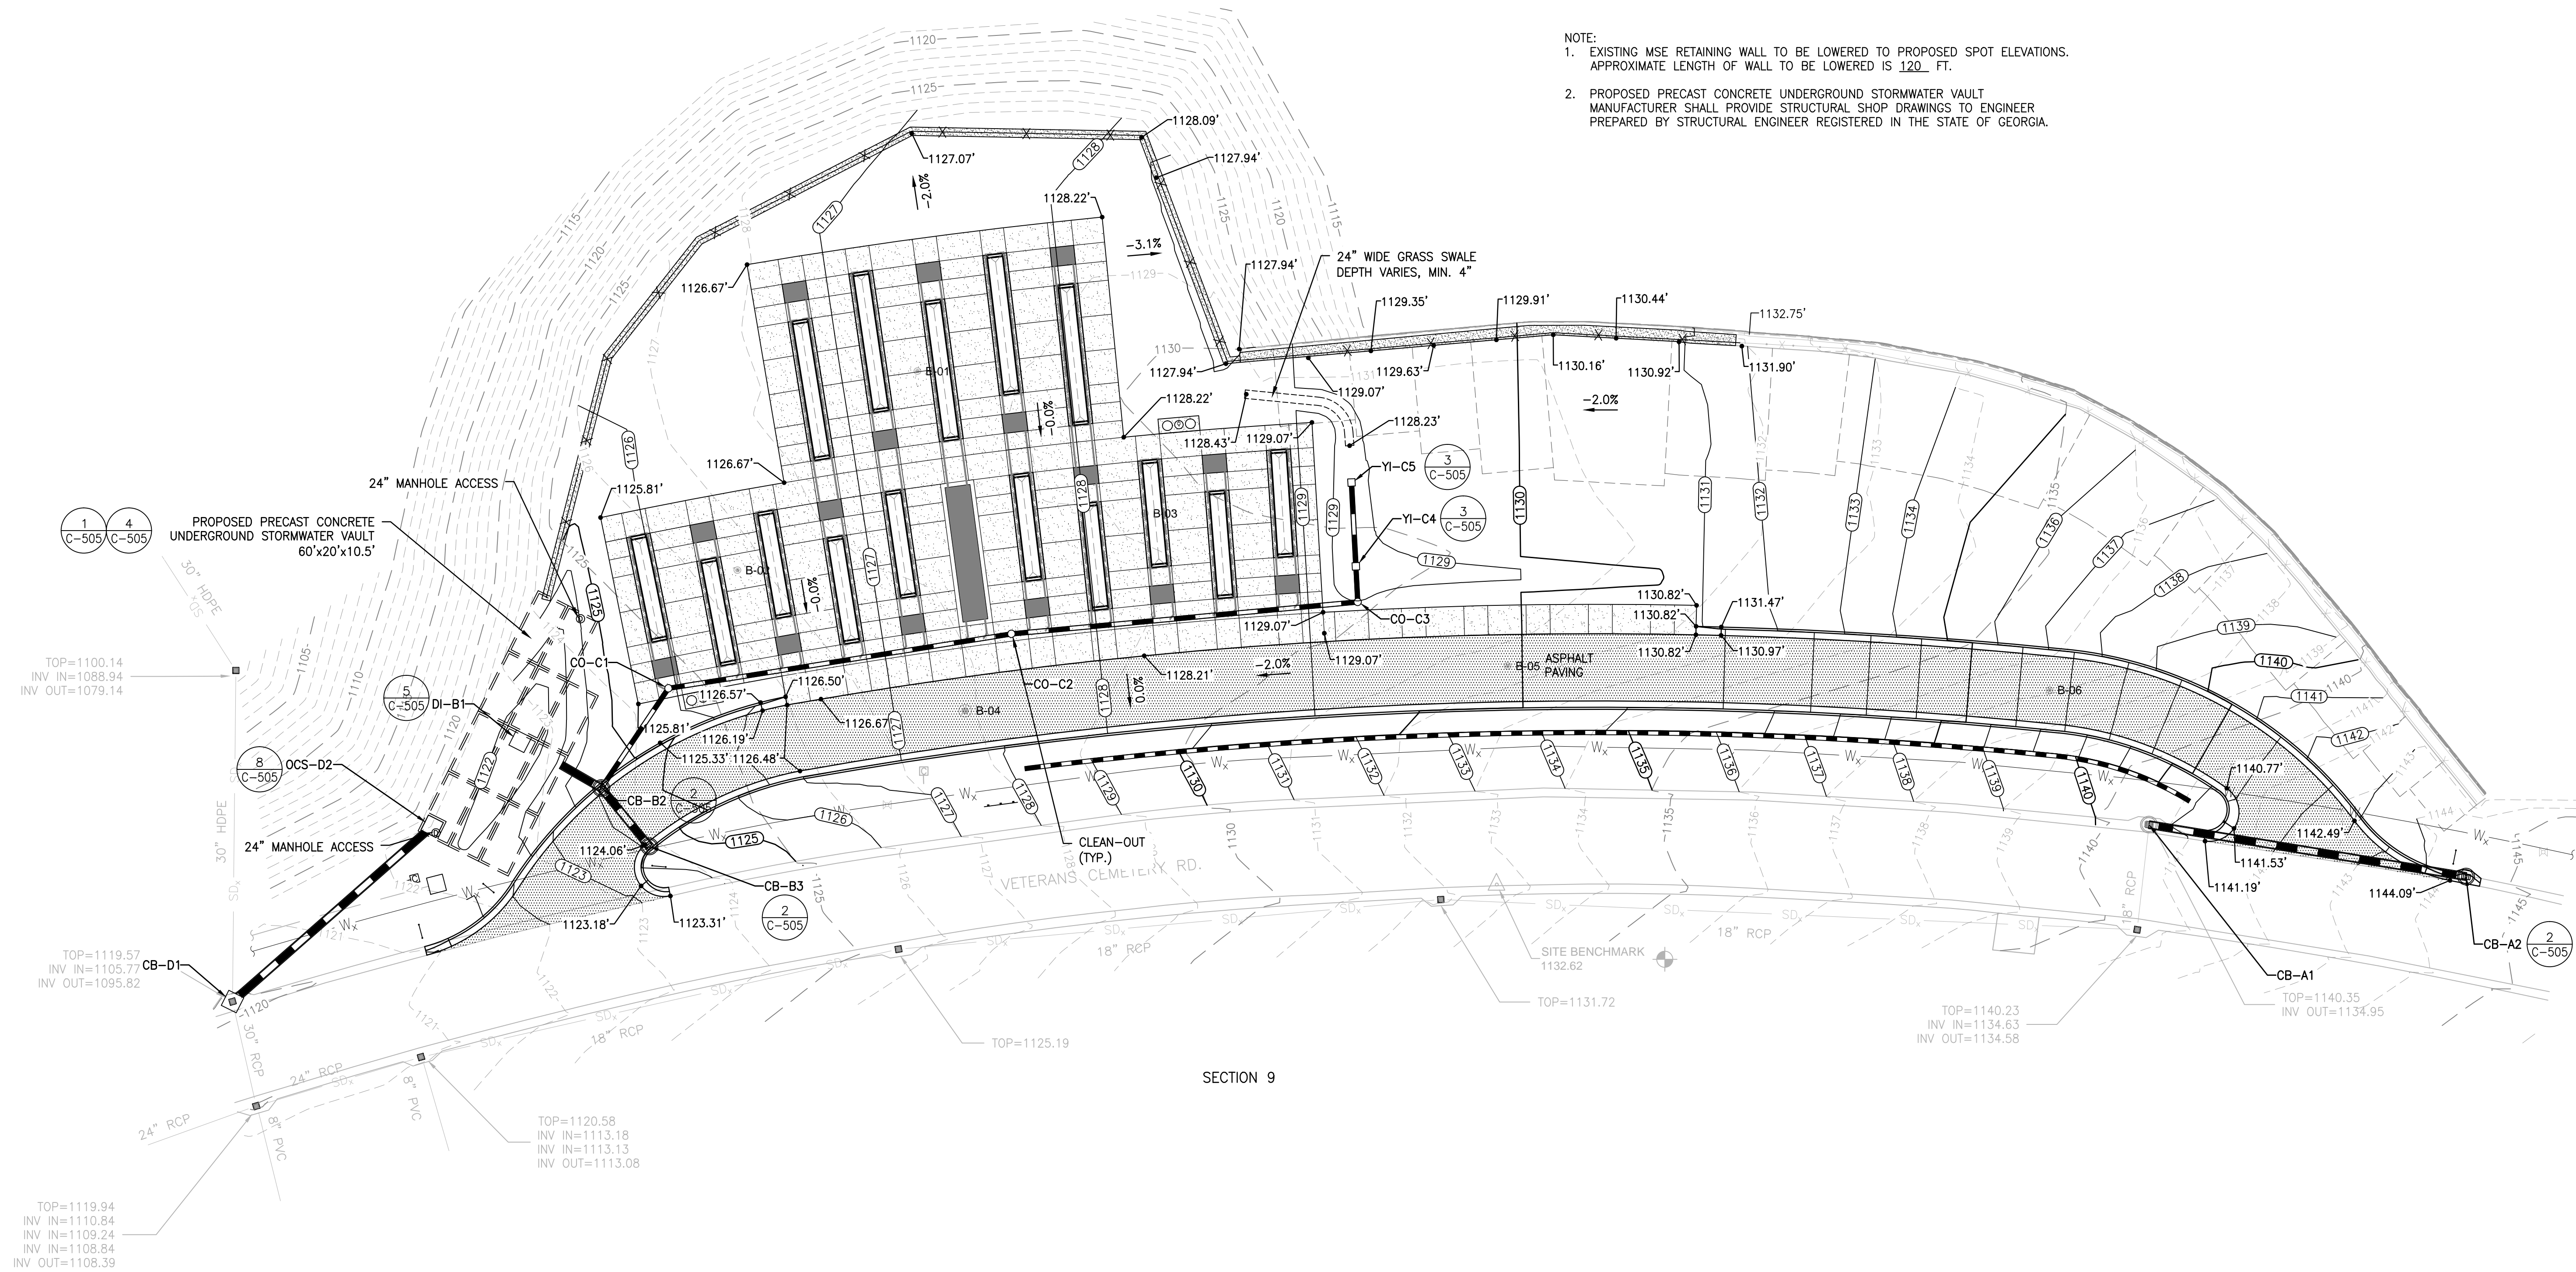


- NOTE:
- EXISTING MSE RETAINING WALL TO BE LOWERED TO PROPOSED SPOT ELEVATIONS. APPROXIMATE LENGTH OF WALL TO BE LOWERED IS 120 FT.
 - PROPOSED PRECAST CONCRETE UNDERGROUND STORMWATER VAULT. MANUFACTURER SHALL PROVIDE STRUCTURAL SHOP DRAWINGS TO ENGINEER PREPARED BY STRUCTURAL ENGINEER REGISTERED IN THE STATE OF GEORGIA.

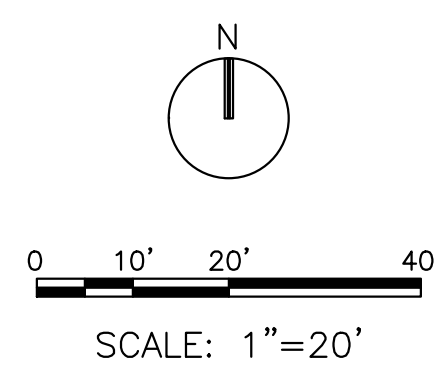


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<div>Revisions</div> <div>Date</div>	<div>PRIME:</div> <div><div>AMEC FOSTER WHEELER ENVIRONMENT & INFRASTRUCTURE 1075 BIG SHANTY ROAD NW, SUITE 100 KENNESAW, GA, 30144 (770) 421-3400 AMEC PROJECT: 6166-15-0011</div></div>	<div>MEP ENGINEER:</div>	<div></div>	<div>IRRIGATION DESIGNER:</div> <div><div>2231 Weatherstone Circle Conyers, GA 30094 (770) 929-0884, fax (770) 760-8025</div></div>	<div><div>NATIONAL CEMETERY ADMINISTRATION</div></div>	<div>Drawing Title</div> <div>GRADING AND DRAINAGE PLAN</div> <div>Approved: Director, Technical Support Service</div> <div>Approved: Chief, Architectural & Engineering Division</div>	<div>Project Title</div> <div>4000 NICHE COLUMBARIUM GEORGIA NATIONAL CEMETERY</div> <div>Building Number</div> <div>Checked</div> <div>Drawn</div> <div>Location</div> <div>1080 VETERANS CEMETERY RD, CANTON, GA 30114</div>	<div>Date</div> <div>23 OCTOBER 2015</div> <div>Project No.</div> <div>922CM3005</div> <div>DRAWING NO.</div> <div>C-102</div> <div>Sheet 6 Of 31</div>
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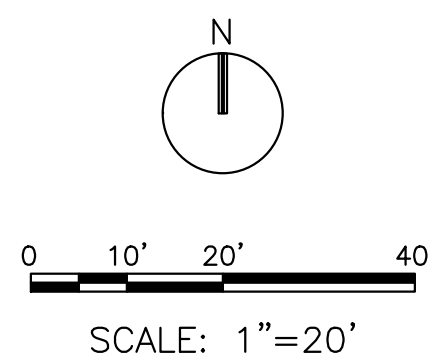


DISTURBED AREA = 0.27 AC

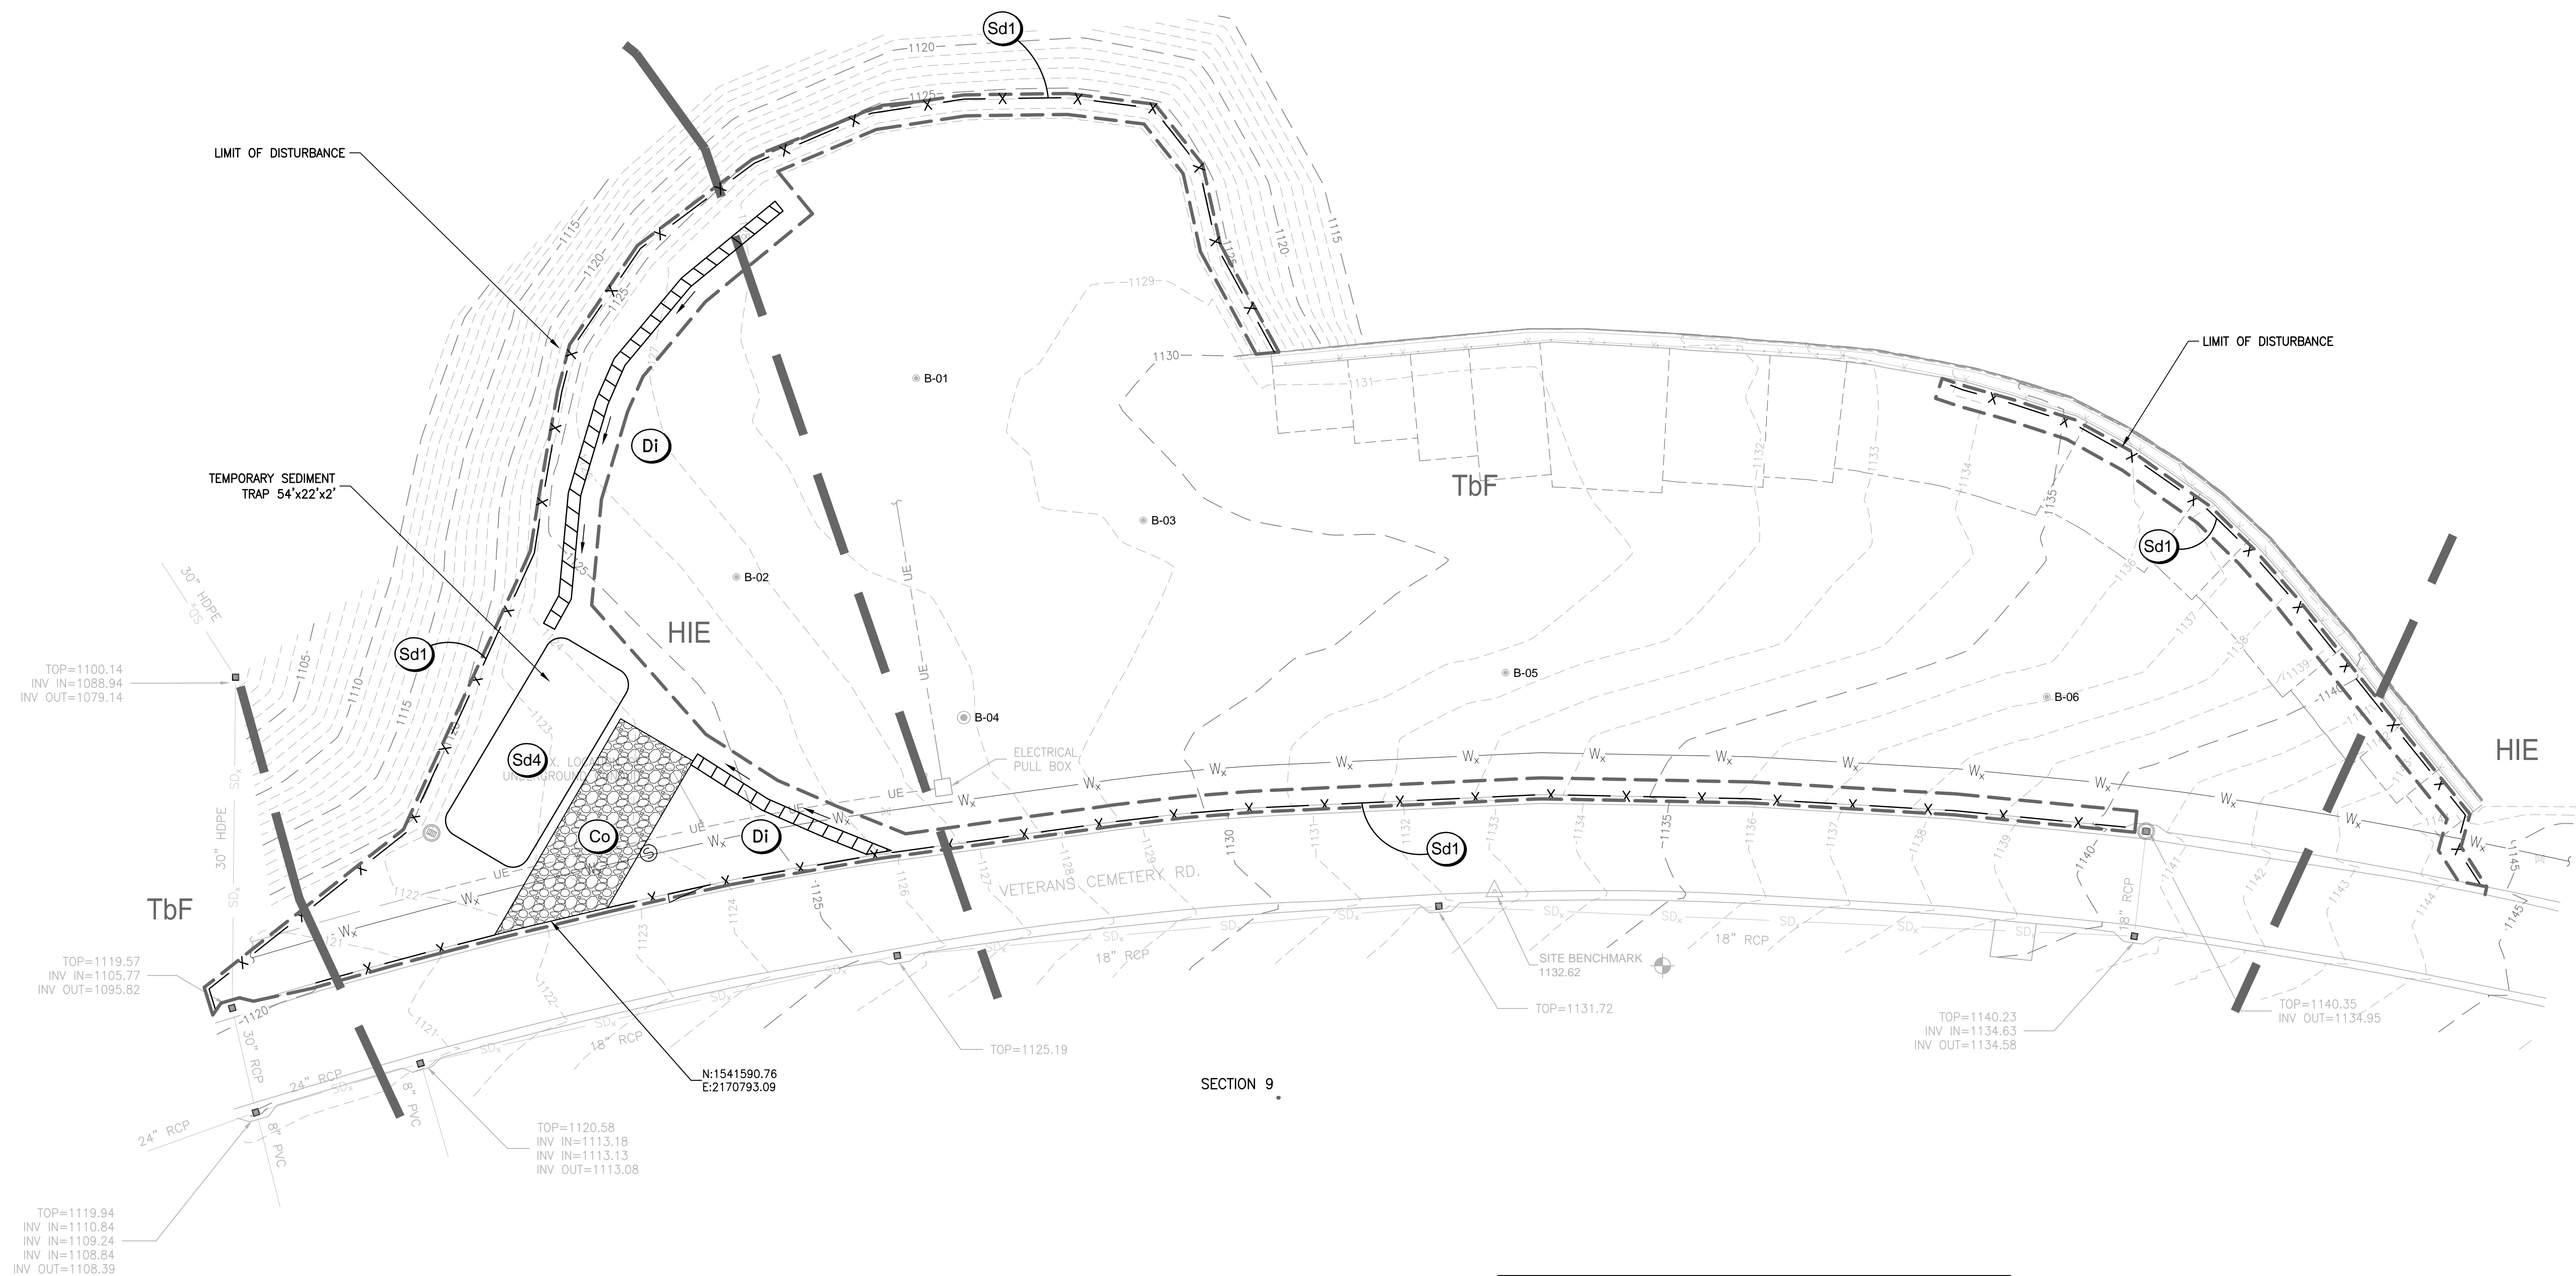


CODE	PRACTICE	MAP SYMBOL	DESCRIPTION
Co	CONSTRUCTION EXIT		A CRUSHED STONE PAD LOCATED AT THE CONSTRUCTION SITE EXIT TO PROVIDE A PLACE FOR REMOVING MUD FROM TIRES THEREBY PROTECTING PUBLIC STREETS.
Di	DIVERSION		AN EARTH CHANNEL OR DIKE LOCATED ABOVE, BELOW OR ACROSS A SLOPE TO DIVERT RUNOFF. THIS MAY BE A TEMPORARY OR PERMANENT STRUCTURE.
Sd1	SEDIMENT BARRIER		A BARRIER TO PREVENT SEDIMENT FROM LEAVING THE CONSTRUCTION SITE. IT MAY BE SANDBAGS, BALES OF STRAW OR HAY, BRUSH, LOGS AND POLES, GRAVEL, OR A SEDIMENT FENCE. THE BARRIERS ARE USUALLY TEMPORARY.
Sd4	TEMPORARY SEDIMENT TRAP		A SMALL TEMPORARY POND THAT DRAINS A DISTURBED AREA SO THAT SEDIMENT CAN SETTLE OUT. THE PRINCIPLE FEATURE DISTINGUISHING A TEMPORARY SEDIMENT TRAP FROM A TEMPORARY SEDIMENT BASIN IS THE LACK OF A PIPE OR RISER.

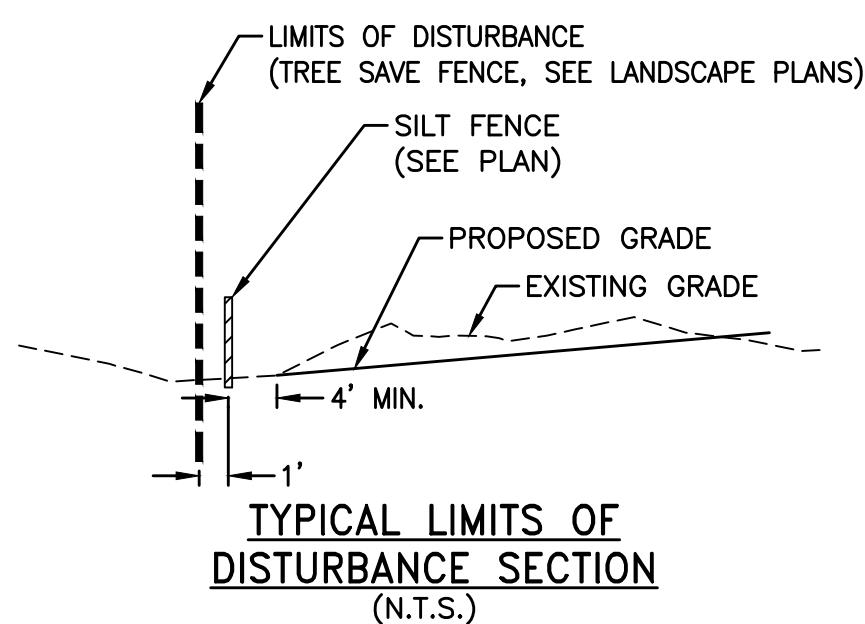SOILS LEGEND	
MAP UNIT SYMBOL	MAP UNIT NAME
HIE	HAYESVILLE FINE SANDY LOAM, 10 TO 25 PERCENT SLOPES
TbF	TALLAPOOSA COBBLY SANDY LOAM, 25 TO 60 PERCENT SLOPES




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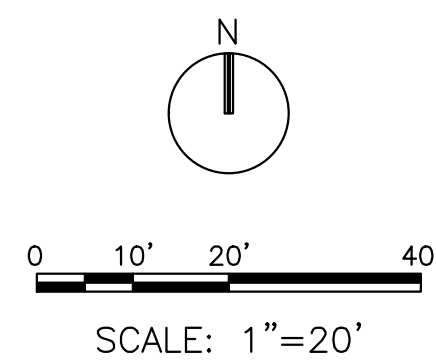
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		 AMEC FOSTER WHEELER ENVIRONMENT & INFRASTRUCTURE 1075 BIG SHANTY ROAD NW, SUITE 100 KENNESAW, GA. 30144 (770) 421-3400 AMEC PROJECT: 6166-15-0011				 Irrigation Consultant Services 2231 Weatherstone Circle Conyers, GA 30094 (770) 929-0884, fax (770) 760-8025	INITIAL EROSION & SEDIMENT CONTROL PLAN	4000 NICHE COLUMBARIUM GEORGIA NATIONAL CEMETERY	23 OCTOBER 2015
		Approved: Chief, Architectural & Engineering Division	Location 1080 VETERANS CEMETERY RD, CANTON, GA 30114	DRAWING NO. C-103					
				Sheet 7 of 31					

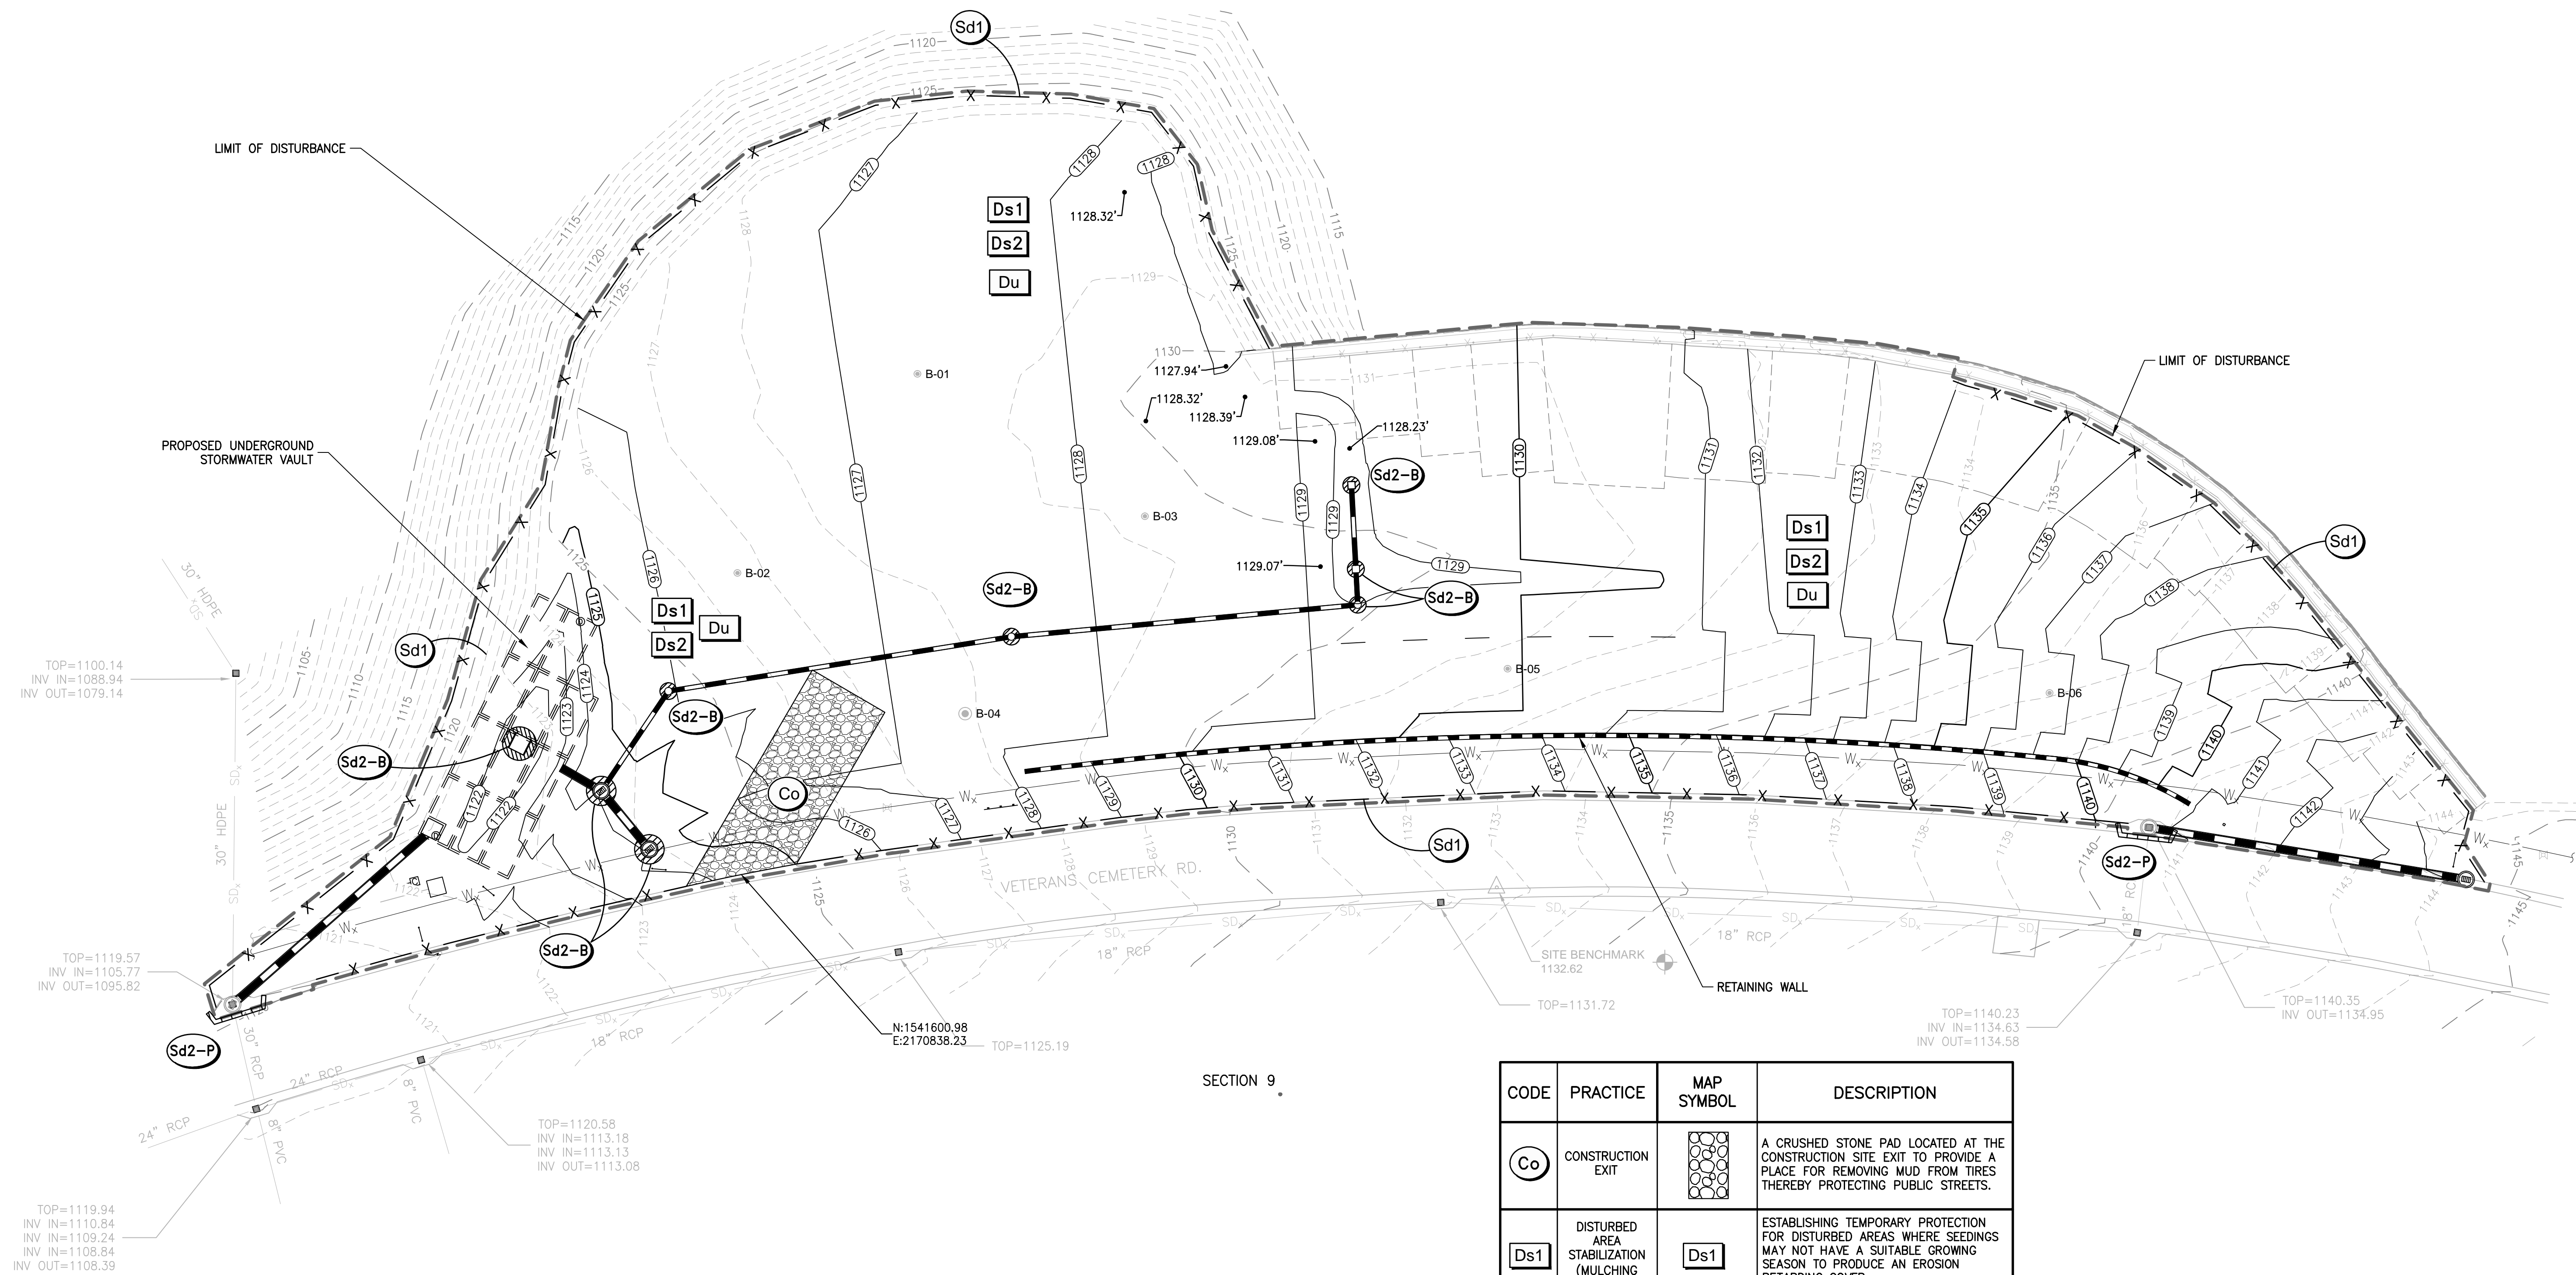

DISTURBED AREA = 1.36 AC

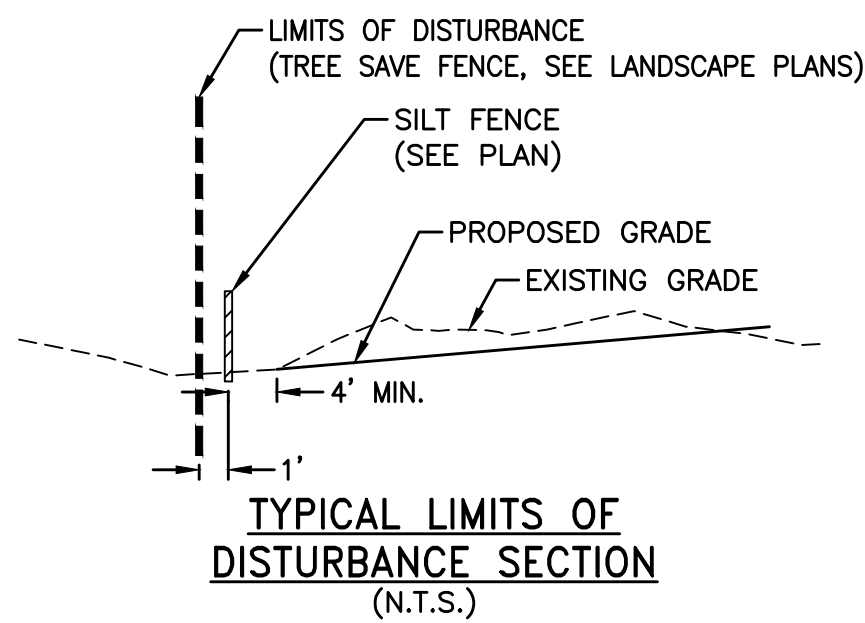


CODE	PRACTICE	MAP SYMBOL	DESCRIPTION
Co	CONSTRUCTION EXIT		A CRUSHED STONE PAD LOCATED AT THE CONSTRUCTION SITE EXIT TO PROVIDE A PLACE FOR REMOVING MUD FROM TIRES THEREBY PROTECTING PUBLIC STREETS.
Ds1	DISTURBED AREA STABILIZATION (MULCHING ONLY)		ESTABLISHING TEMPORARY PROTECTION FOR DISTURBED AREAS WHERE SEEDINGS MAY NOT HAVE A SUITABLE GROWING SEASON TO PRODUCE AN EROSION RETARDING COVER.
Ds2	DISTURBED AREA STABILIZATION (WITH TEMPORARY SEEDING)		ESTABLISHING A TEMPORARY VEGETATIVE COVER WITH FAST GROWING SEEDINGS ON DISTURBED AREAS.
Du	DUST CONTROL ON DISTURBED AREAS		CONTROLLING SURFACE AND AIR MOVEMENT OF DUST ON CONSTRUCTION SITES, ROADWAYS AND SIMILAR SITES.
Sd1	SEDIMENT BARRIER		A BARRIER TO PREVENT SEDIMENT FROM LEAVING THE CONSTRUCTION SITE. IT MAY BE SANDBAGS, BALES OF STRAW OR HAY, BRUSH, LOGS AND POLES, GRAVEL, OR A SEDIMENT FENCE. THE BARRIERS ARE USUALLY TEMPORARY.
Sd2-B	BUFFLE BOX TEMPORARY INLET PROTECTION		2"x4" BOARDS SPACED A MAXIMUM 1" APART OR PLYWOOD WITH WEEP HOLES 2" DIAM. AT 6" ON CENTER VERTICALLY & HORIZONTALLY. PLACE GRAVEL OUTSIDE BOX TO A DEPTH OF 2" TO 4". WRAP BOX IN FILTER FABRIC & ENTRENCH 12".
Sd2-P	CURB INLET FILTER (PIGS-IN-A-BLANKET)		WRAP 8 INCH CONCRETE BLOCKS OR #4 STONE IN FILTER FABRIC AND SPAN ACROSS CATCH BASIN INLET.




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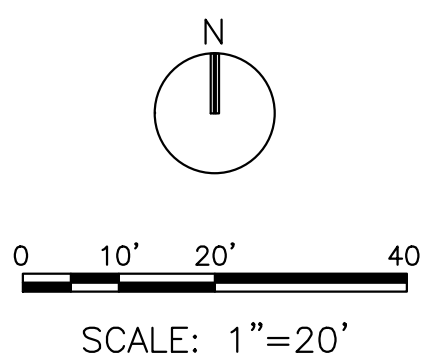
Revisions	Date	PRIME:	MEP ENGINEER:	IRRIGATION DESIGNER:	 NATIONAL CEMETERY ADMINISTRATION	Drawing Title	Project Title	Date	
		 AMEC FOSTER WHEELER ENVIRONMENT & INFRASTRUCTURE 1075 BIG SHANTY ROAD NW, SUITE 100 KENNESAW, GA. 30144 (770) 421-3400 AMEC PROJECT: 6166-15-0011		 James L. Studer Level II Certified Design Professional CERTIFICATION NUMBER 0000007223 ISSUED: 03/17/2015 EXPIRES: 03/17/2018		Irrigation Consultant Services 2231 Weatherstone Circle Conyers, GA 30094 (770) 929-0884, fax (770) 760-8025	INTERMEDIATE EROSION & SEDIMENT CONTROL PLAN	4000 NICHE COLUMBARIUM GEORGIA NATIONAL CEMETERY	23 OCTOBER 2015
							Approved: Director, Technical Support Service	Building Number	Checked
						Approved: Chief, Architectural & Engineering Division	Location 1080 VETERANS CEMETERY RD, CANTON, GA 30114	DRAWING NO. C-104 Sheet 8 of 31	

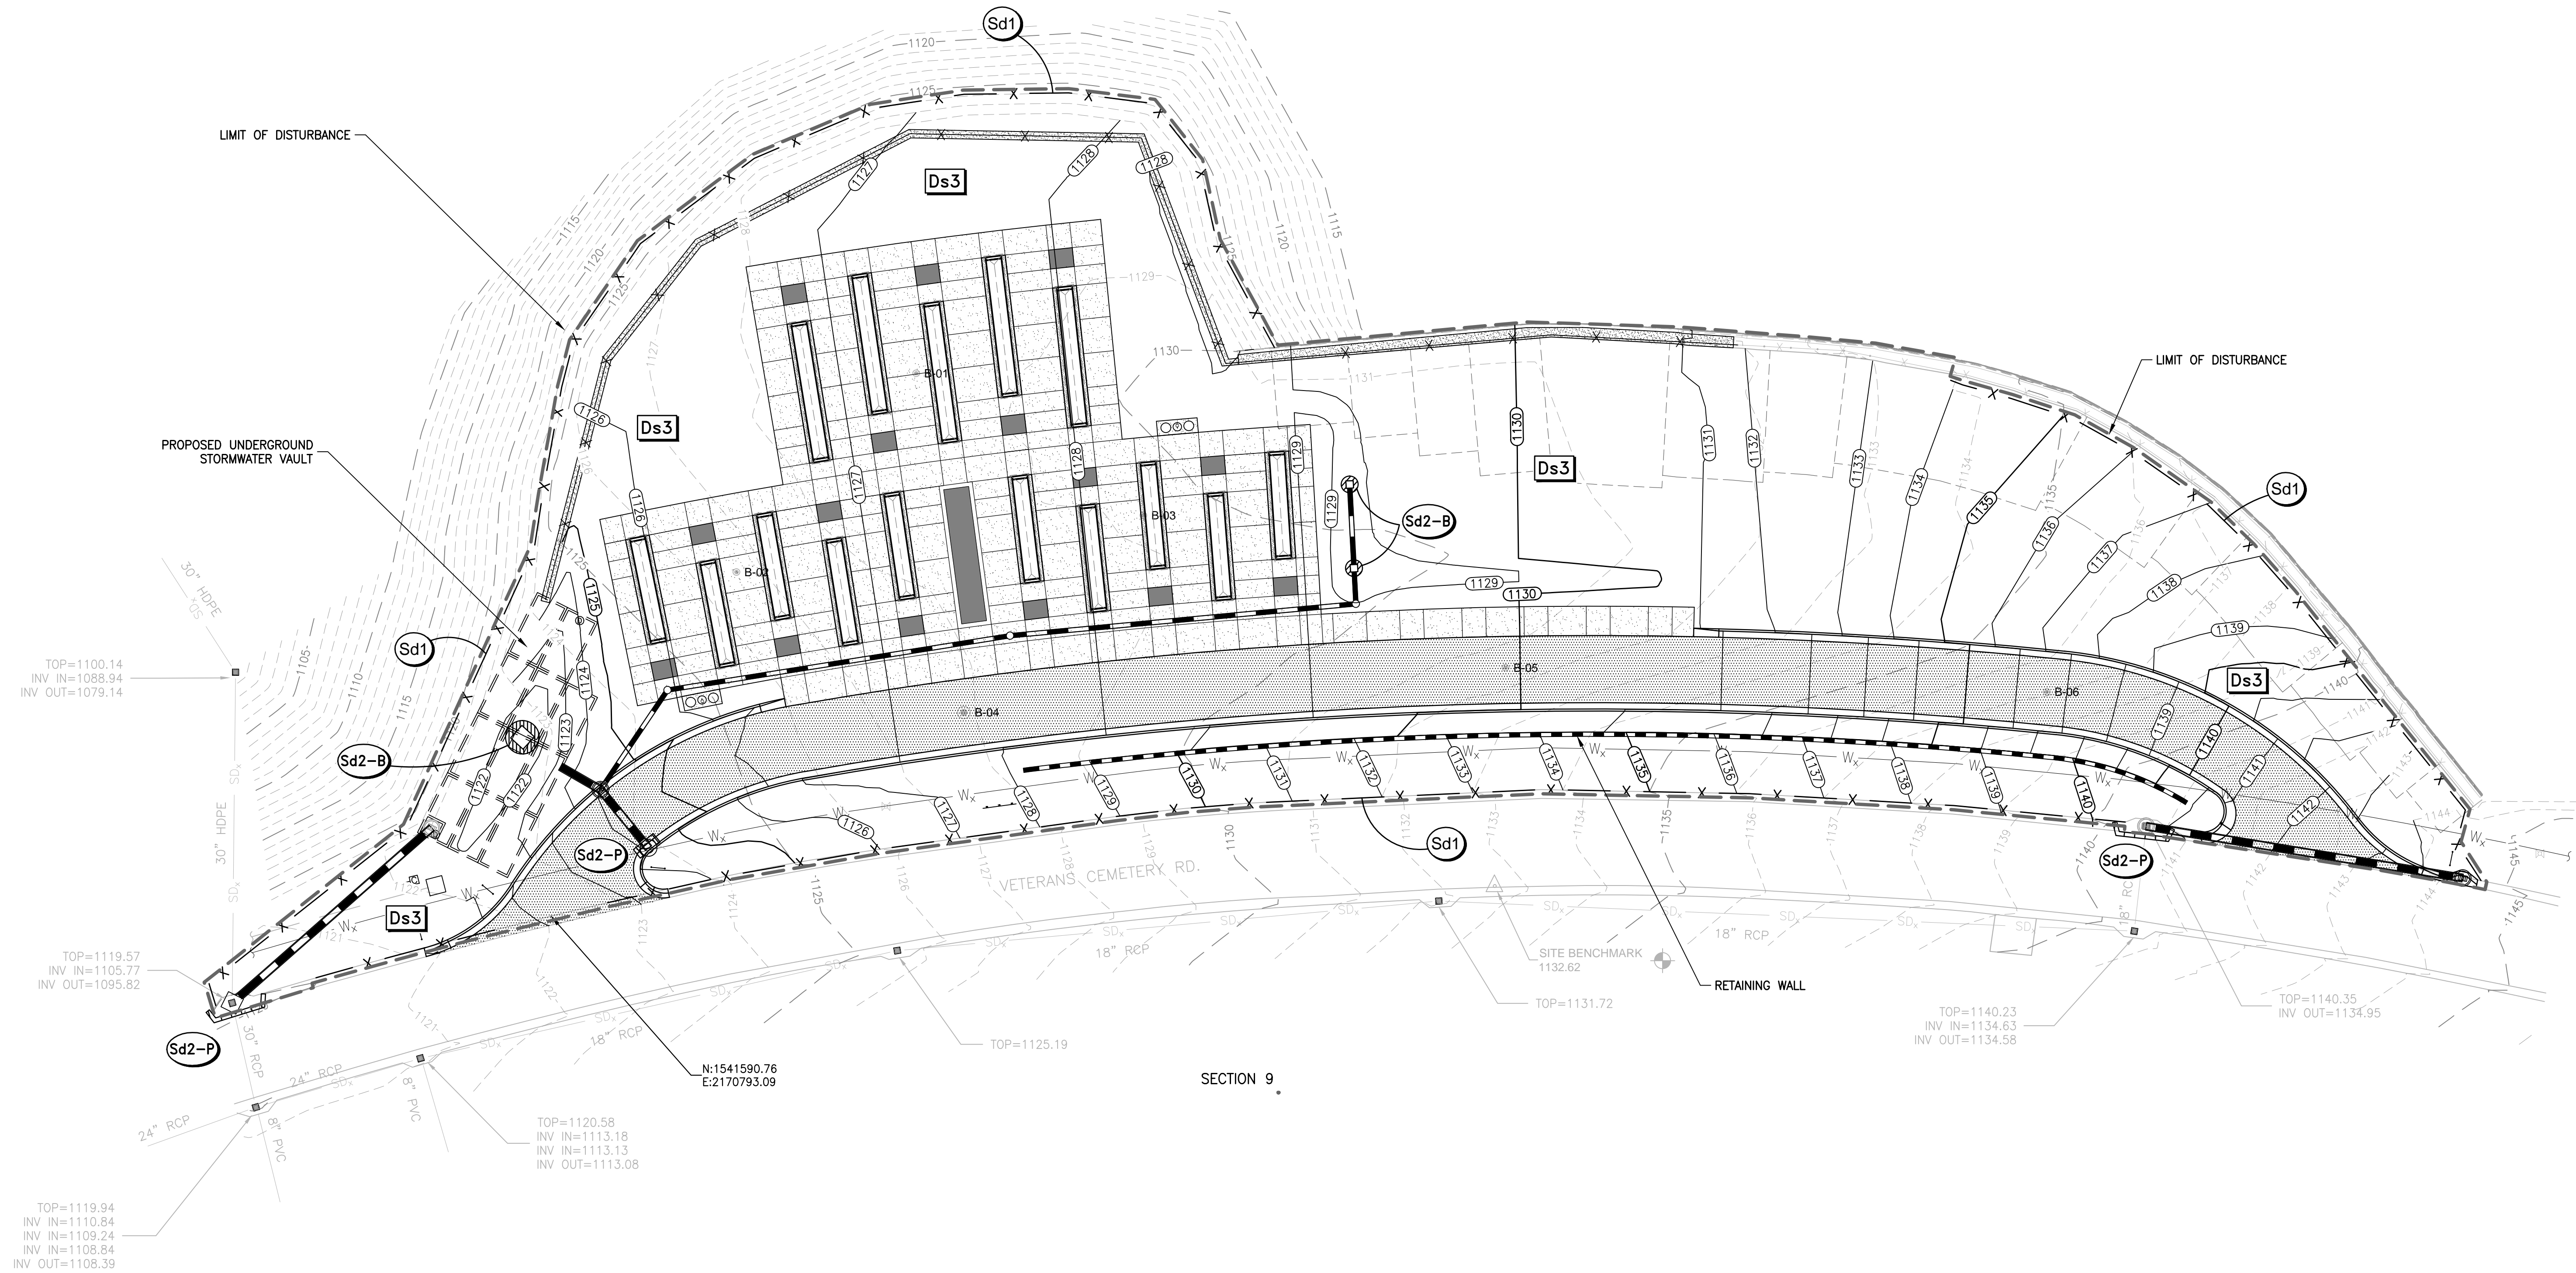

DISTURBED AREA = 1.35 AC

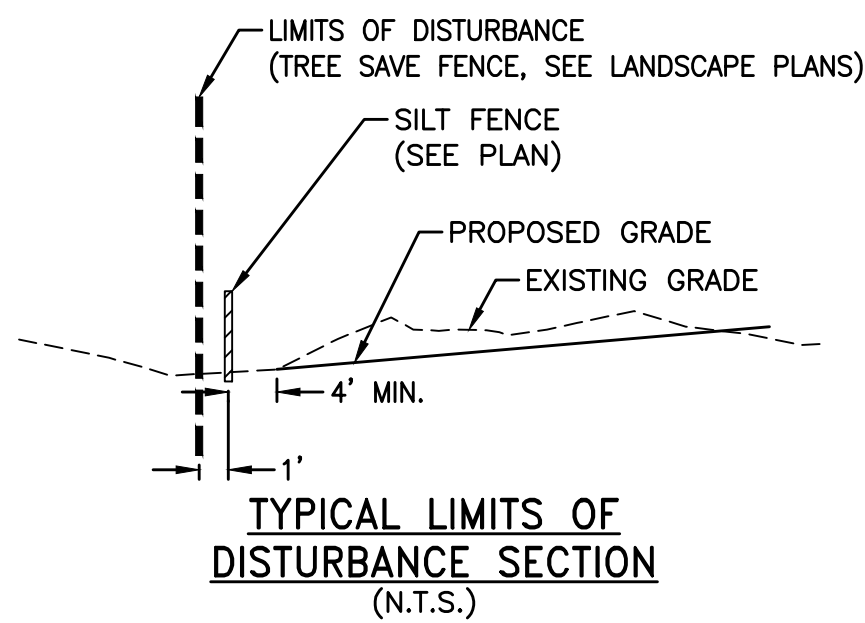


CODE	PRACTICE	MAP SYMBOL	DESCRIPTION
Ds3	DISTURBED AREA STABILIZATION (WITH PERMANENT VEGETATION)	Ds3	ESTABLISHING PERMANENT VEGETATIVE COVER SUCH AS TREES, SHRUBS, VINES, GRASSES, SOD OR LEGUMES ON DISTURBED AREAS.
Sd1	SEDIMENT BARRIER	Sd1	A BARRIER TO PREVENT SEDIMENT FROM LEAVING THE CONSTRUCTION SITE. IT MAY BE SANDBAGS, BALES OF STRAW OR HAY, BRUSH, LOGS AND POLES, GRAVEL, OR A SEDIMENT FENCE. THE BARRIERS ARE USUALLY TEMPORARY.
Sd2-B	BUFFLE BOX TEMPORARY INLET PROTECTION	Sd2-B	2"x4" BOARDS SPACED A MAXIMUM 1" APART OR PLYWOOD WITH WEEP HOLES 2" DIAM. AT 6" ON CENTER VERTICALLY & HORIZONTALLY. PLACE GRAVEL OUTSIDE BOX TO A DEPTH OF 2" TO 4". WRAP BOX IN FILTER FABRIC & ENTRENCH 12".
Sd2-P	CURB INLET FILTER (PIGS-IN-A-BLANKET)	Sd2-P	WRAP 8 INCH CONCRETE BLOCKS OR #4 STONE IN FILTER FABRIC AND SPAN ACROSS CATCH BASIN INLET.




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Revisions	Date	PRIME:	MEP ENGINEER:	IRRIGATION DESIGNER:	DRAWING TITLE	PROJECT TITLE			Date			
		 AMEC FOSTER WHEELER ENVIRONMENT & INFRASTRUCTURE 1075 BIG SHANTY ROAD NW, SUITE 100 KENNESAW, GA, 30144 (770) 421-3400 AMEC PROJECT: 6166-15-0011					 2231 Weatherstone Circle Conyers, GA 30094 (770) 929-0884, fax (770) 760-8025	 NATIONAL CEMETERY ADMINISTRATION	4000 NICHE COLUMBARIUM GEORGIA NATIONAL CEMETERY			23 OCTOBER 2015
									Approved: Director, Technical Support Service	Building Number	Checked	Drawn
Approved: Chief, Architectural & Engineering Division						Location 1080 VETERANS CEMETERY RD, CANTON, GA 30114			DRAWING NO. C-105 Sheet 9 of 31			

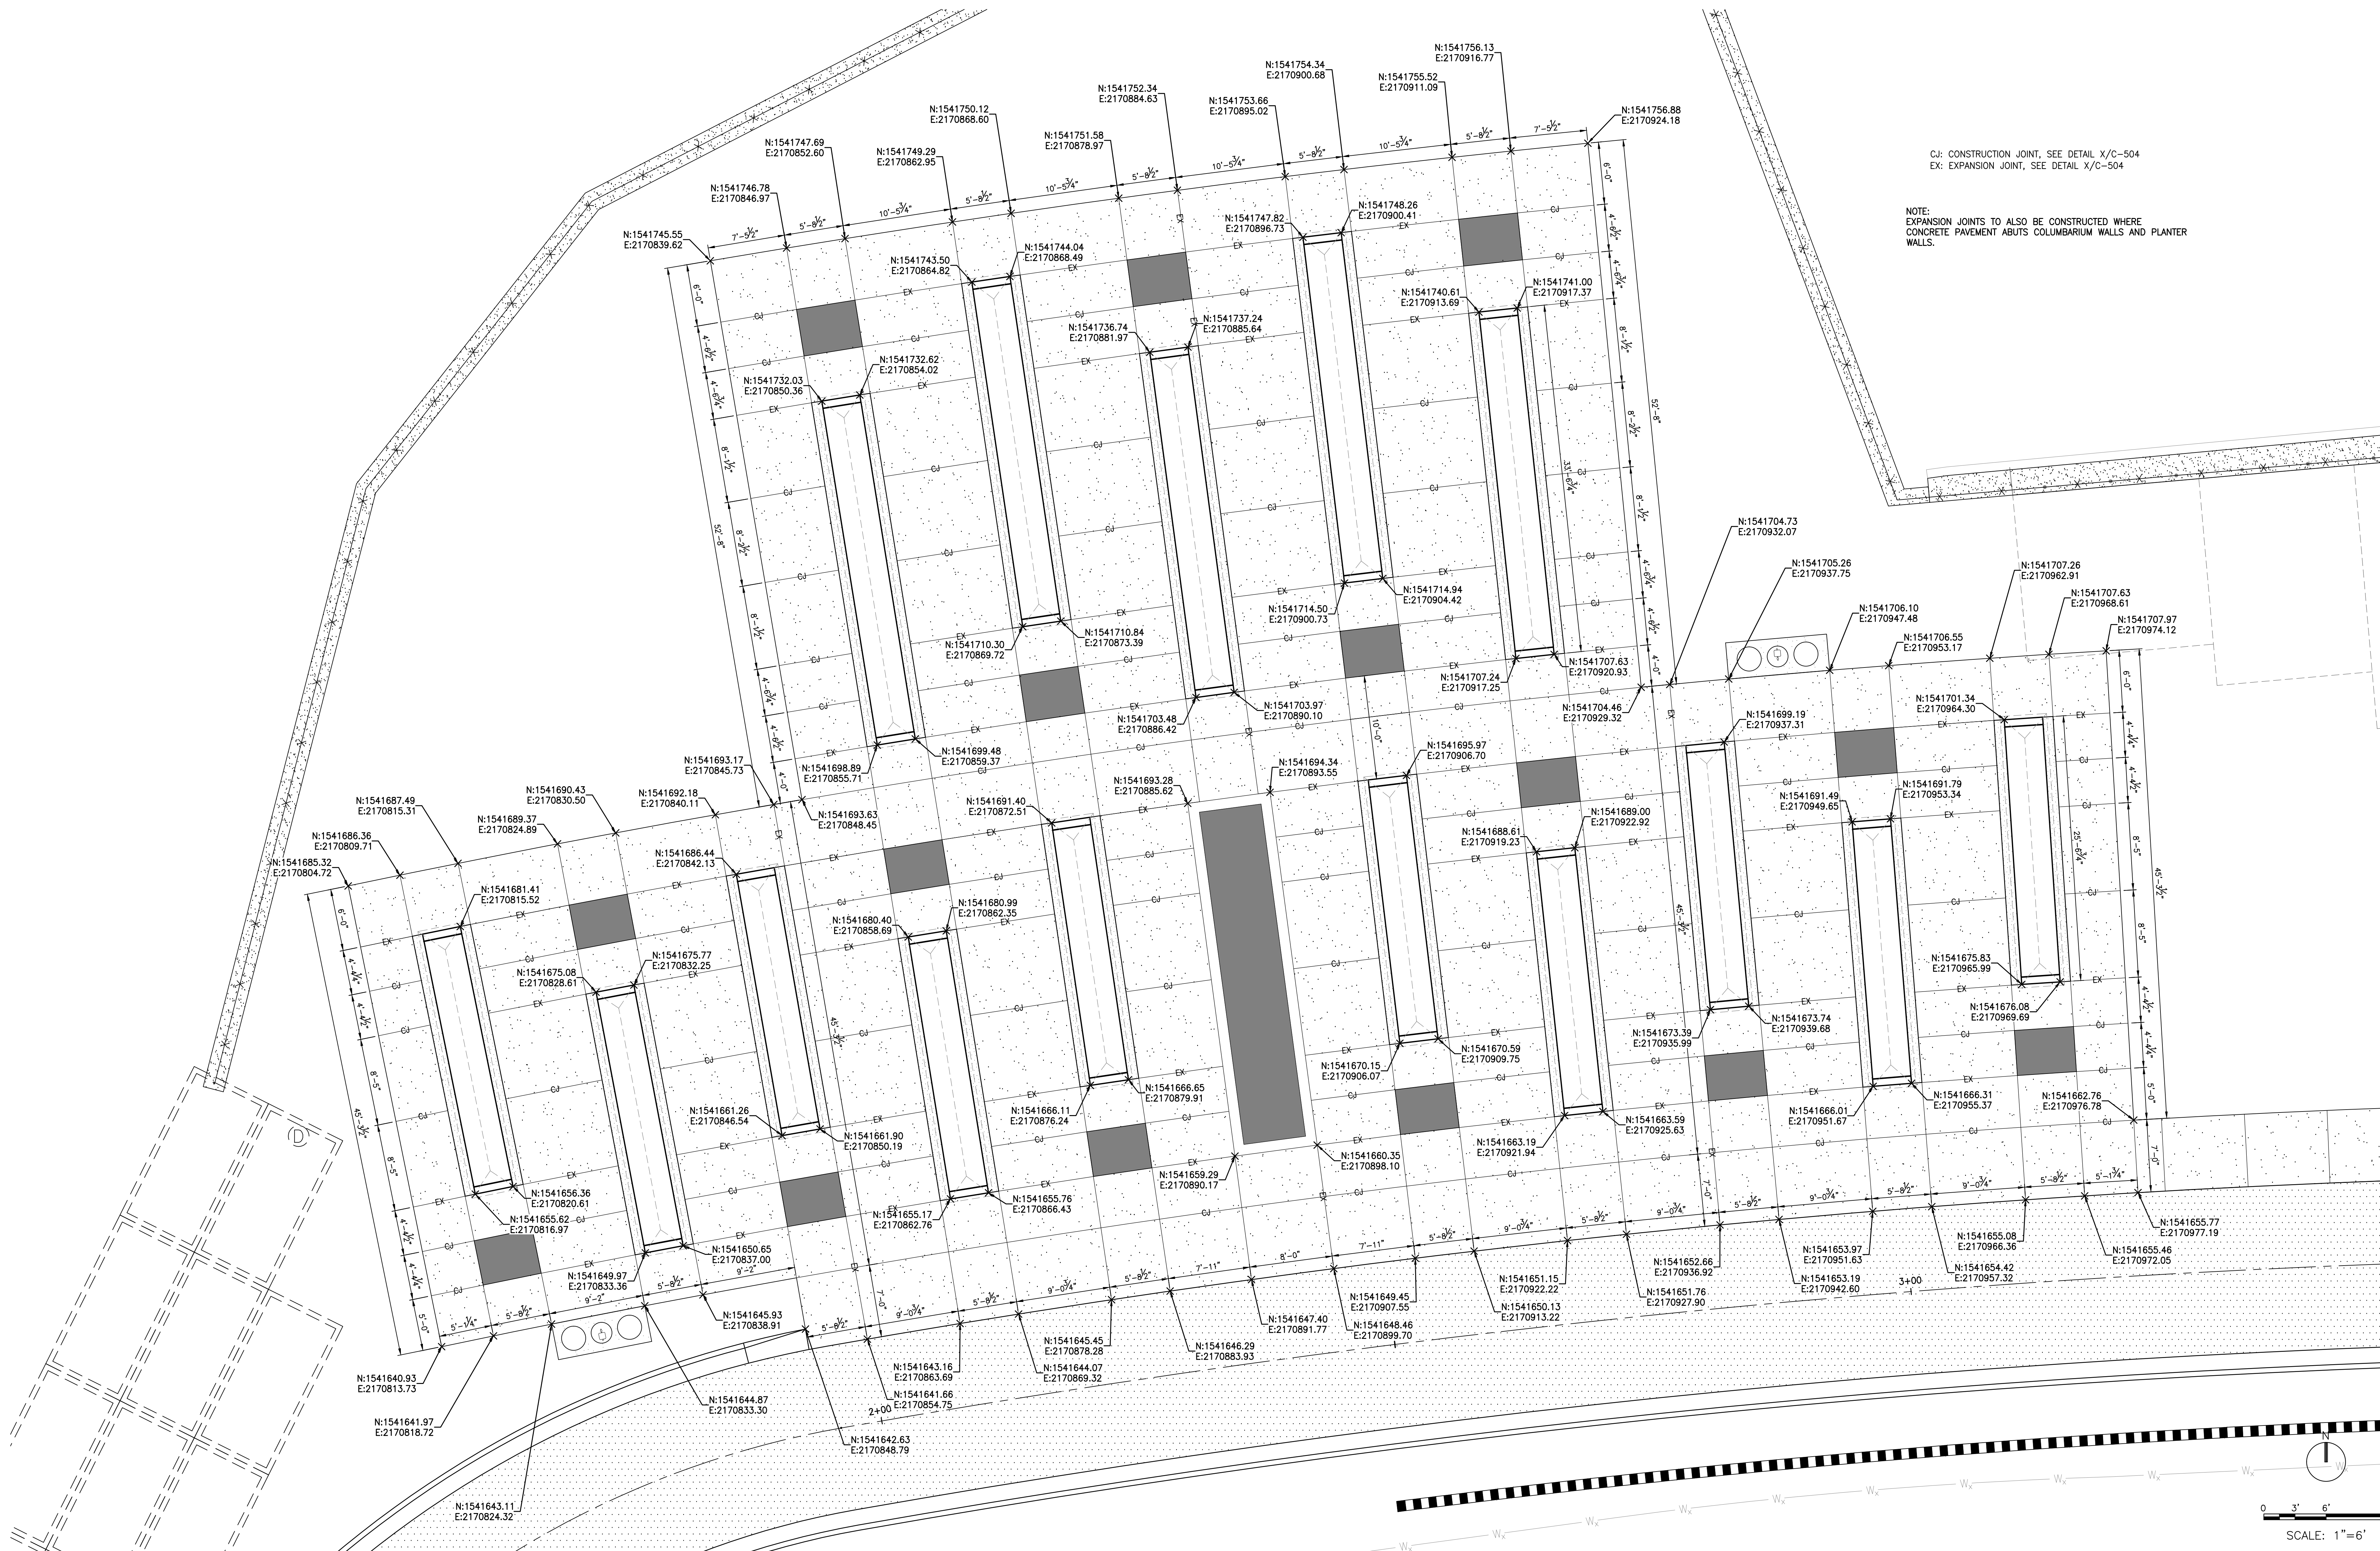

CJ: CONSTRUCTION JOINT, SEE DETAIL X/C-504
EX: EXPANSION JOINT, SEE DETAIL X/C-504



NOTE:
EXPANSION JOINTS TO ALSO BE CONSTRUCTED WHERE
CONCRETE PAVEMENT ABUTS COLUMBARIUM WALLS AND PLANTER
WALLS.

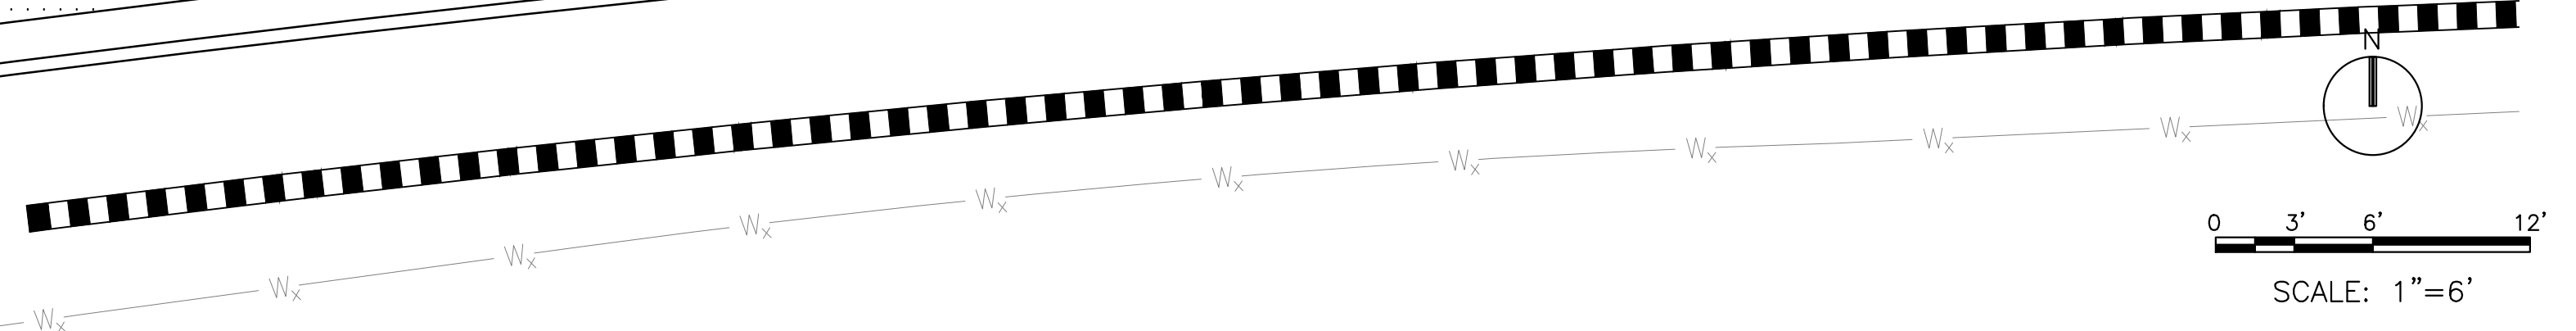


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A
B
C
D
E
F


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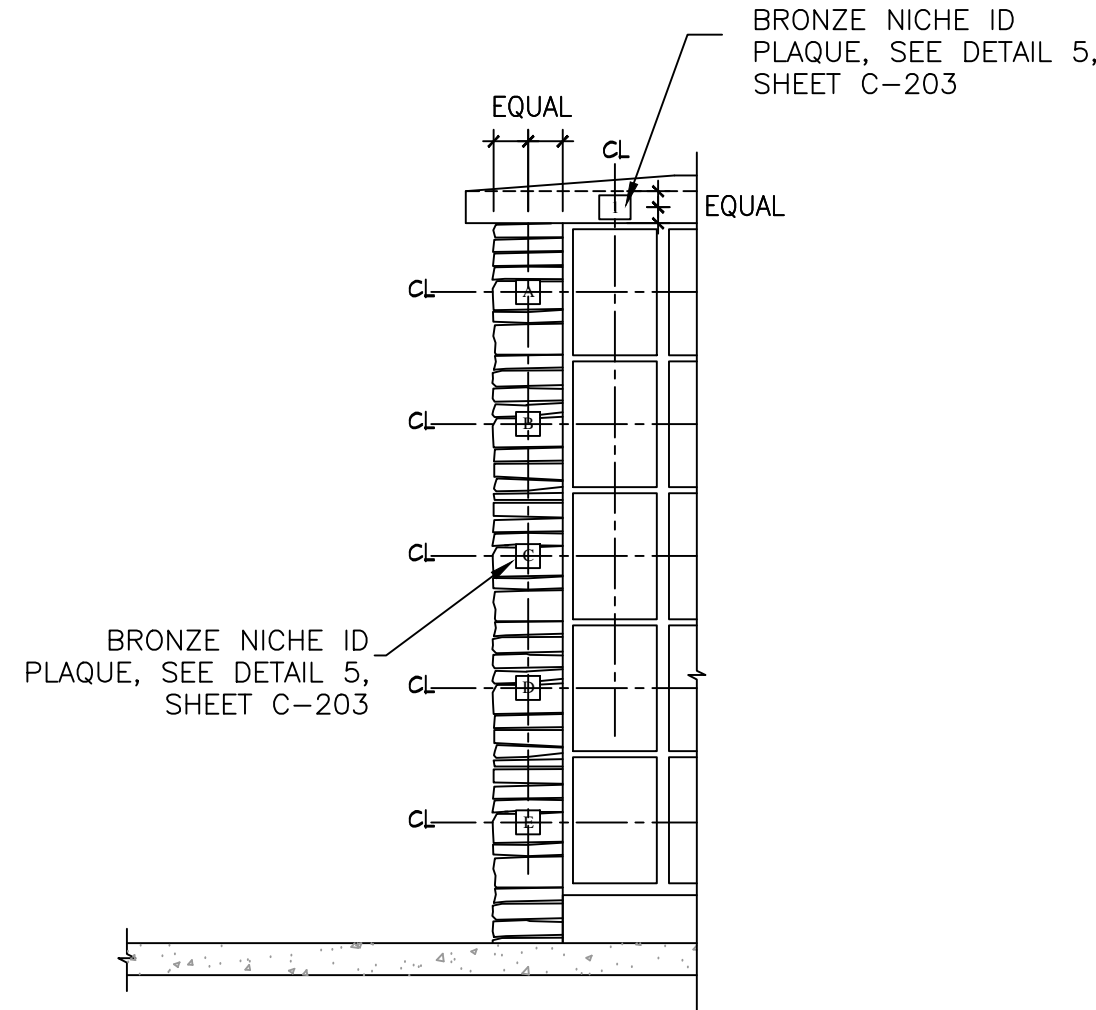
5 BRONZE NICHE IDENTIFICATION PLAQUES
N.T.S.

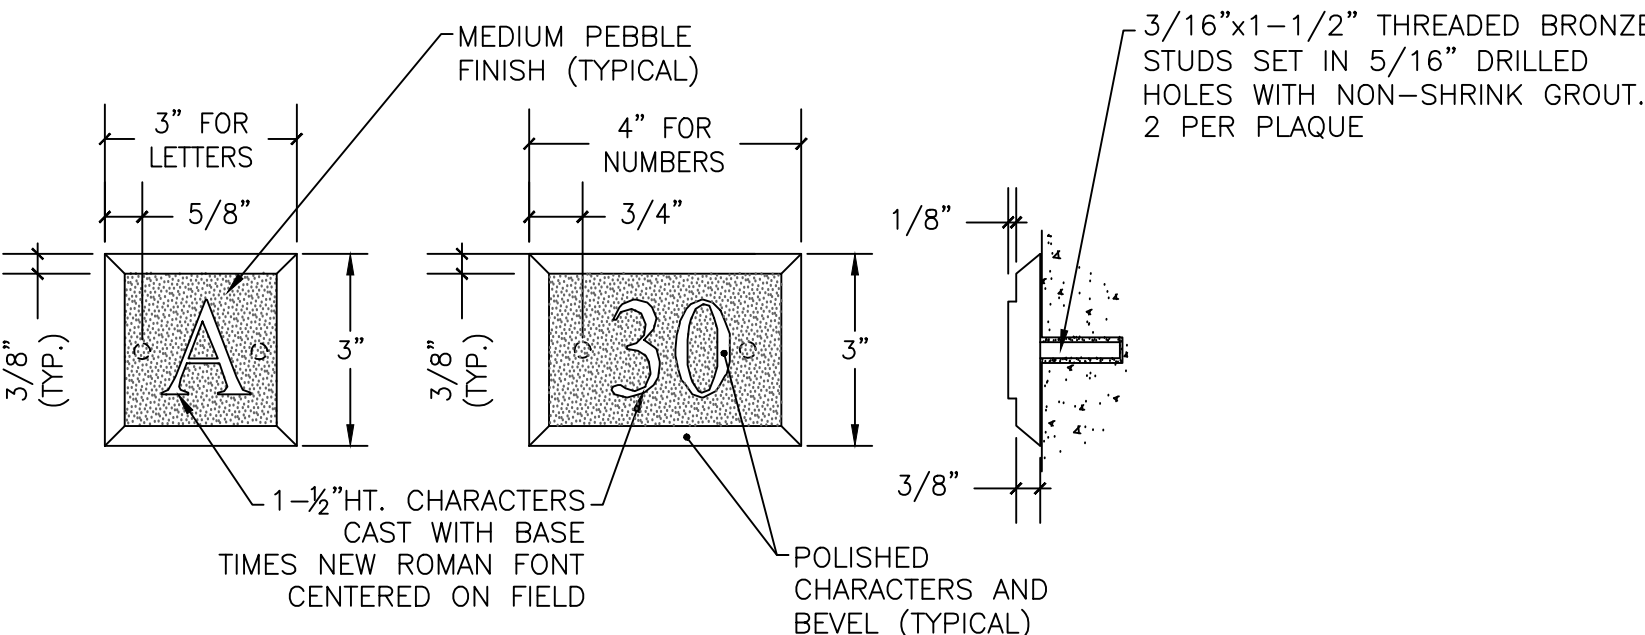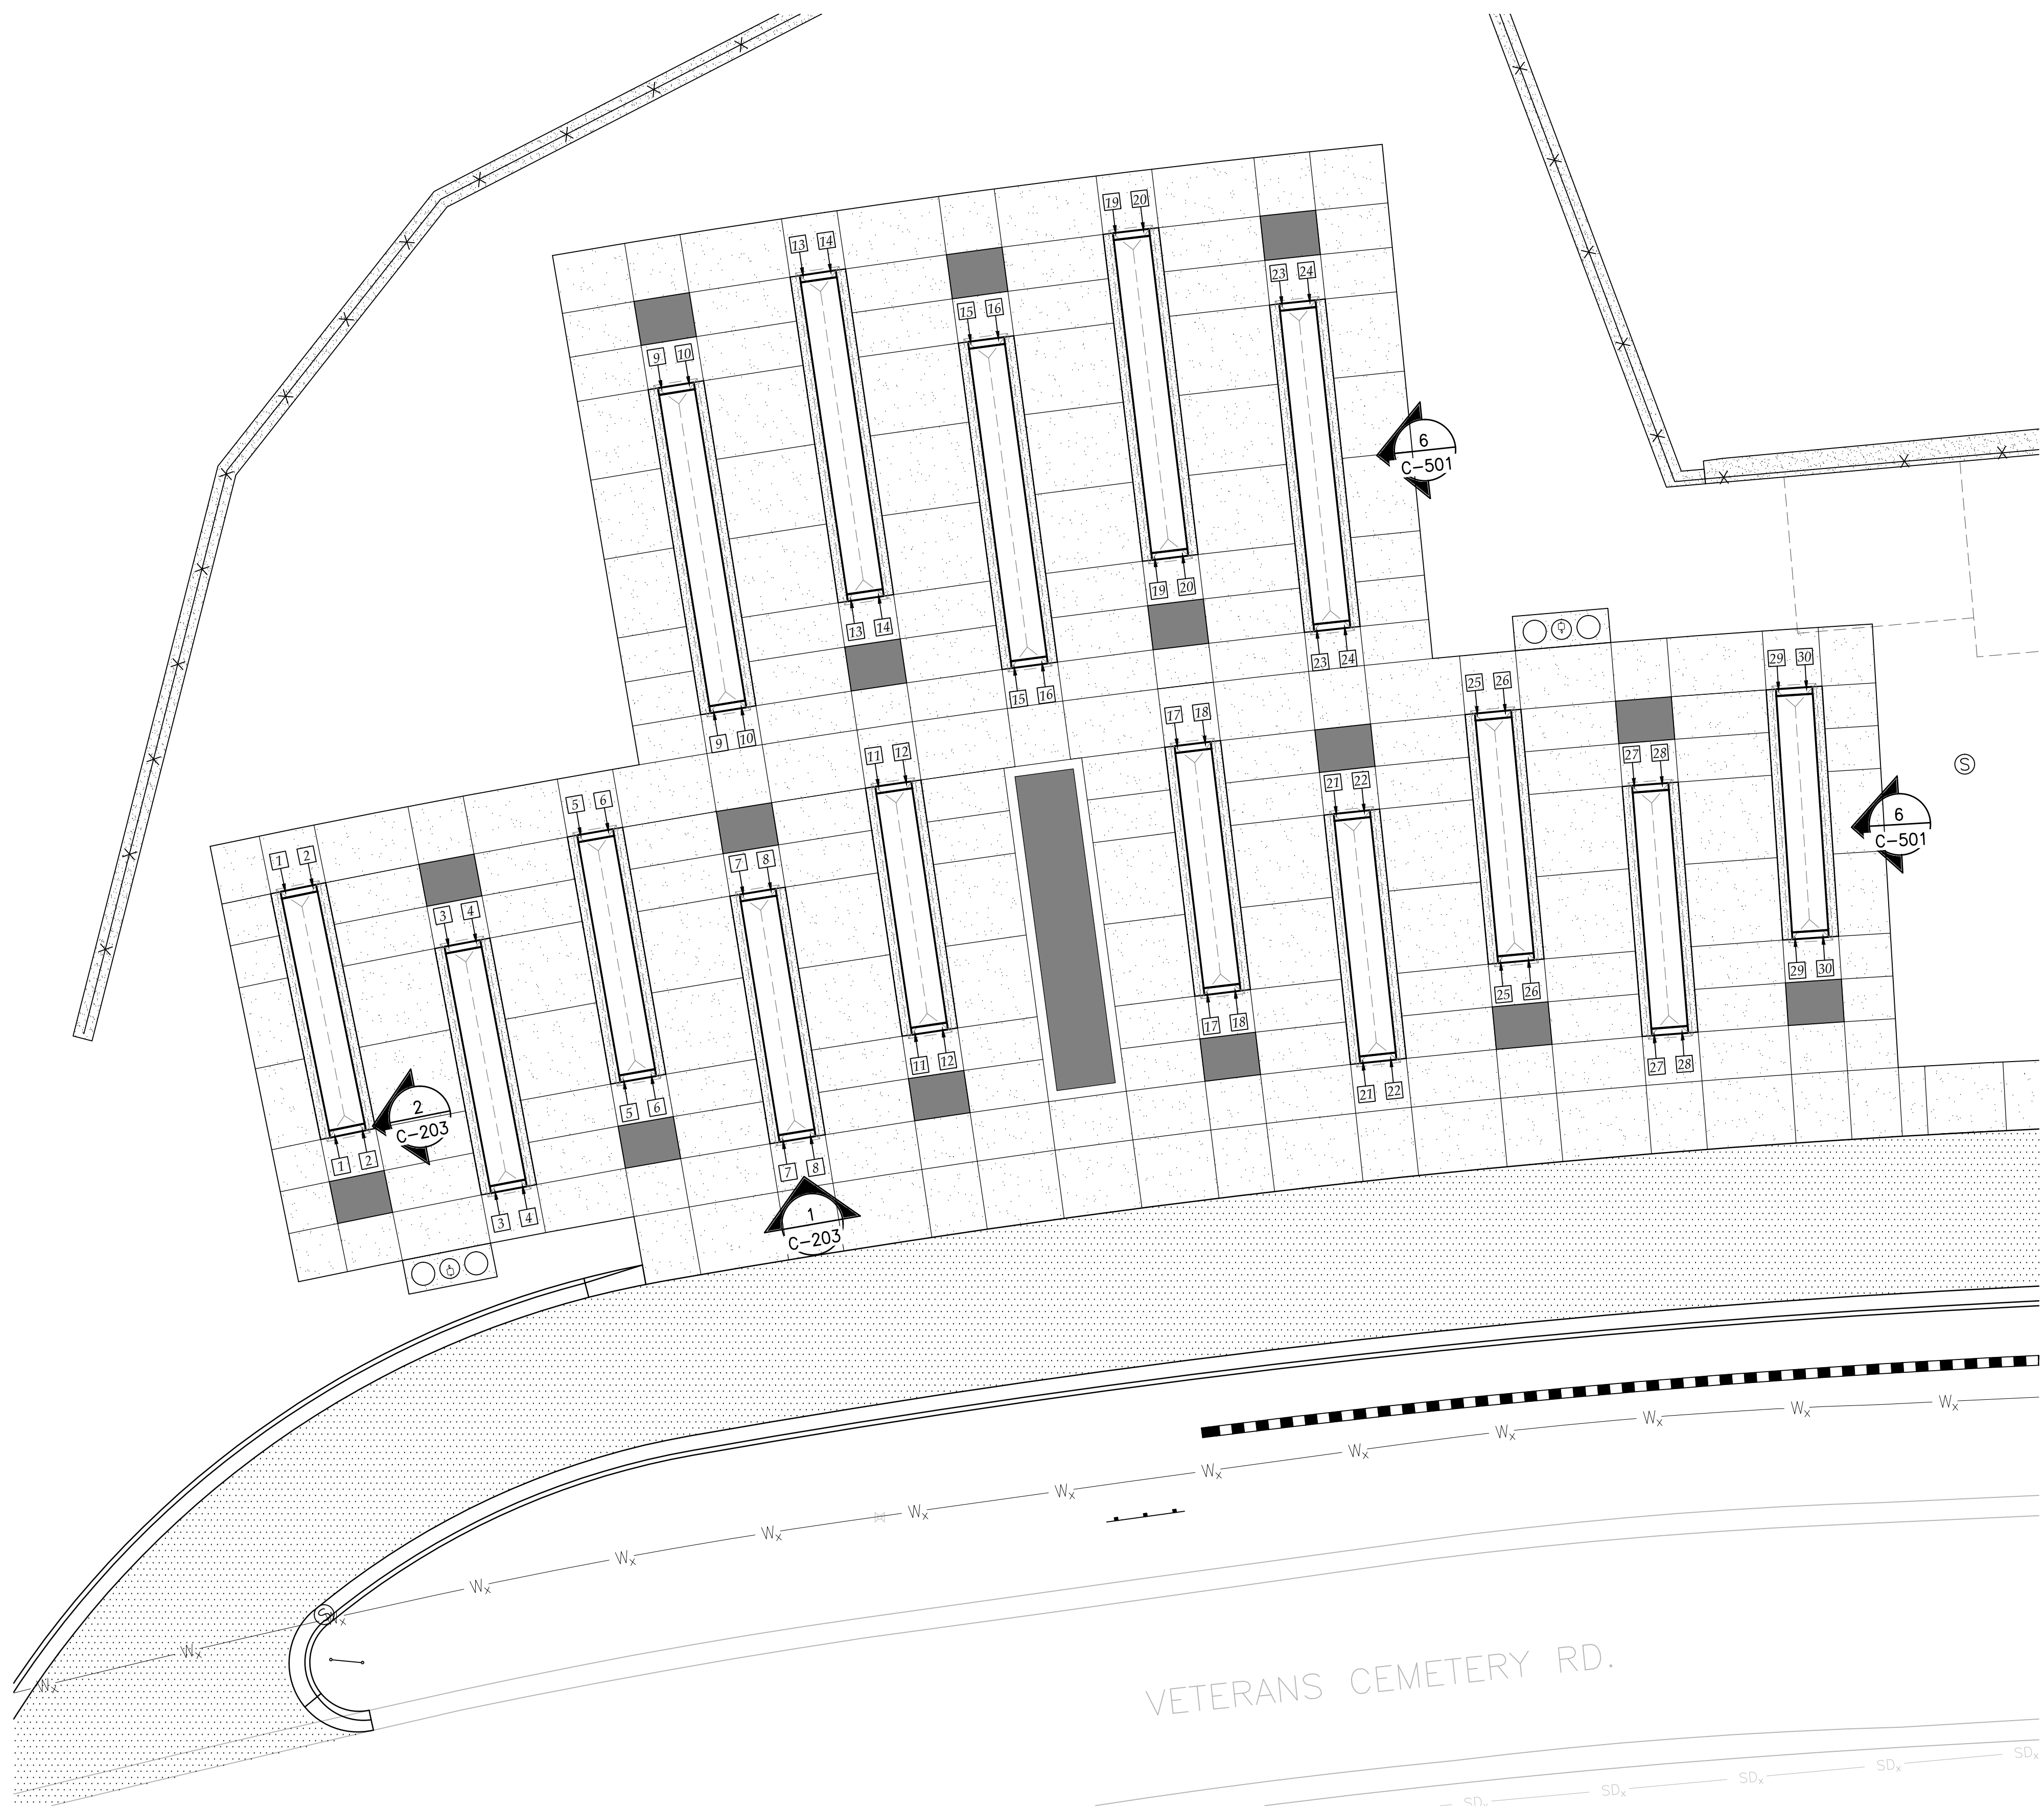


4 MARBLE WALL NUMBERING DETAIL
1"=10"

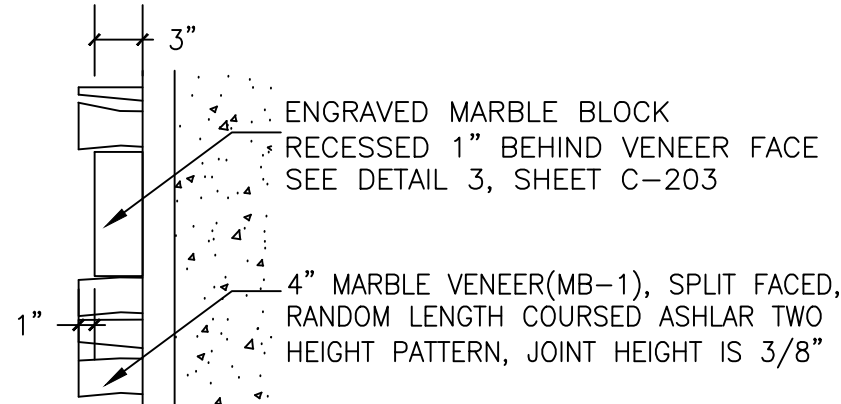


3 MARBLE IDENTIFICATION BLOCK DETAIL
1"=1'-0"

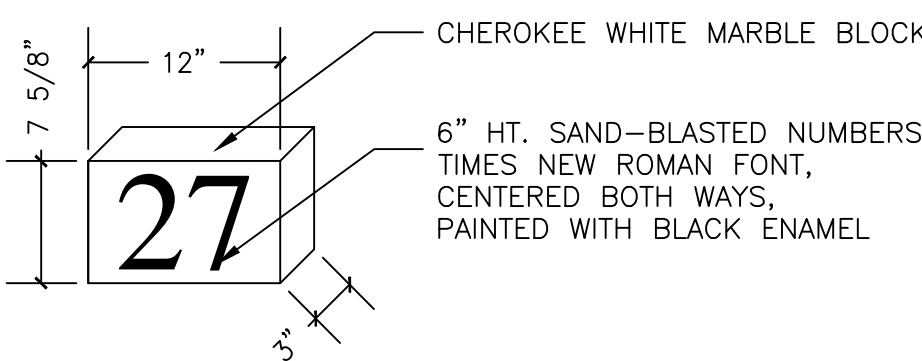





2 NICHE ROW LETTER PLAQUE LOCATION
3/4"=1'-0"

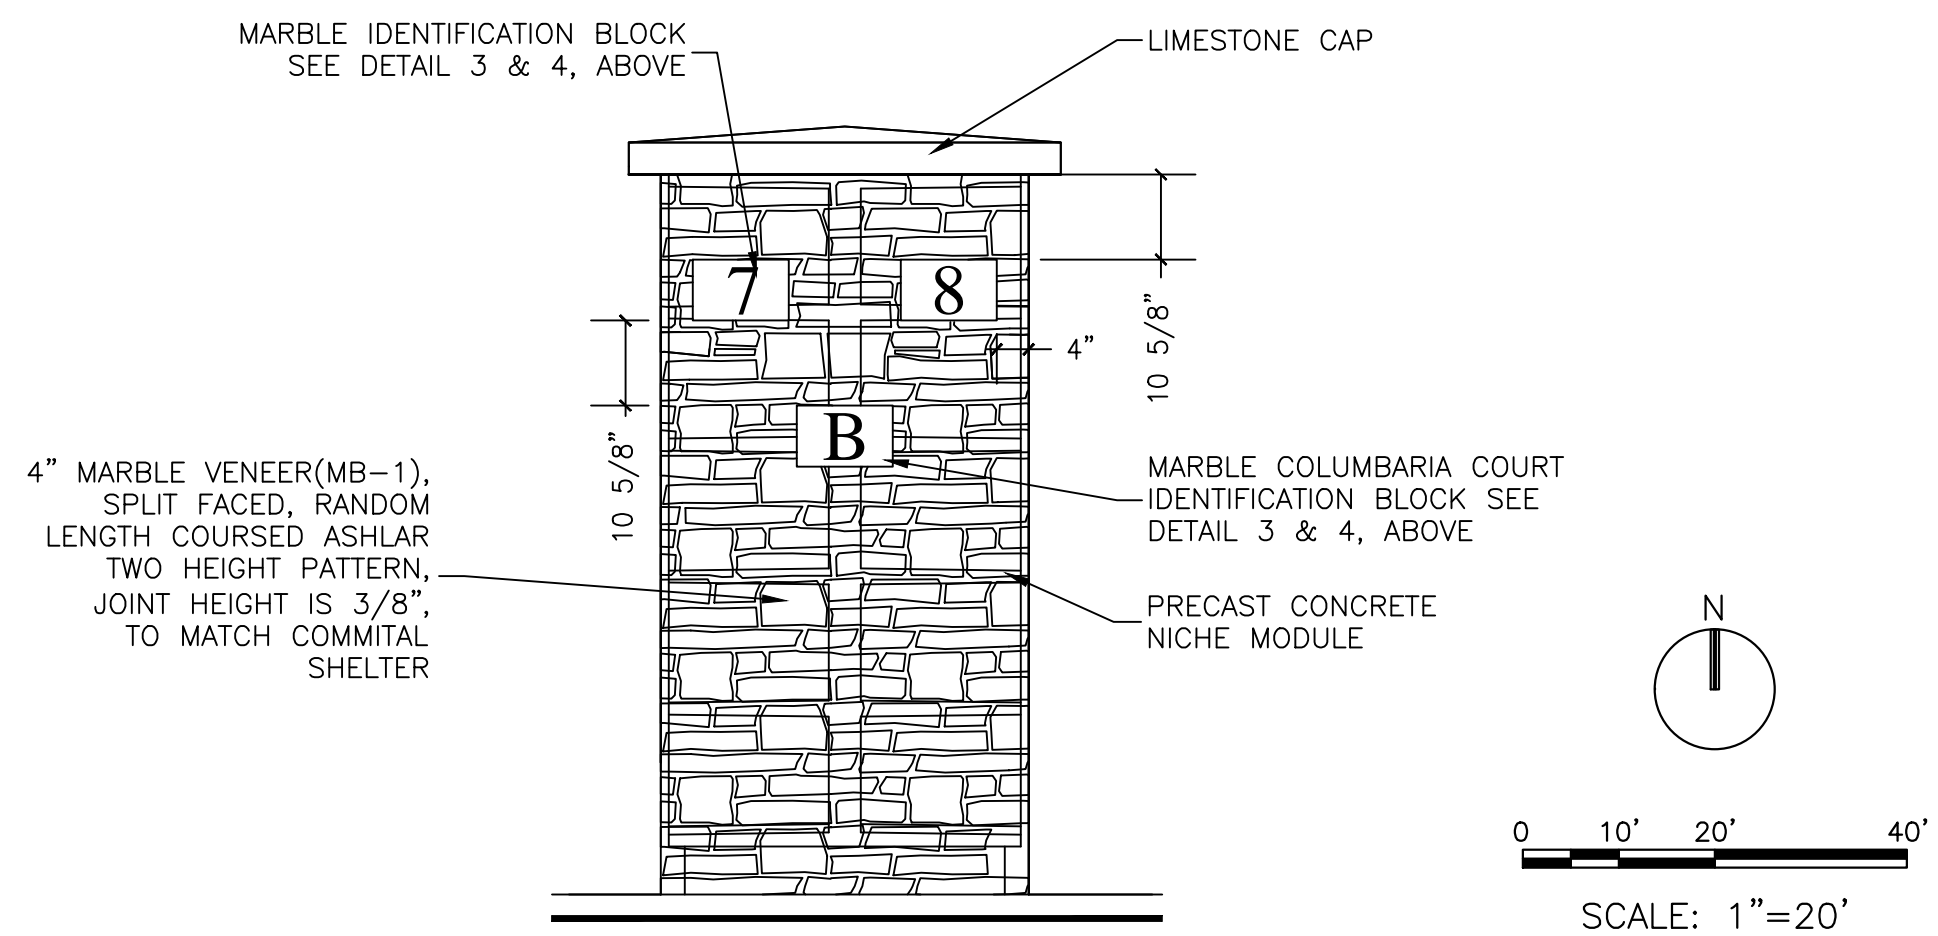






1 COLUMBARIA IDENTIFICATION BLOCK LOCATION
1/2"=1'-0"

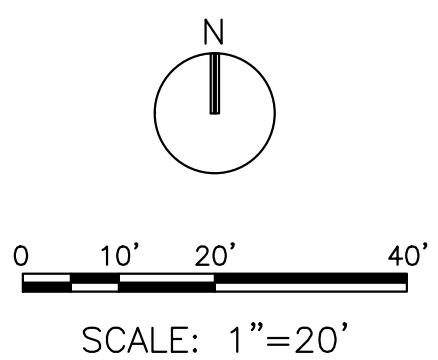


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Revisions		Date		PRIME:		MEP ENGINEER:		IRRIGATION DESIGNER:		Drawing Title		Project Title		Date	
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				AMEC FOSTER WHEELER ENVIRONMENT & INFRASTRUCTURE 1075 BIG SHANTY ROAD NW, SUITE 100 KENNESAW, GA. 30144 (770) 421-3400 AMEC PROJECT: 6166-15-0011				 2231 Weatherstone Circle Conyers, GA 30094 (770) 929-0884, fax (770) 760-8025		Approved: Director, Technical Support Service		Building Number		Checked	
						 NATIONAL CEMETERY ADMINISTRATION		Approved: Chief, Architectual & Engineering Division		Location		DRAWING NO.		Sheet	
										1080 VETERANS CEMETERY RD, CANTON, GA 30114		C-211		13 Of 31	

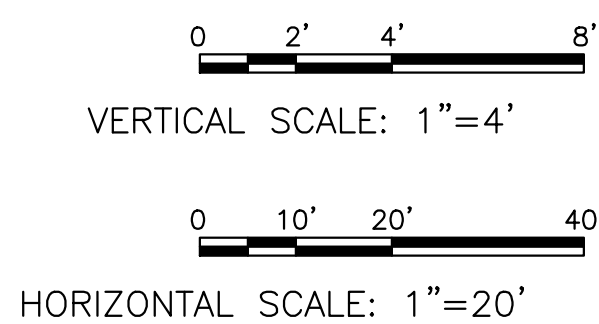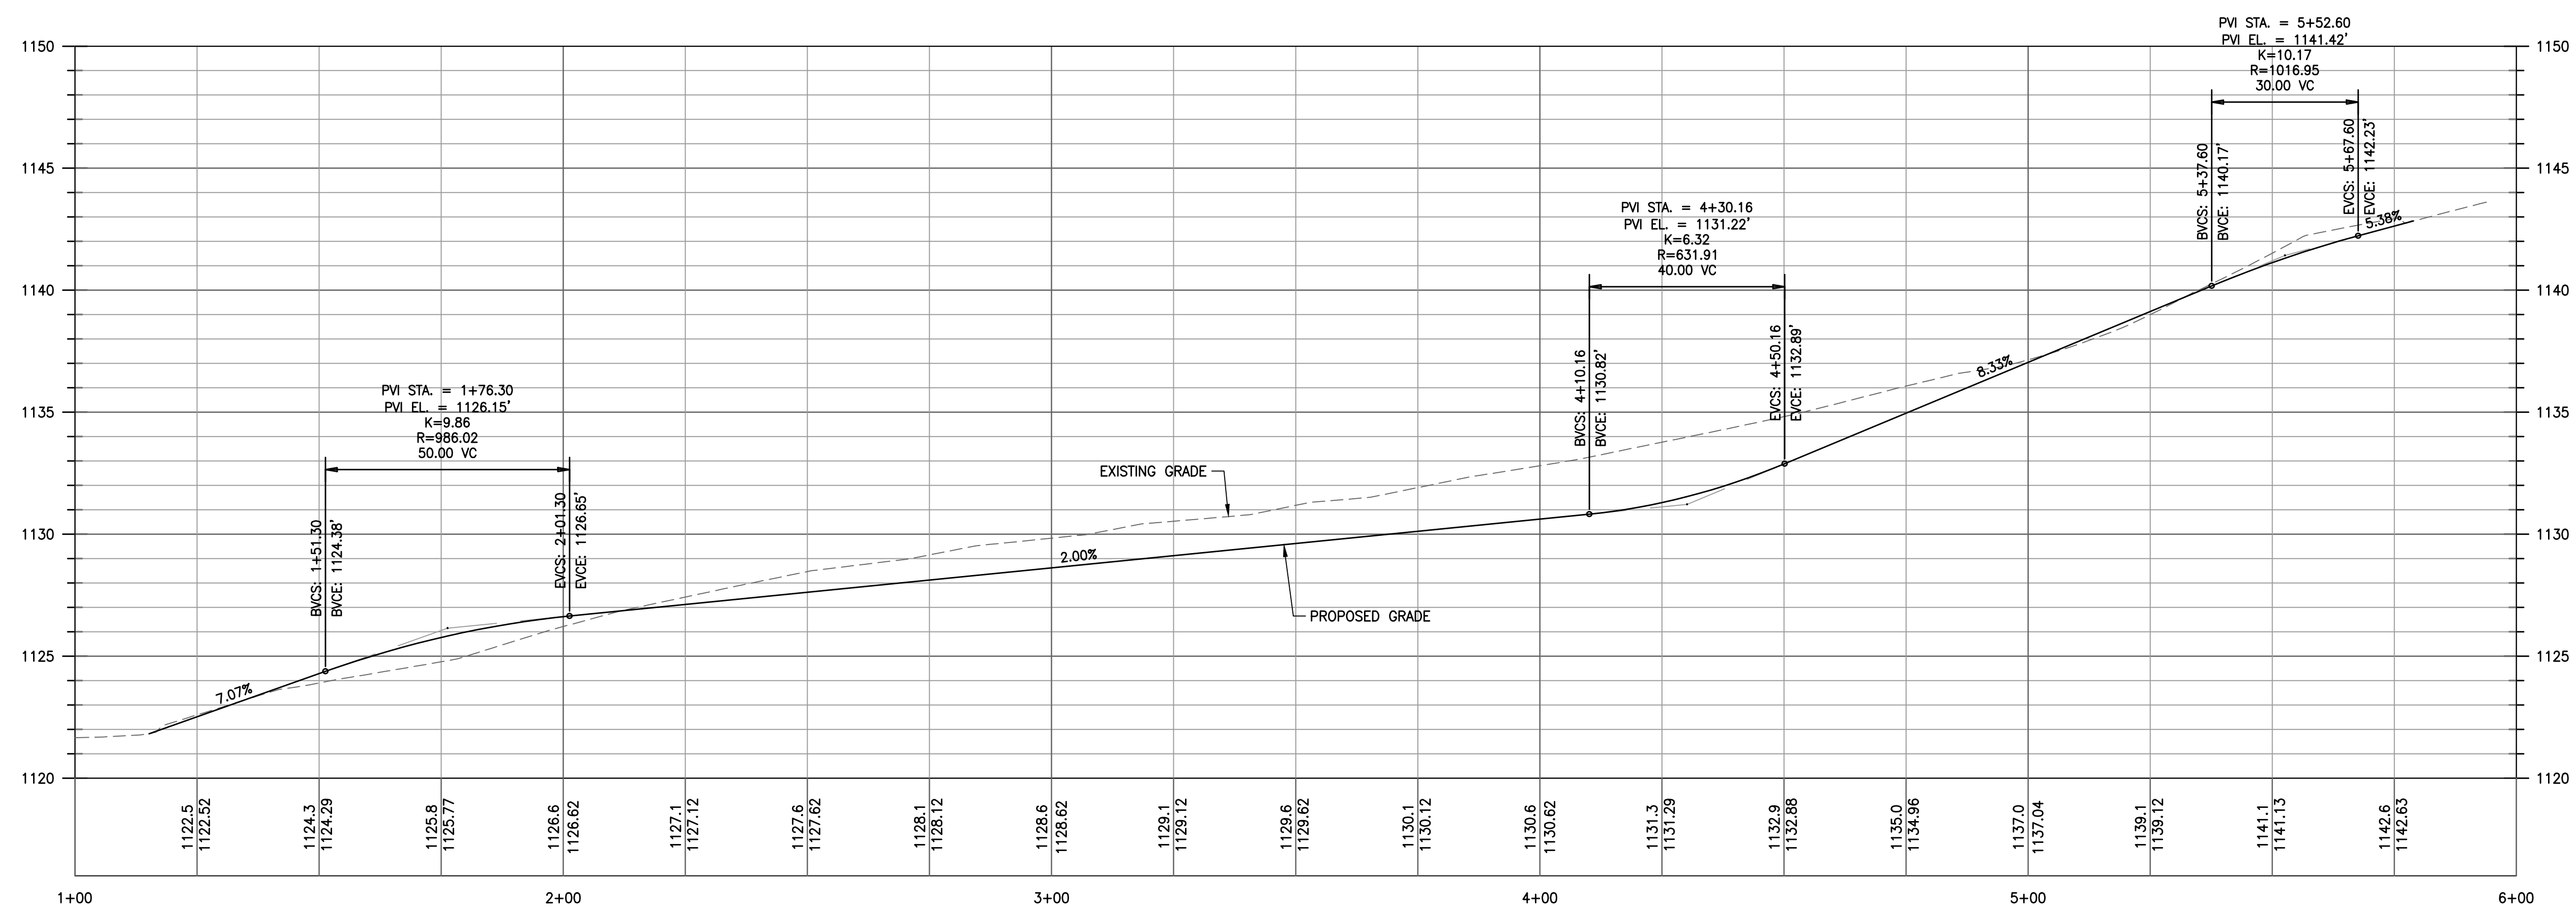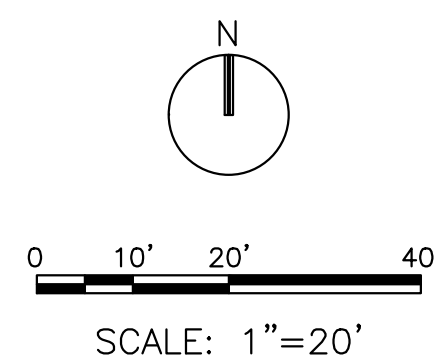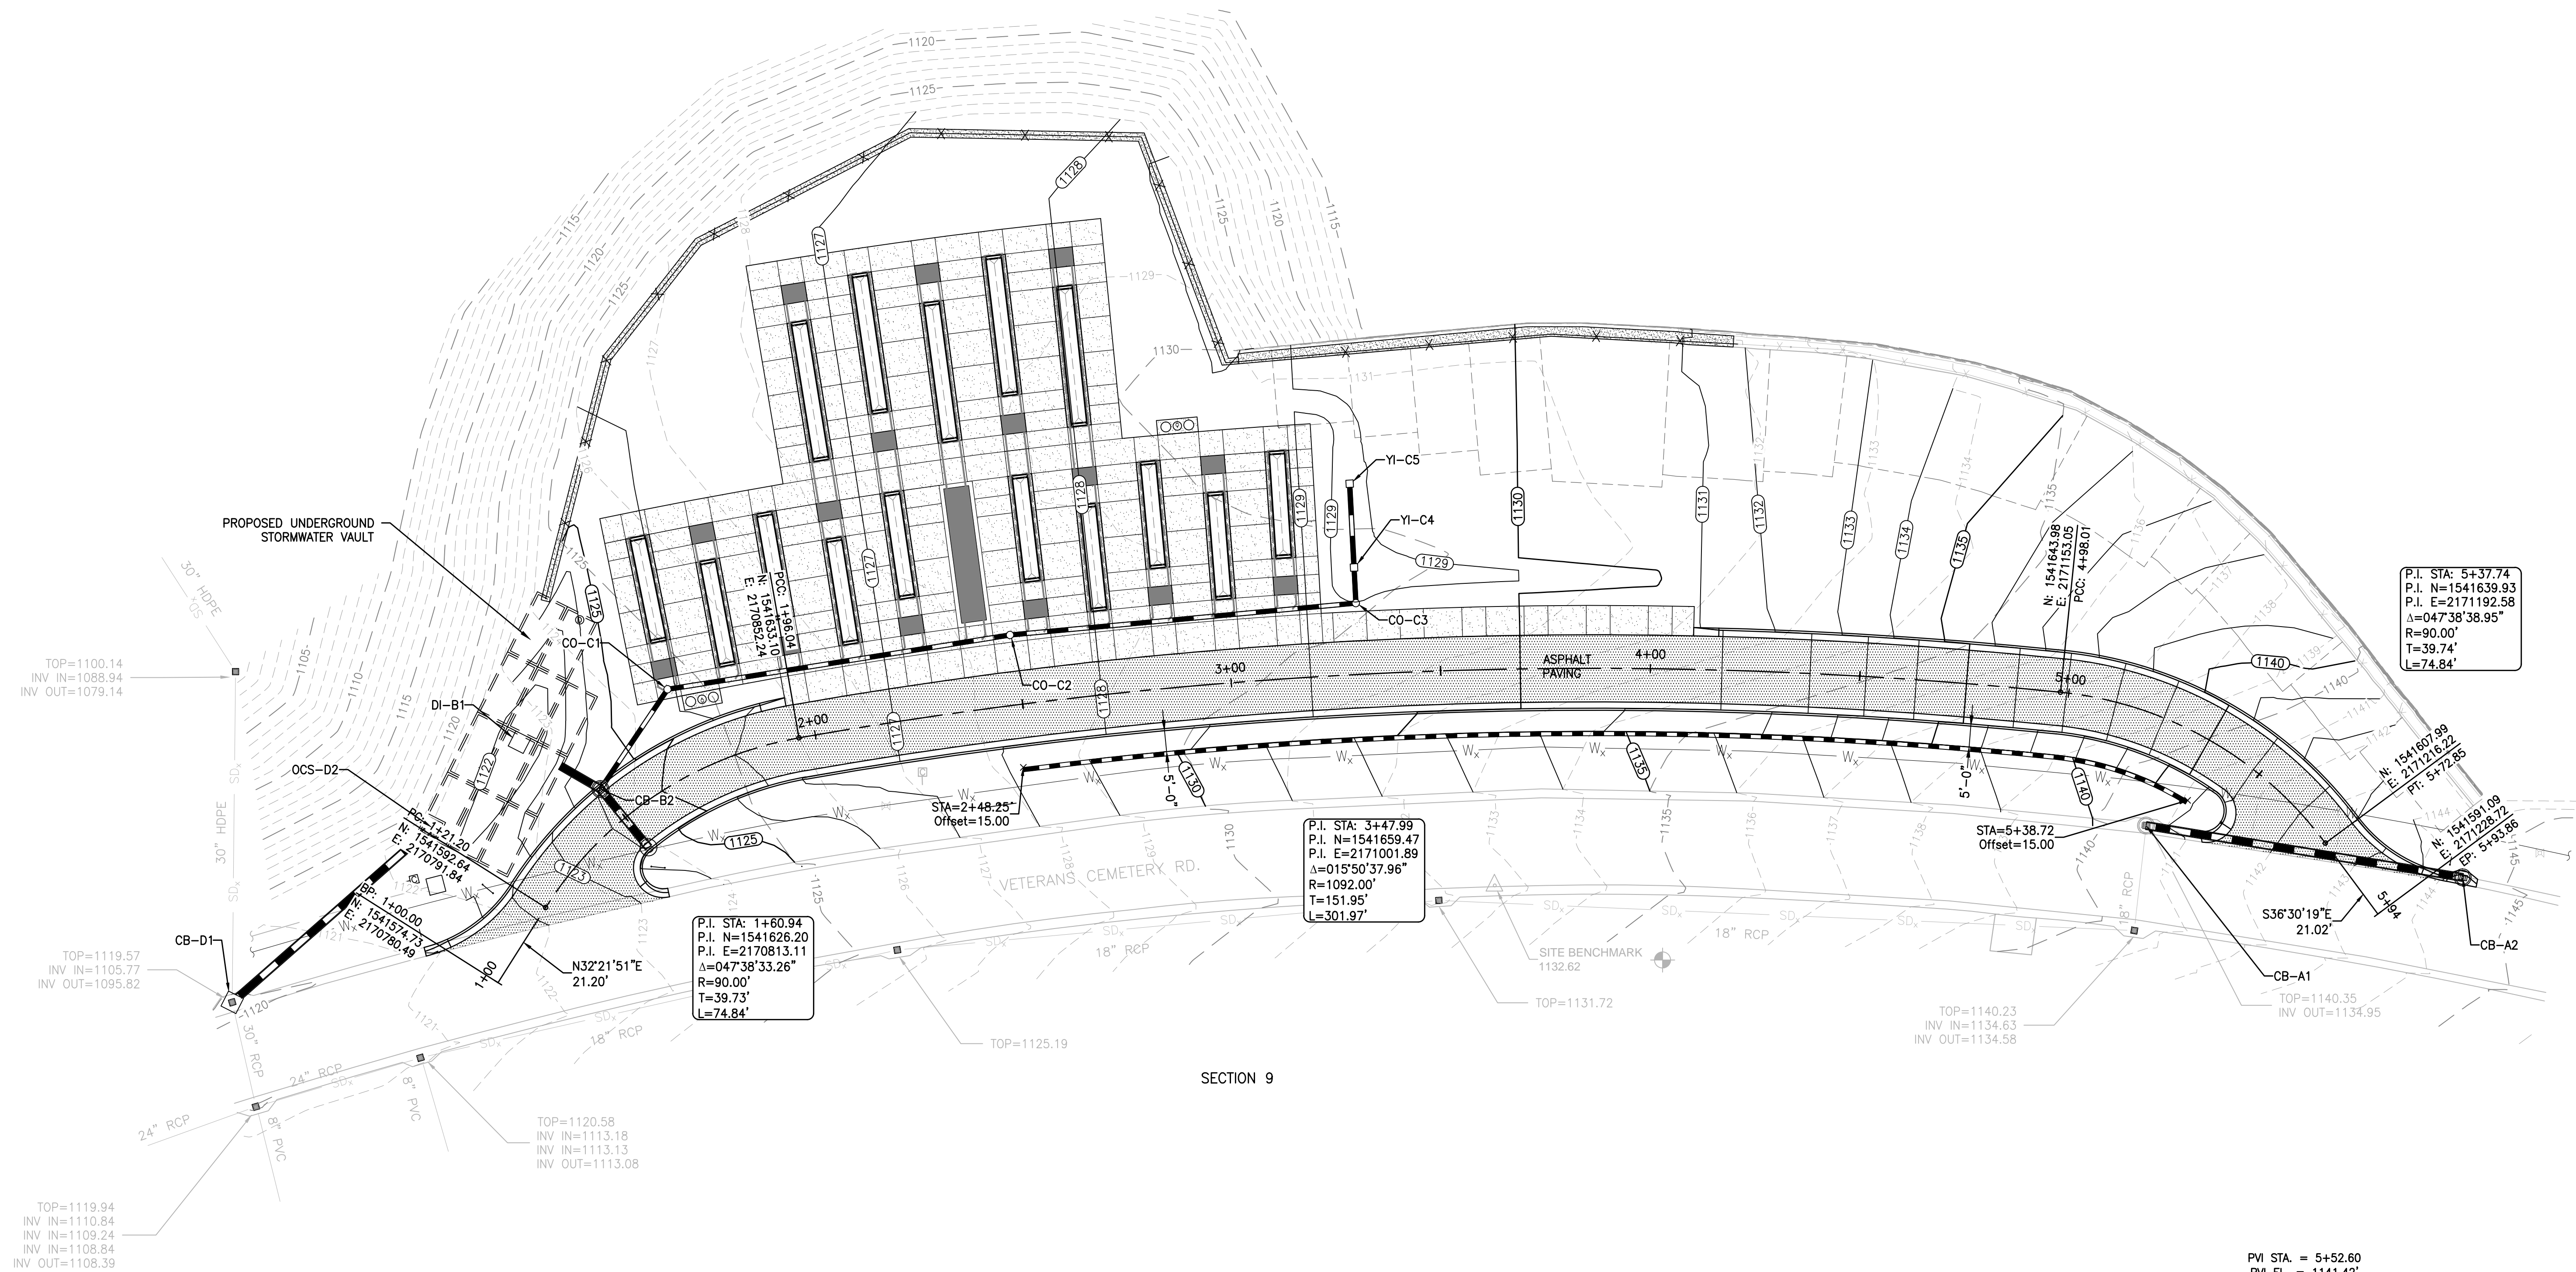


1 PROPOSED WALL "B" ELEVATION

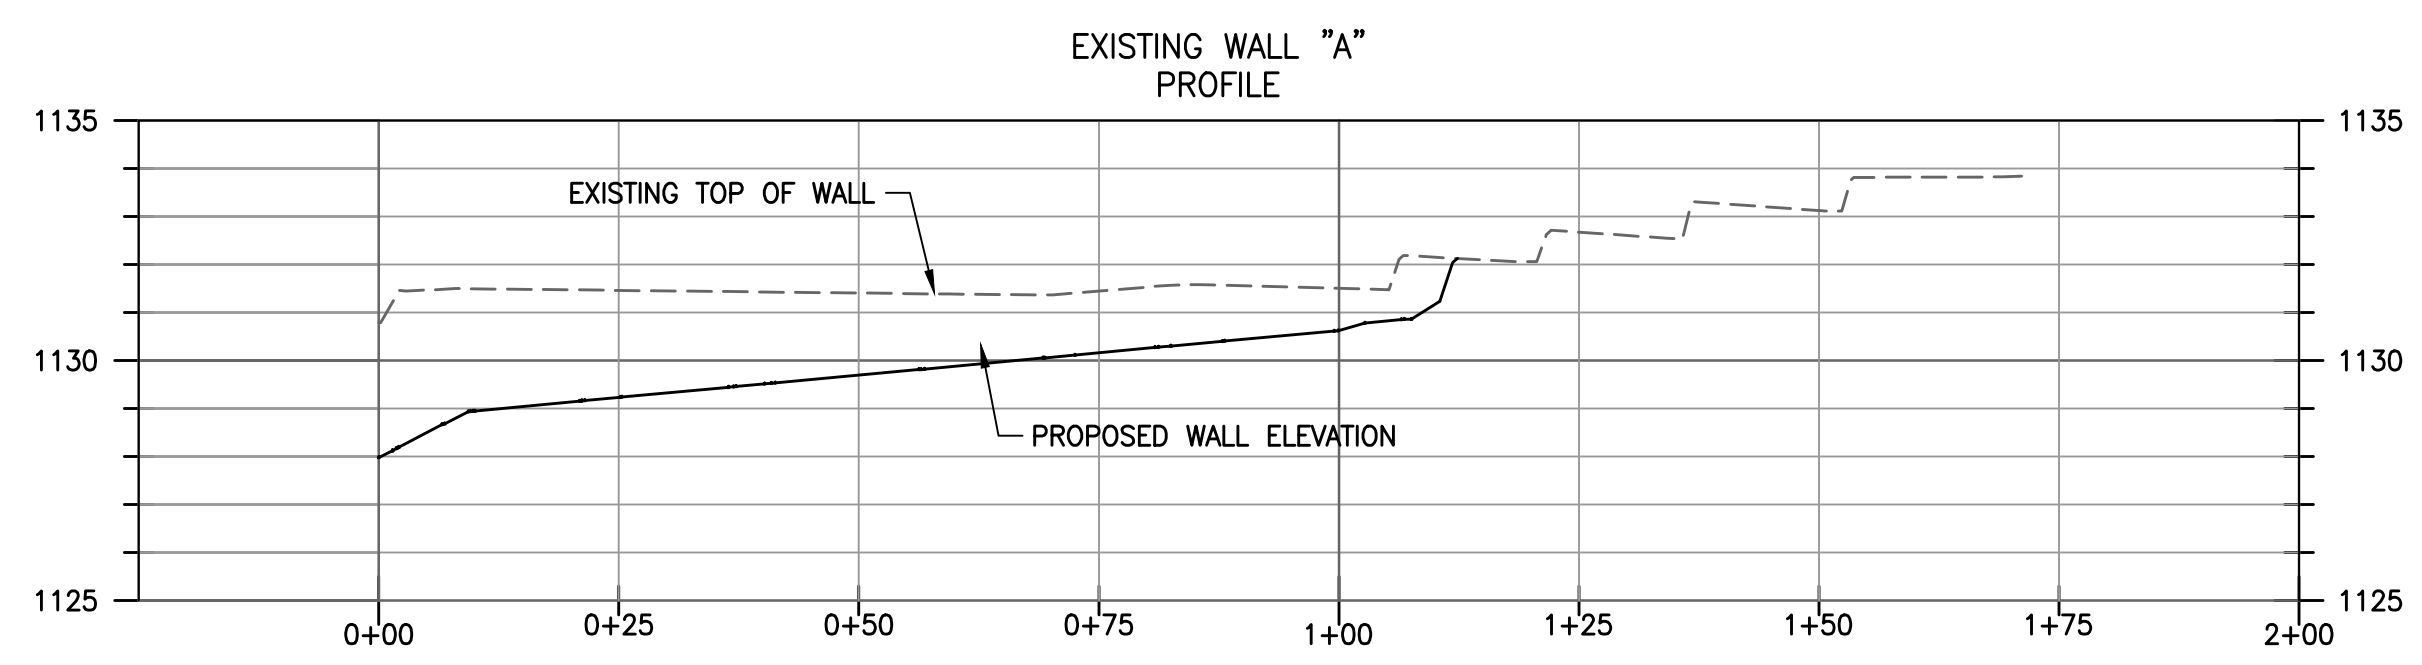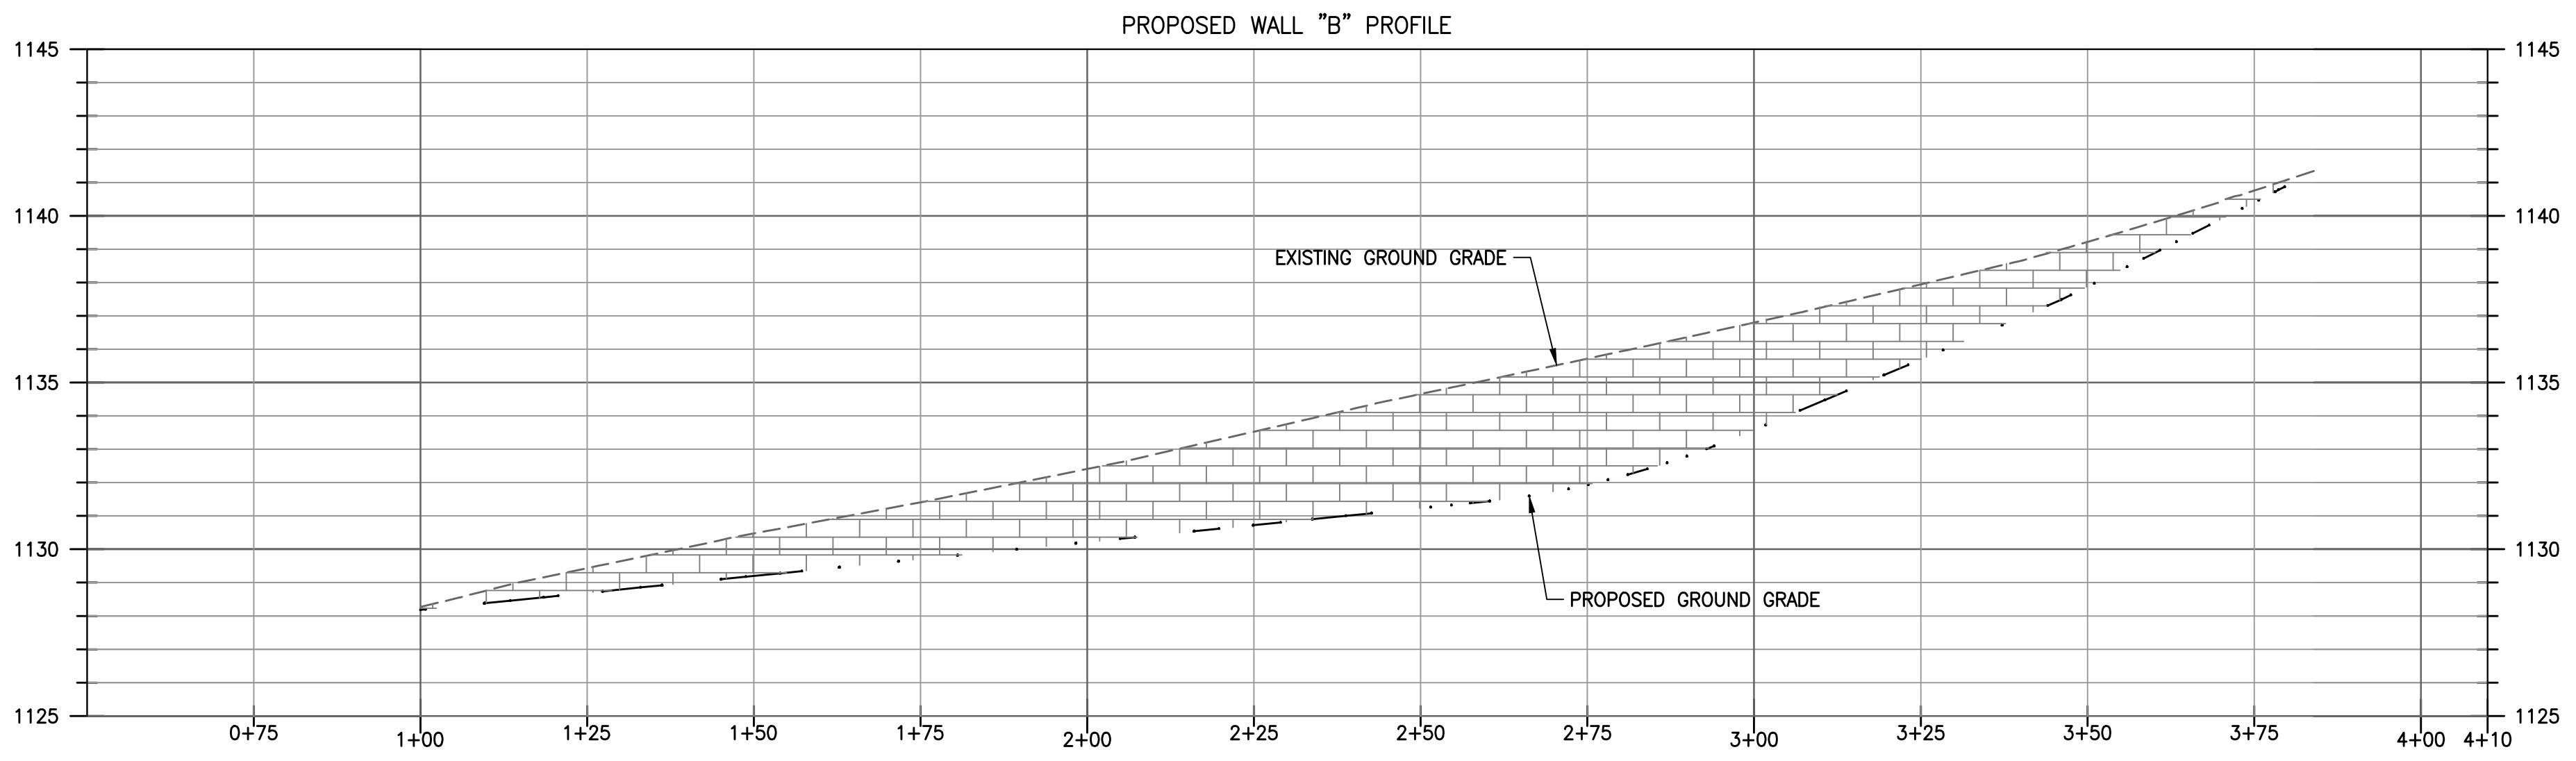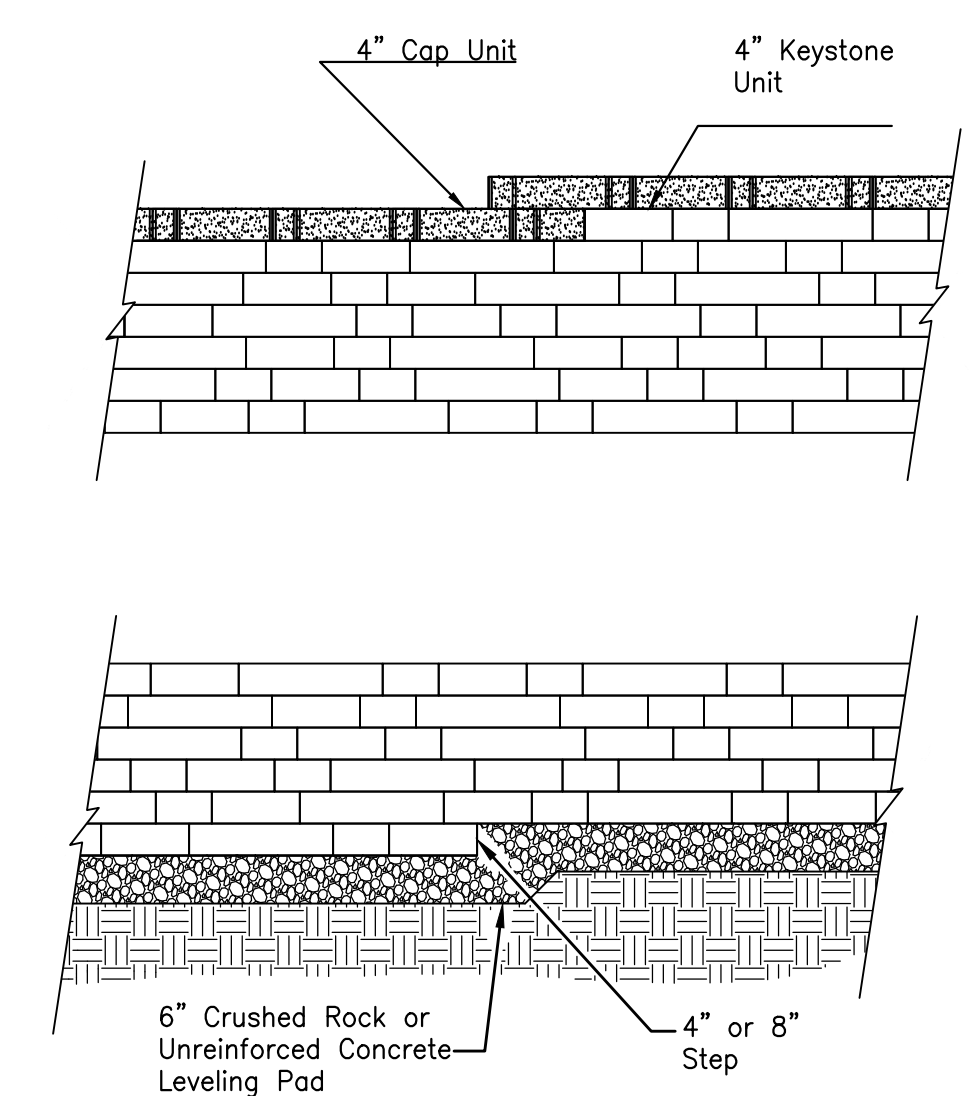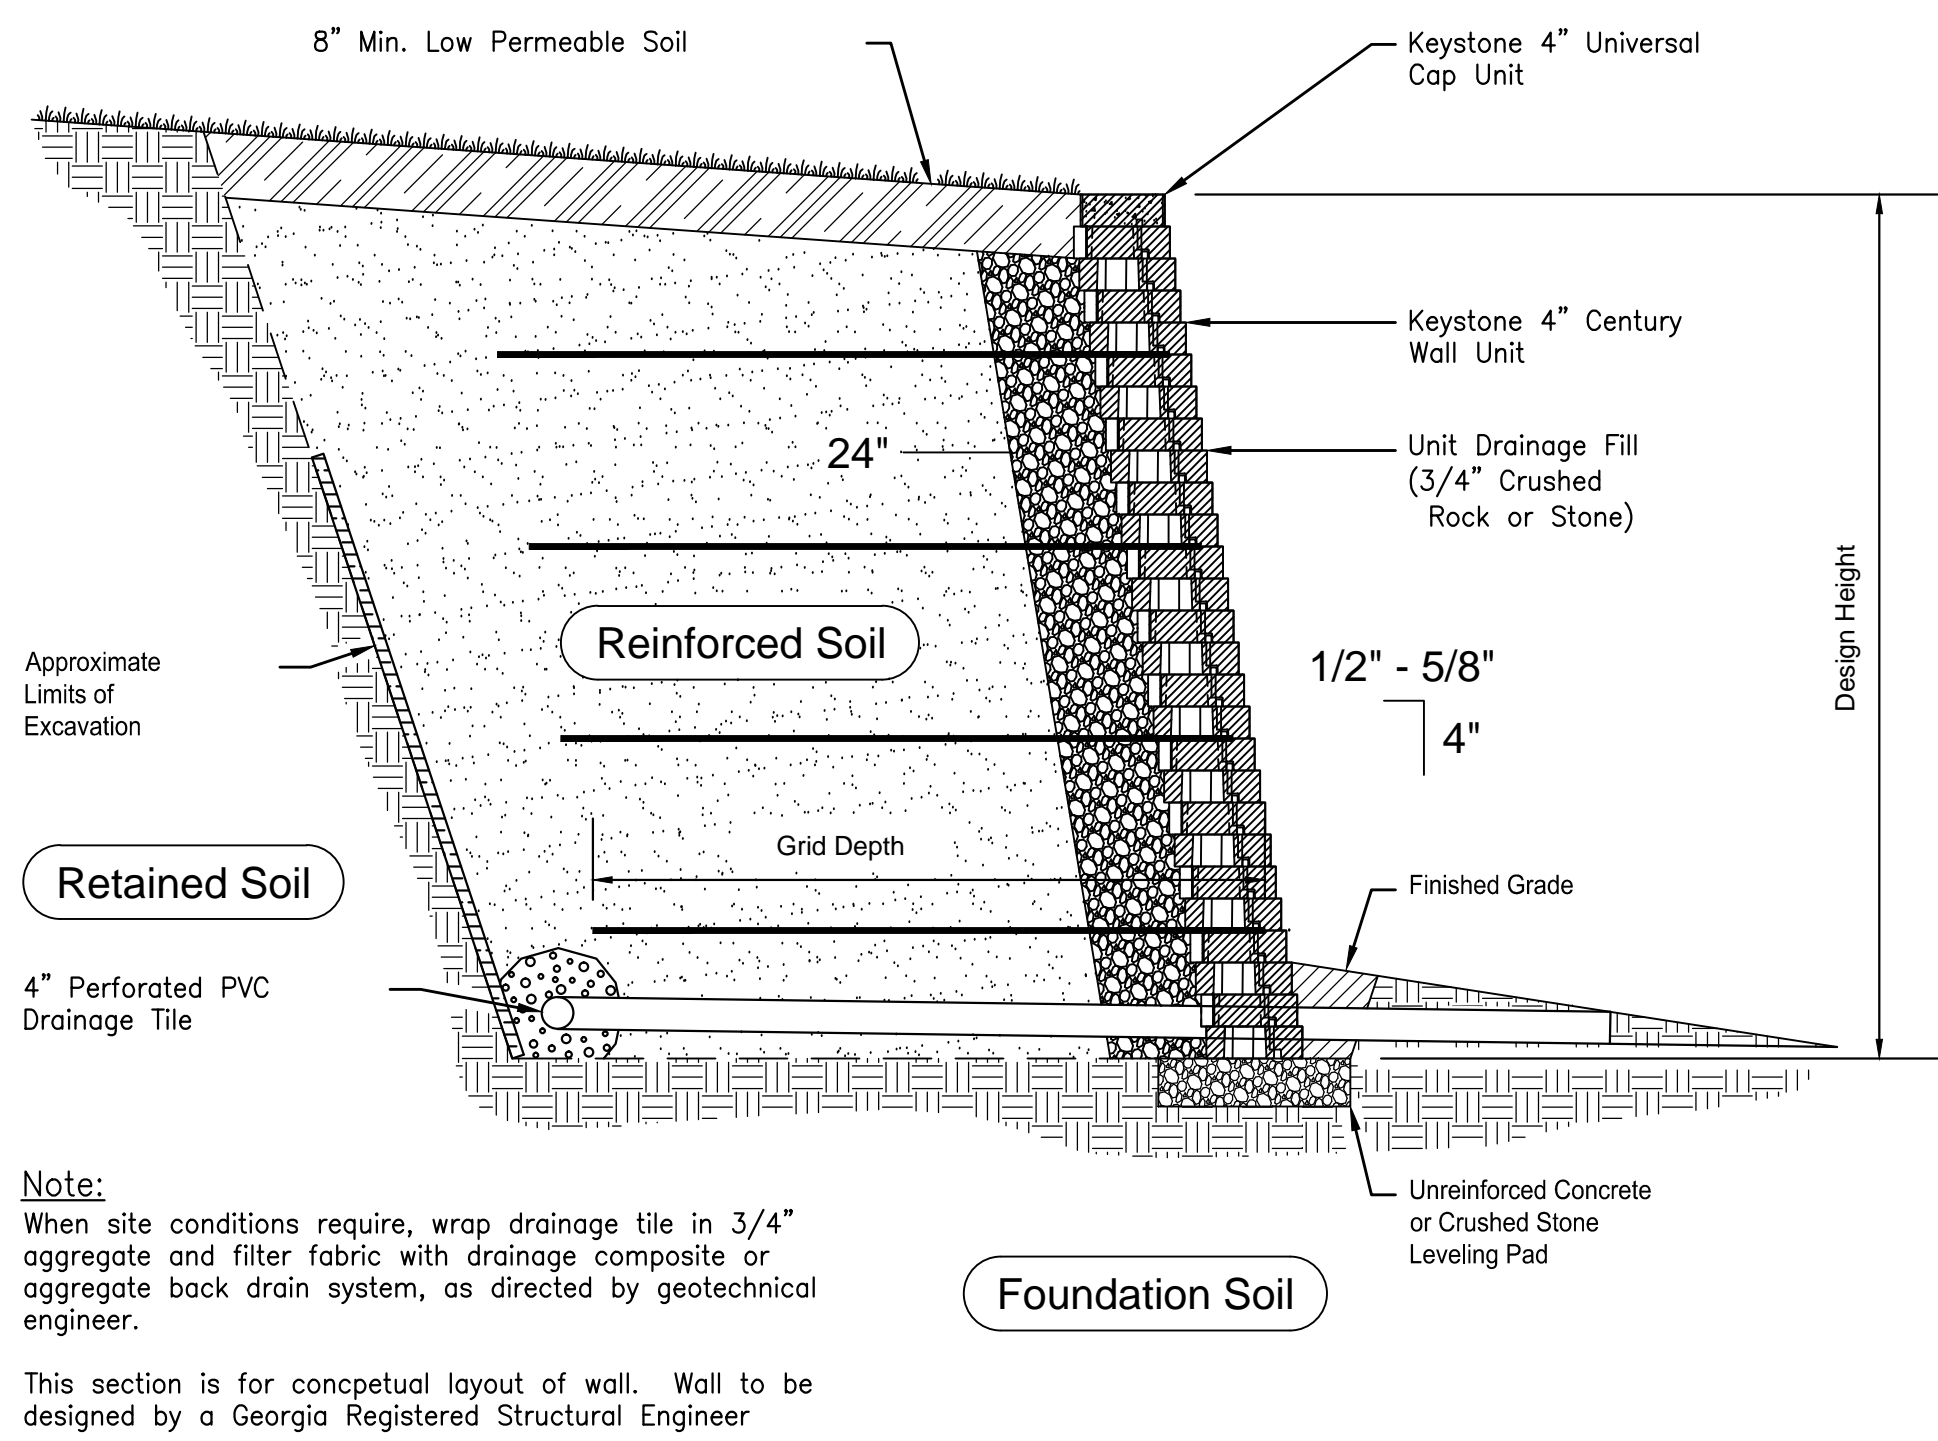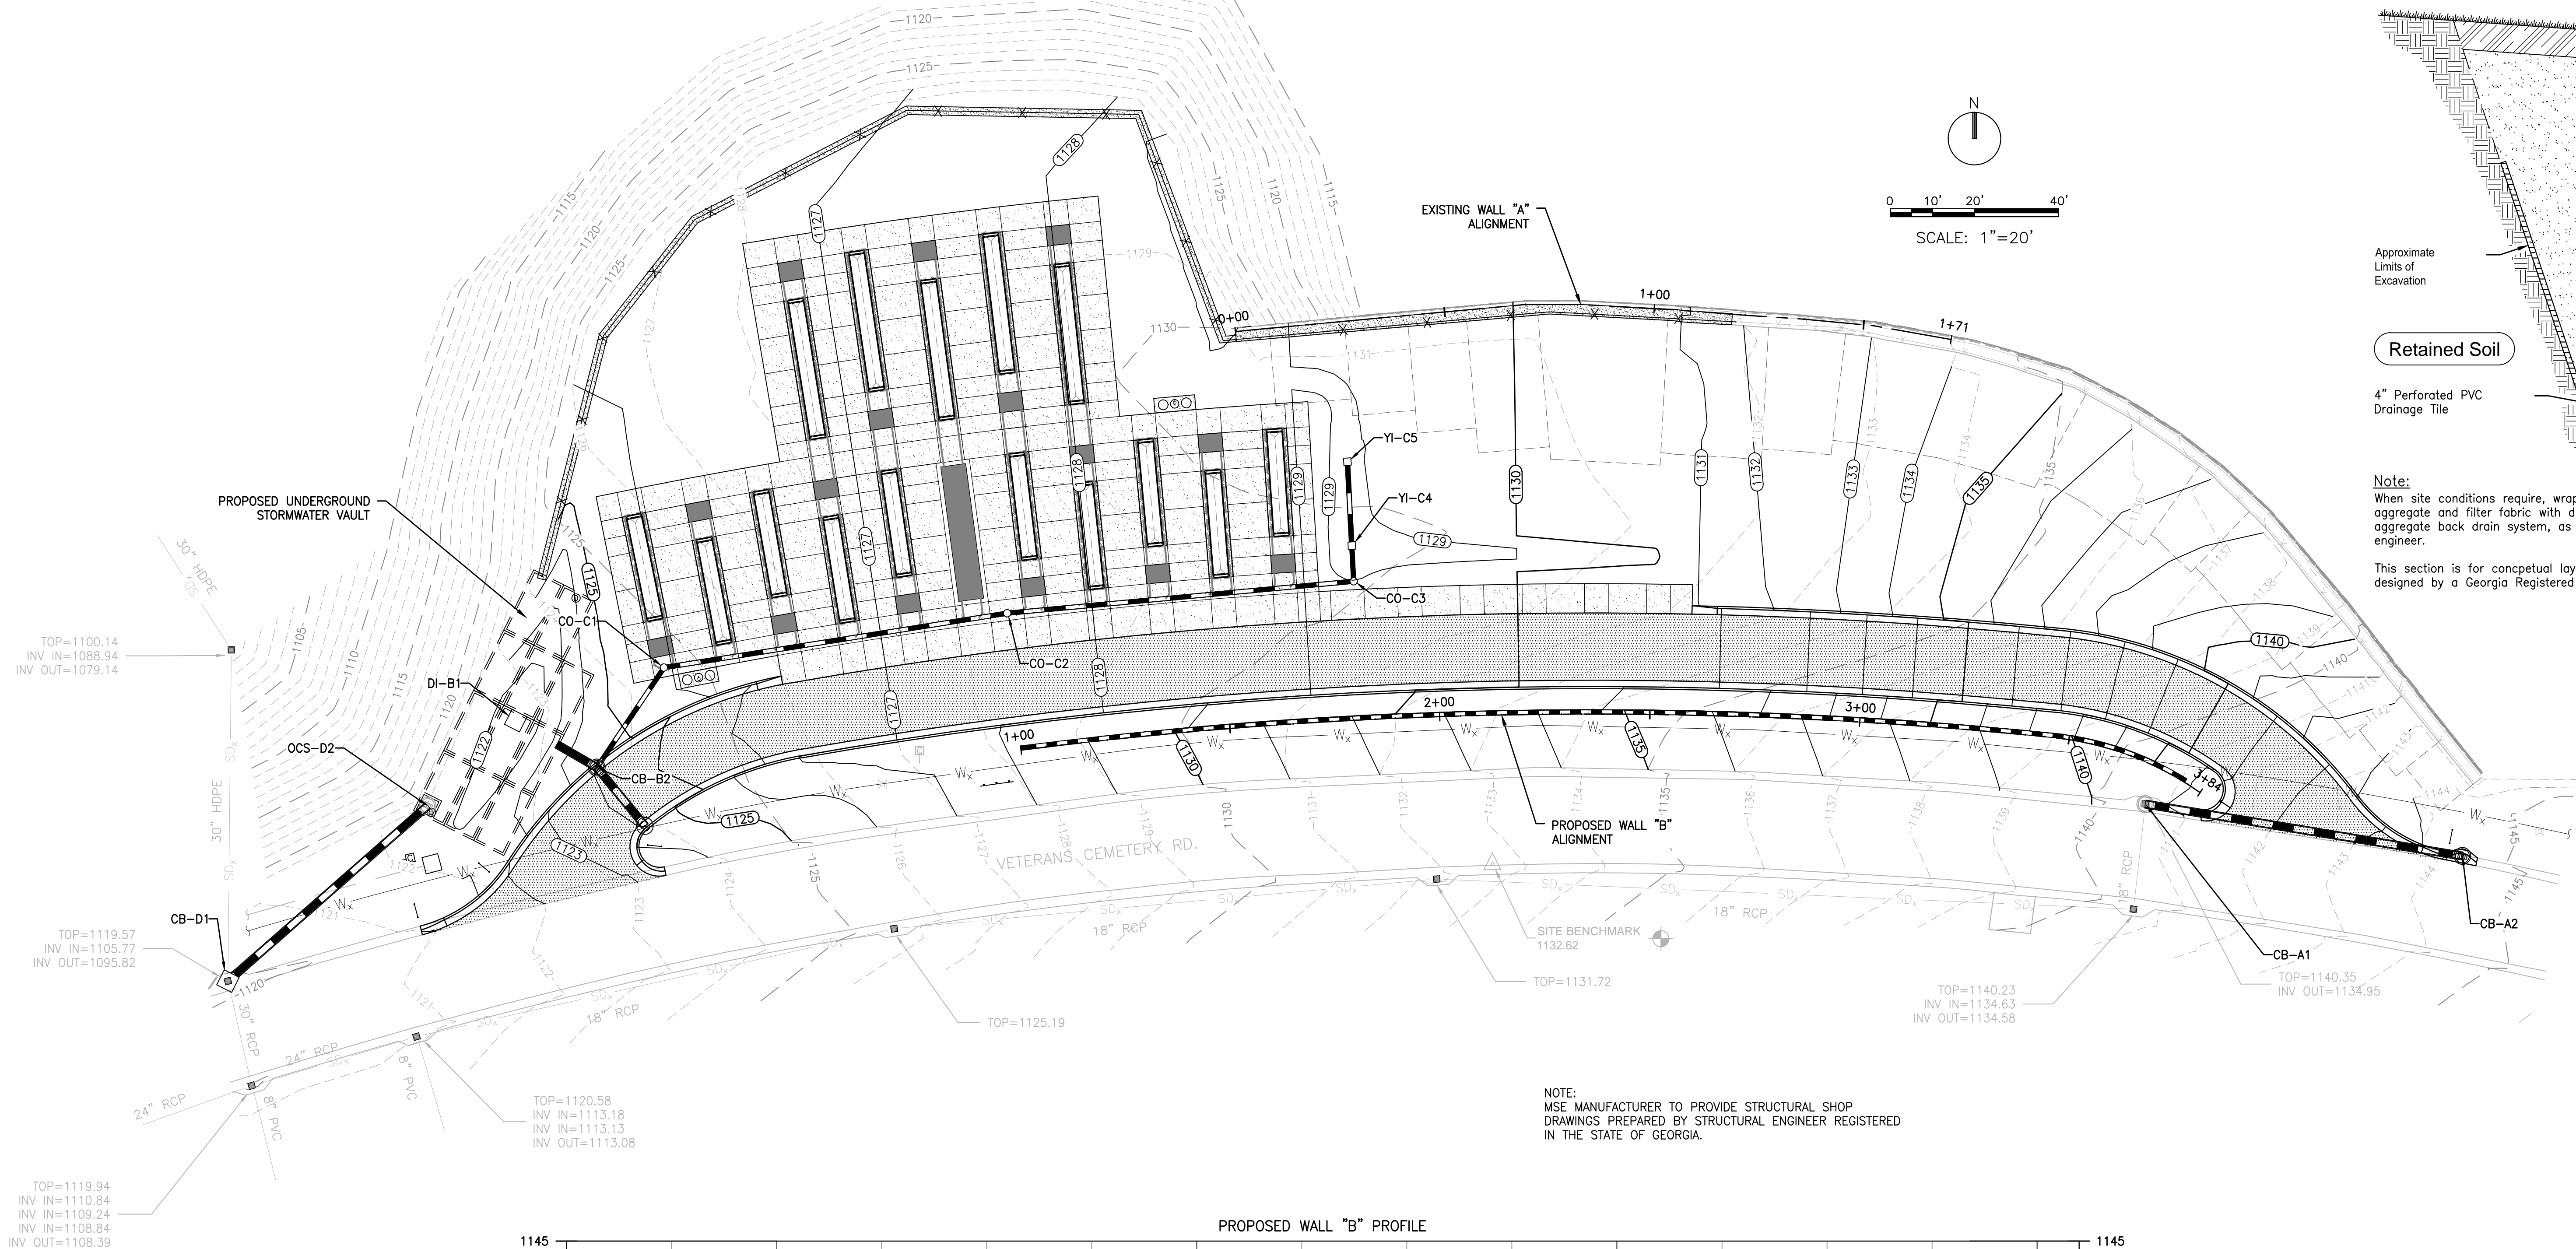


2 EXISTING WALL "A" CAP REINSTALLATION

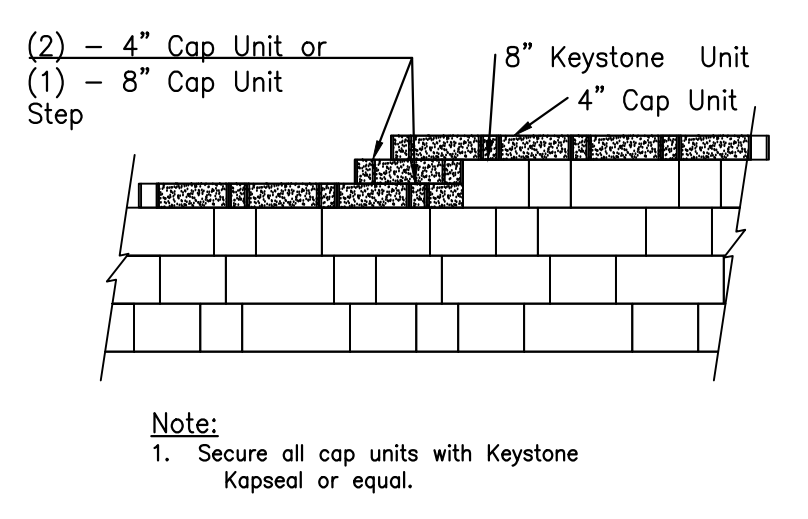
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<p>Revisions</p>		<p>Date</p>											

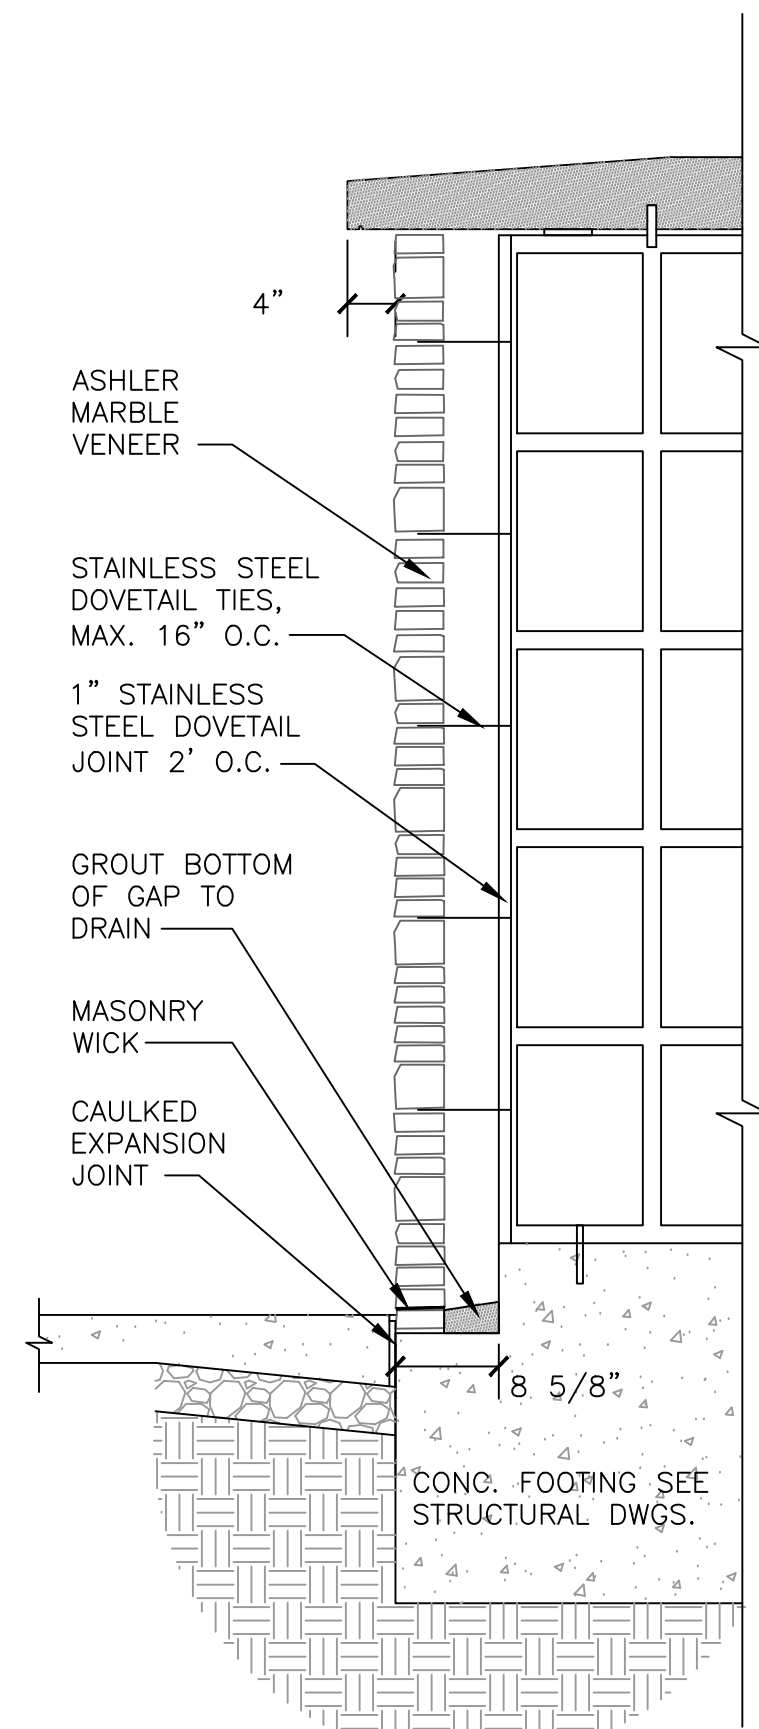

8 END OF WALL SECTION
3/4" = 1'-0"

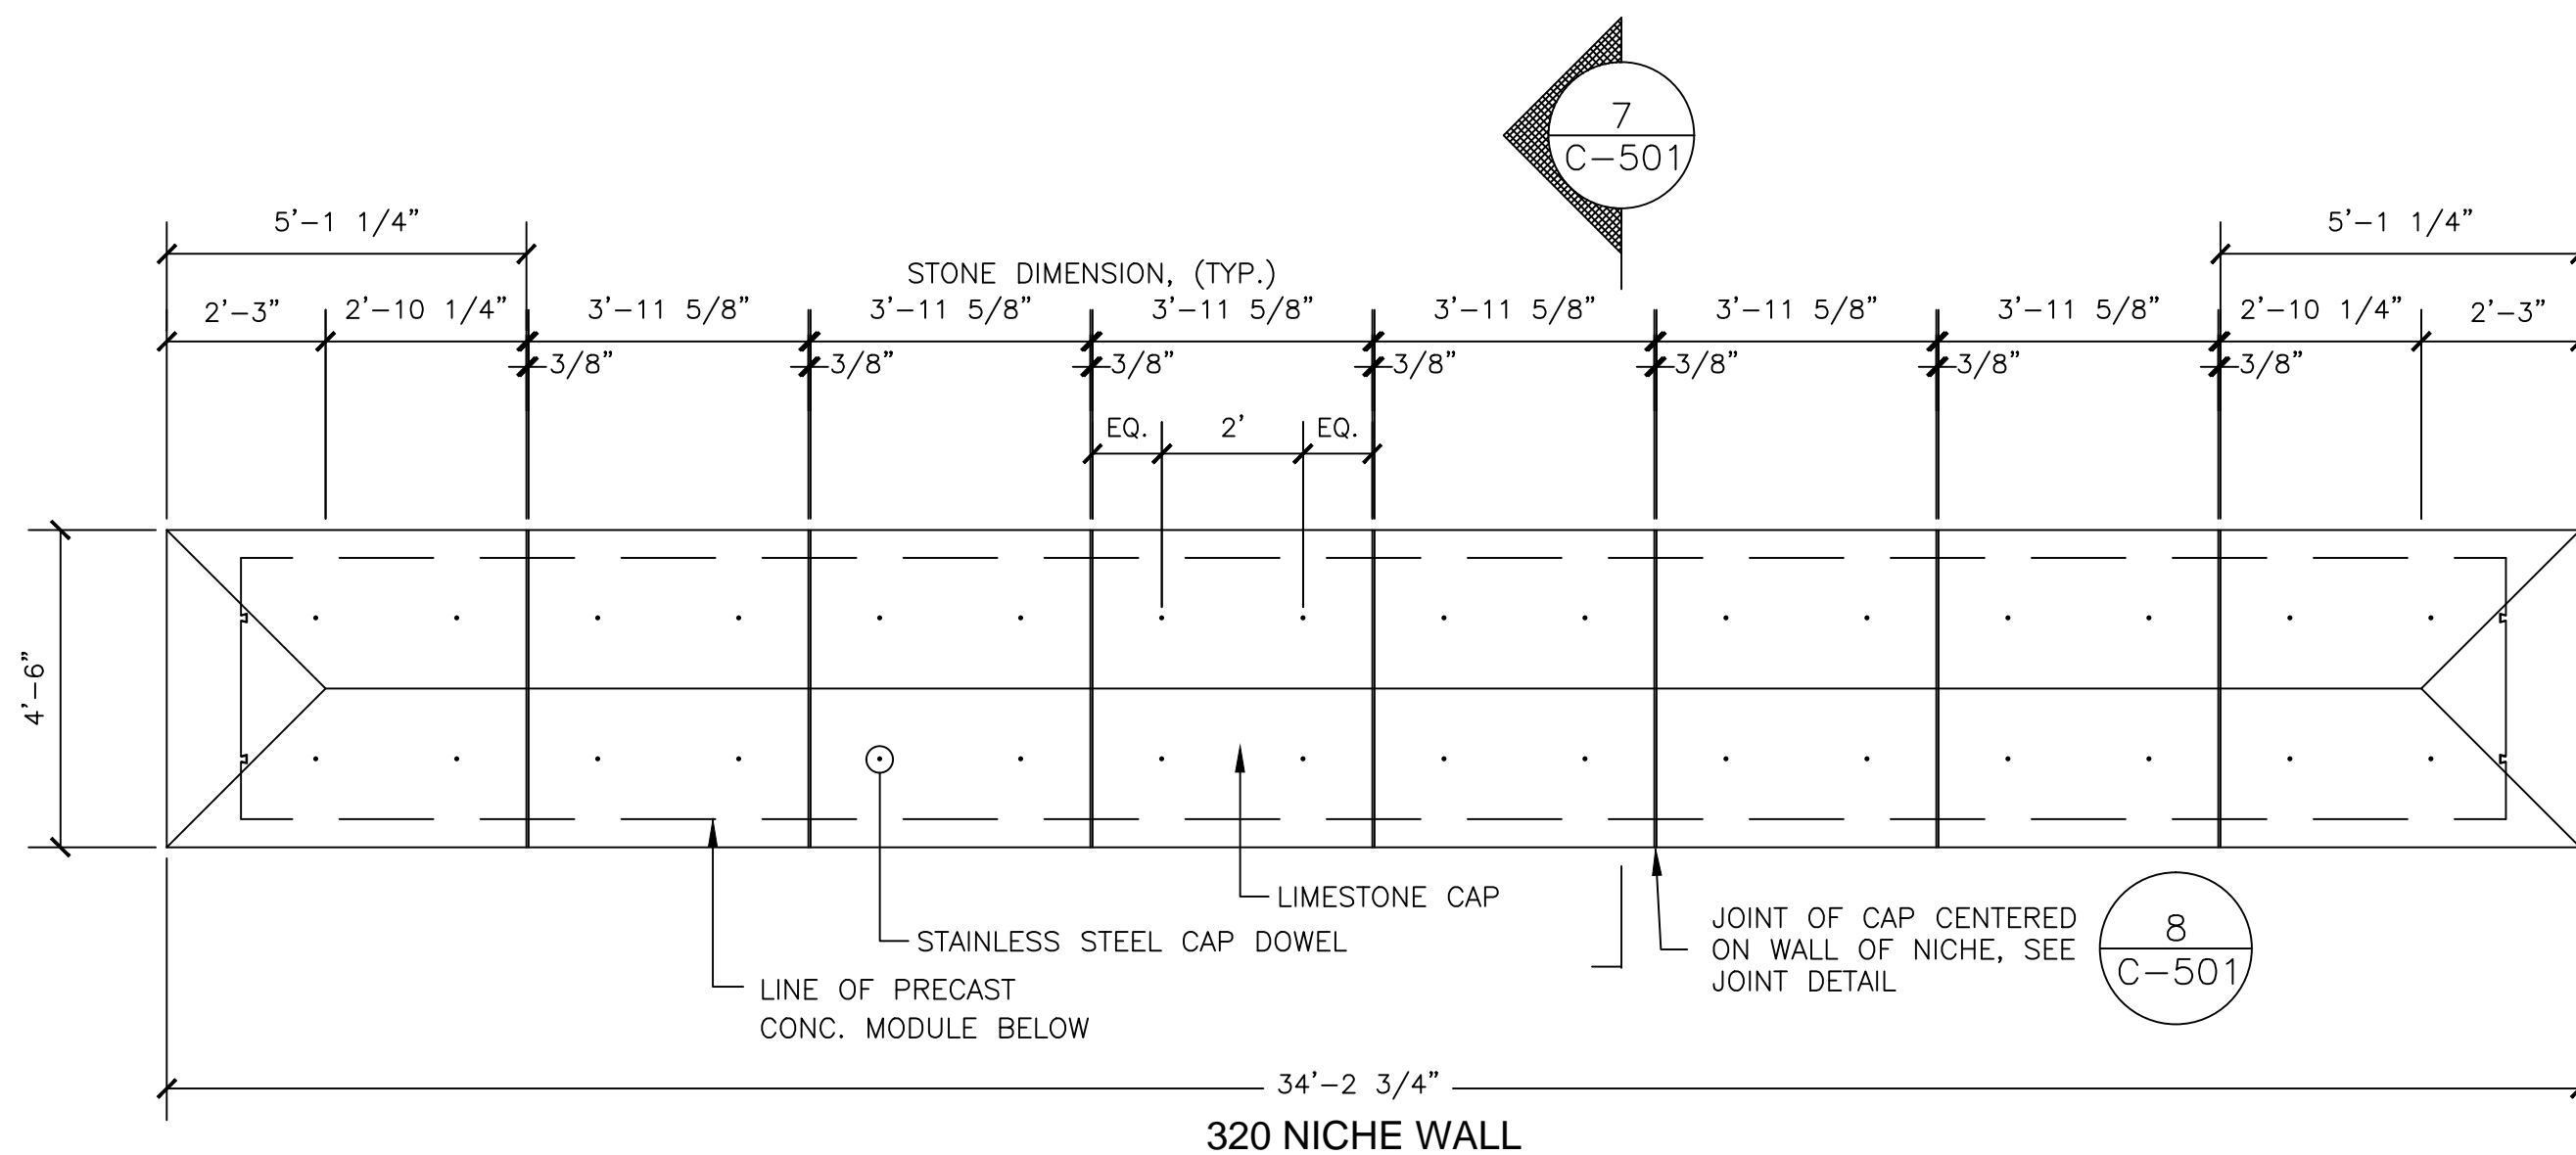


320 NICHE WALL

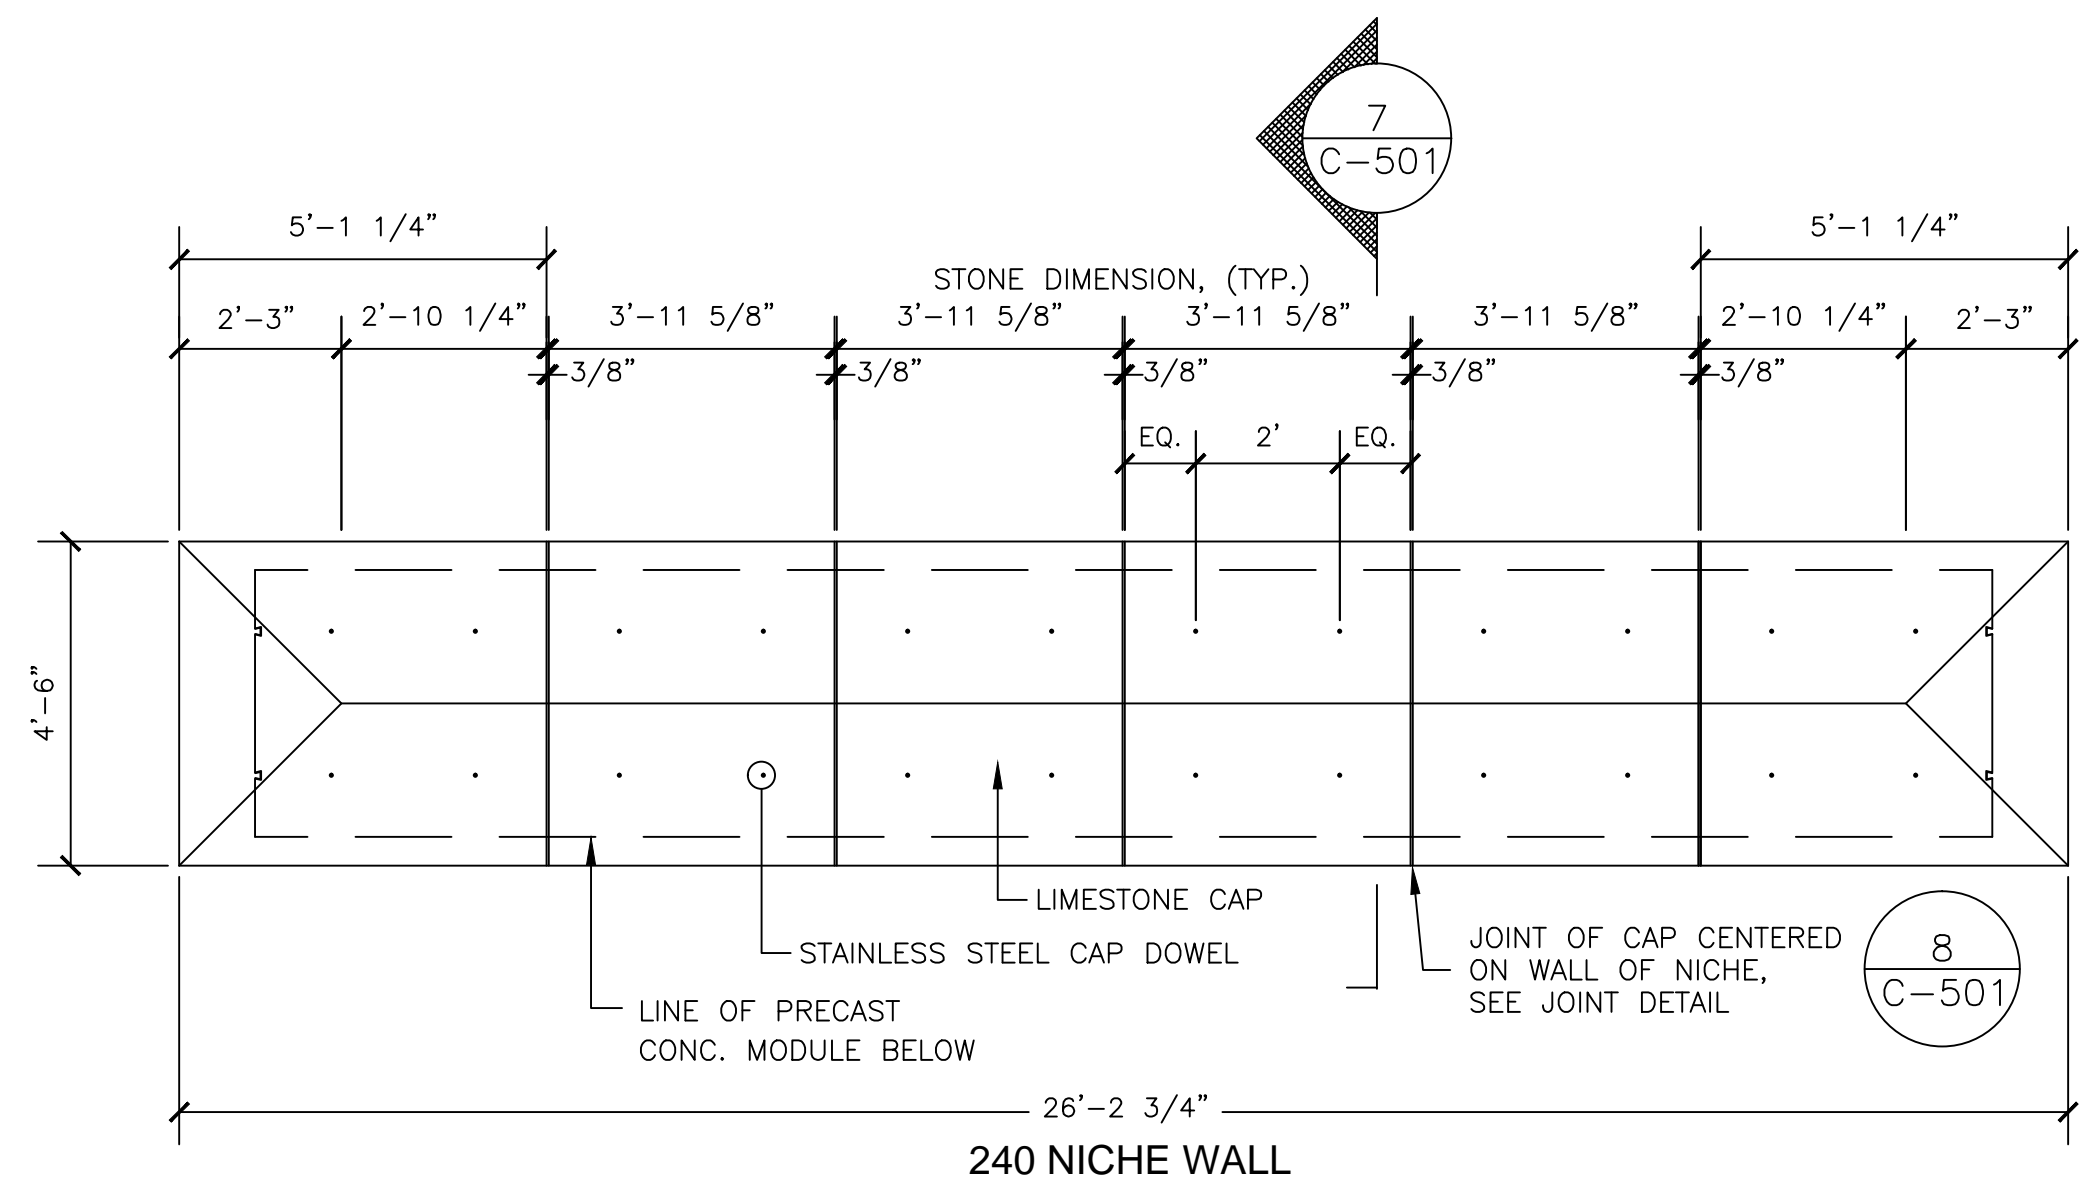


240 NICHE WALL

4 COLUMBARIA CAP JOINT DETAIL
3/8" = 1'-0"

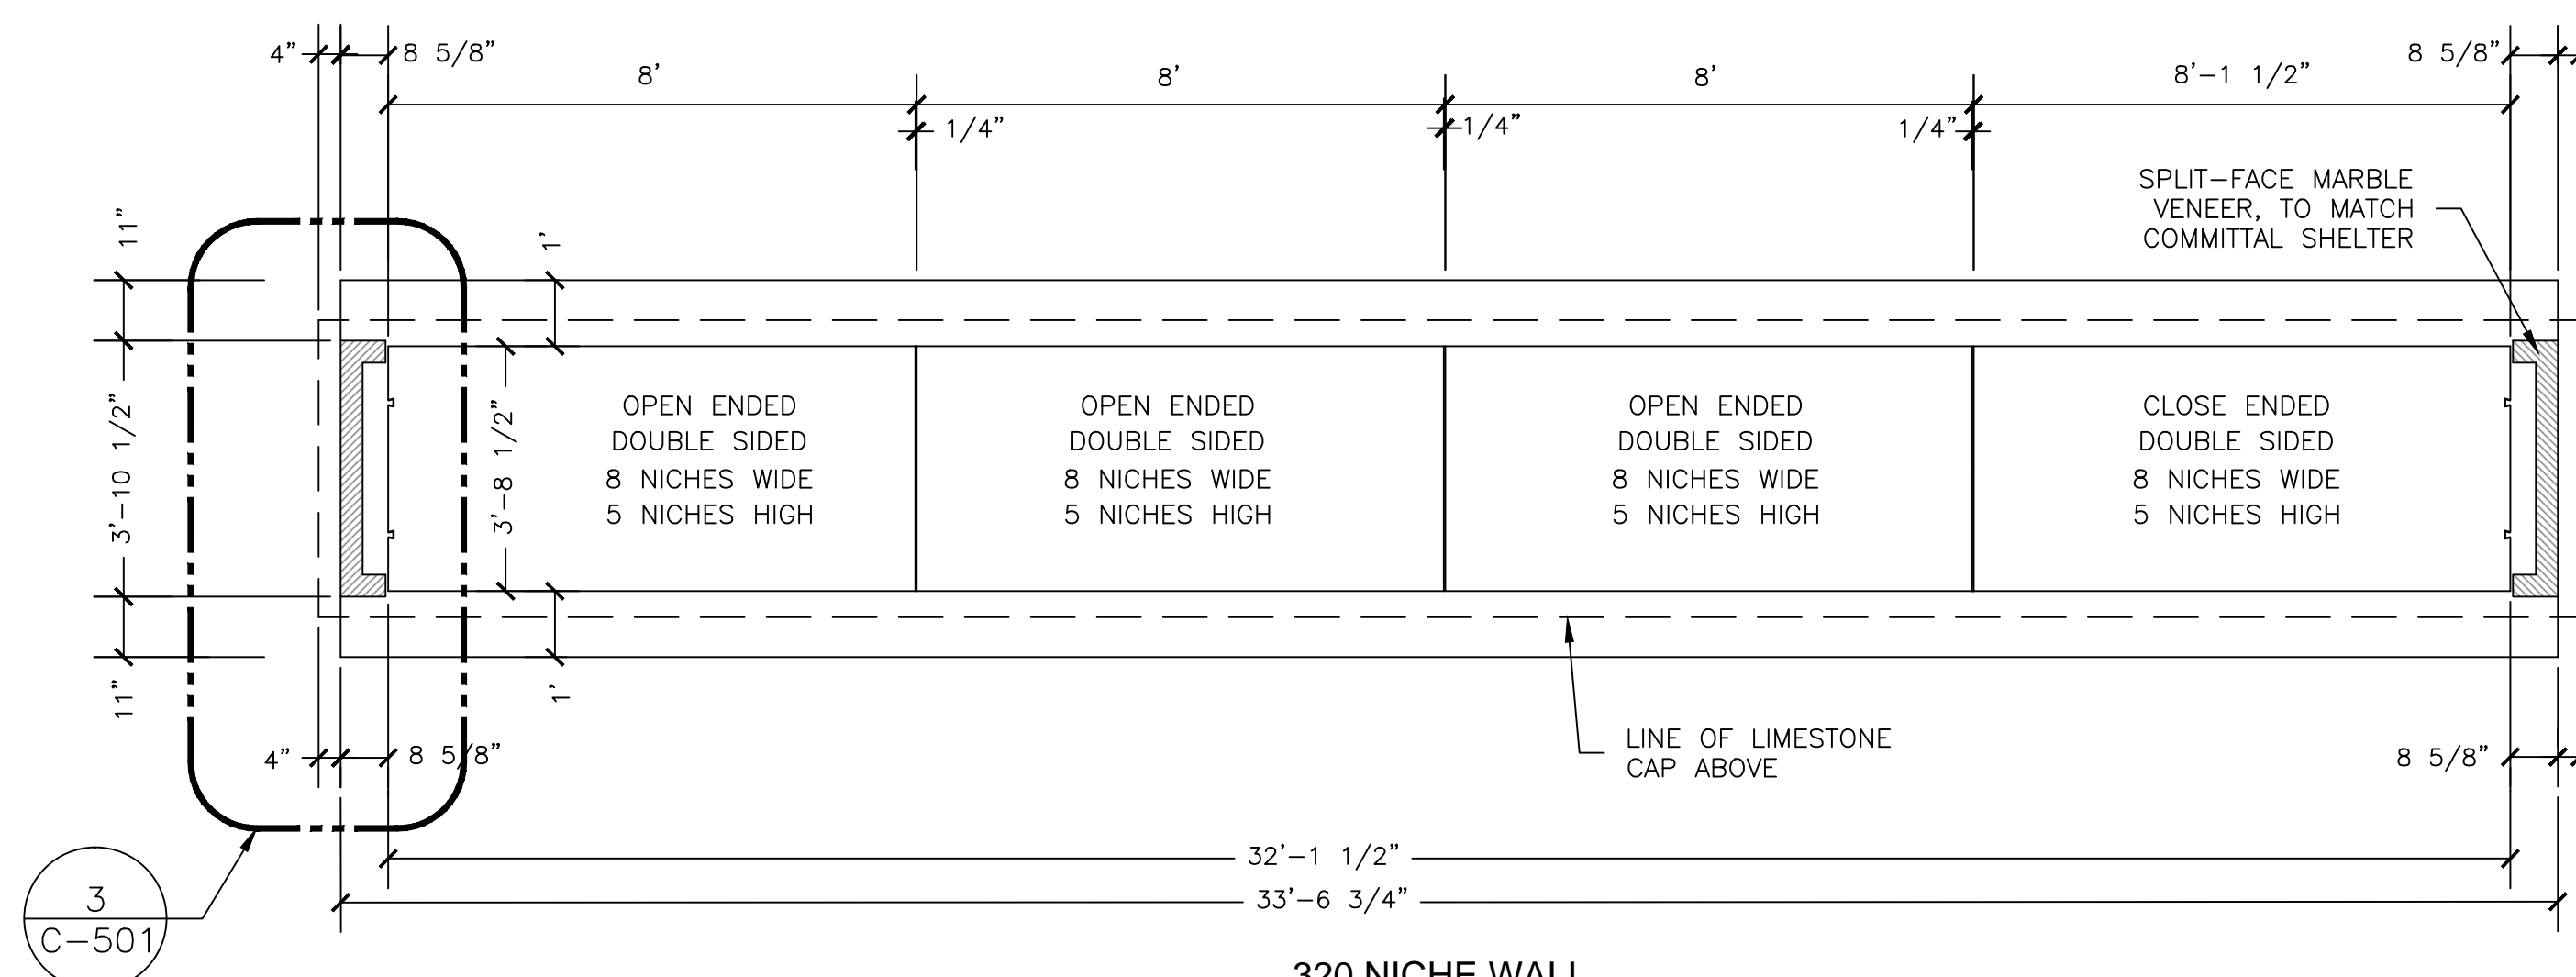


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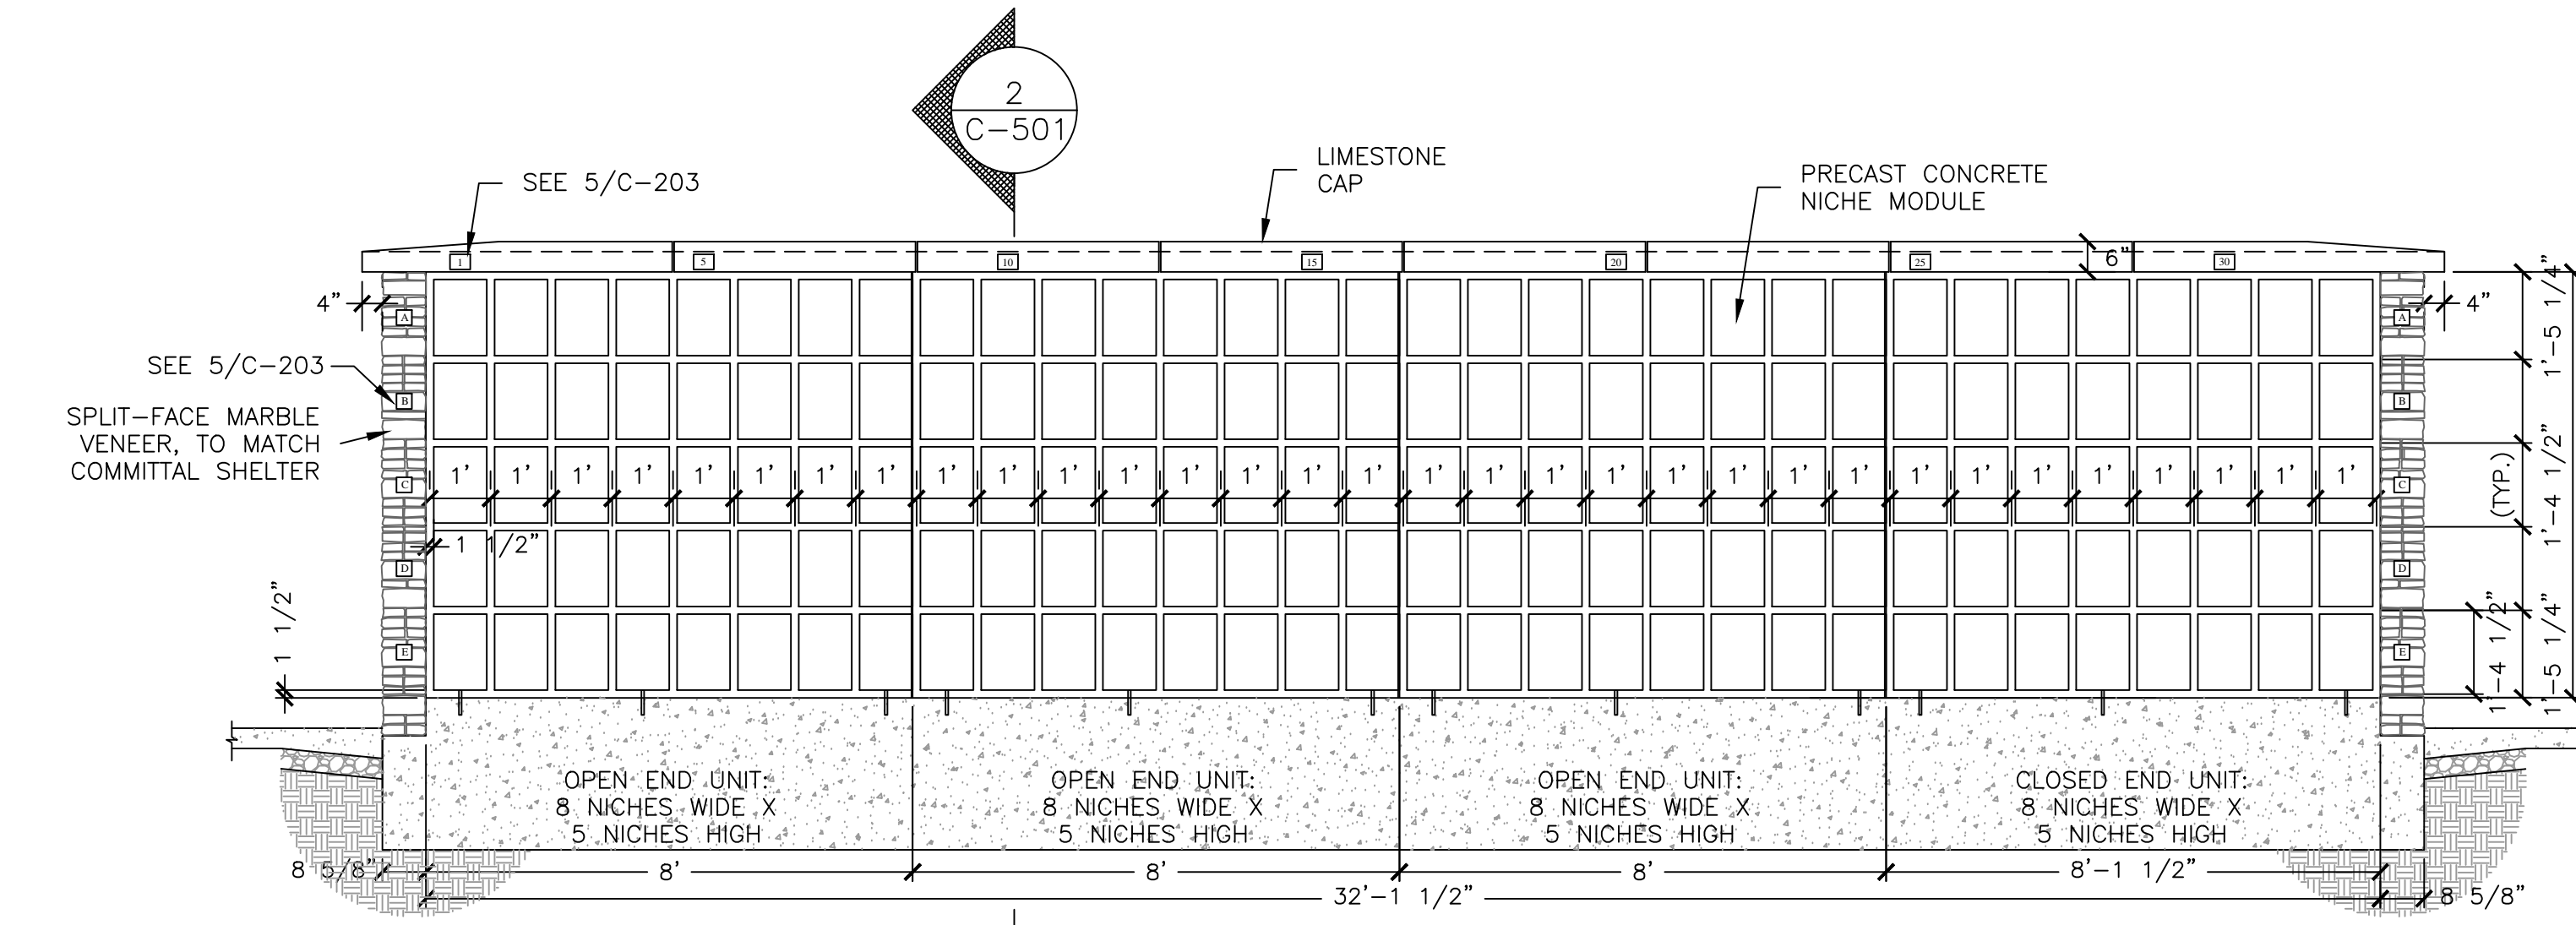

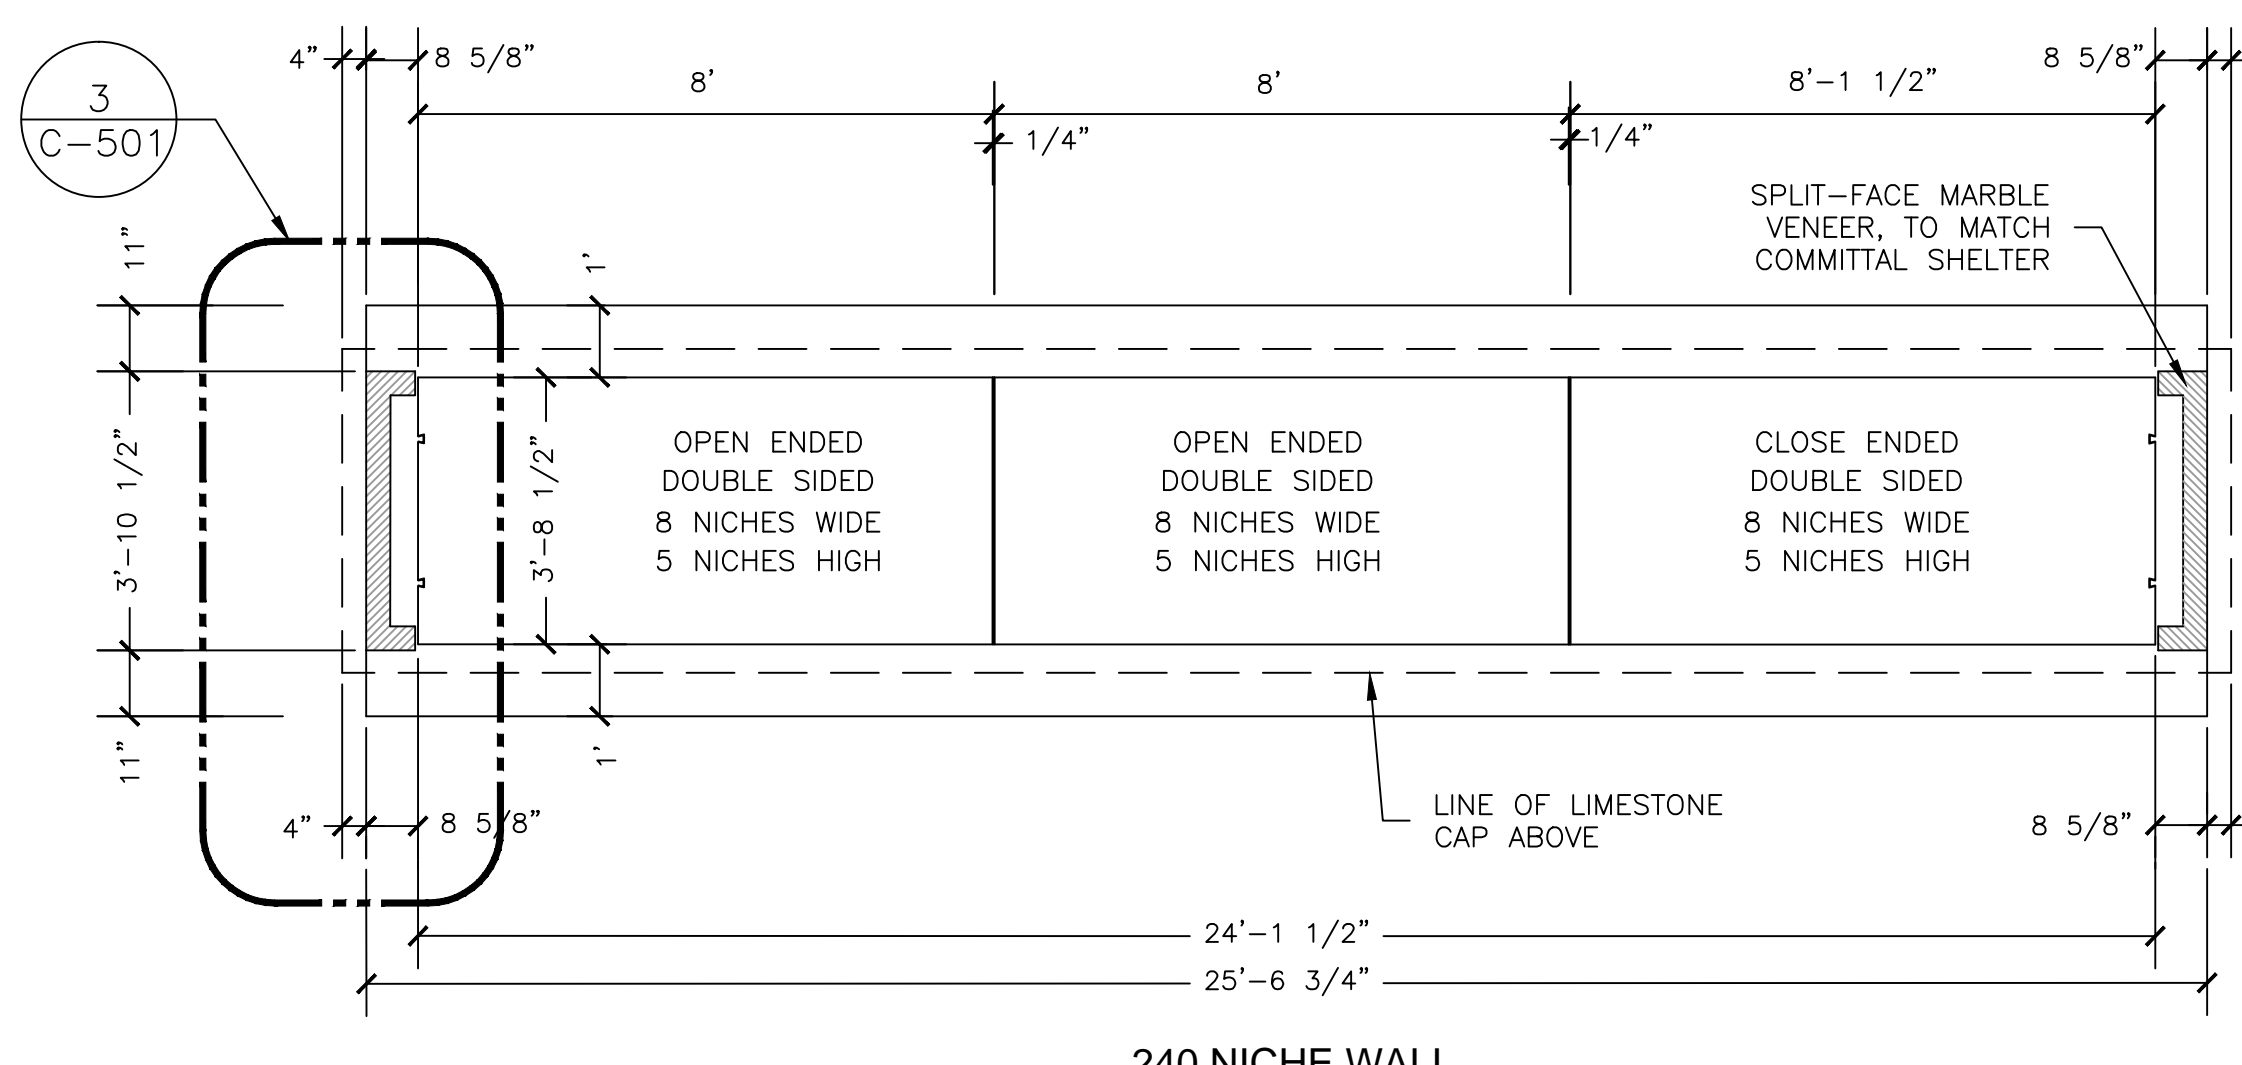
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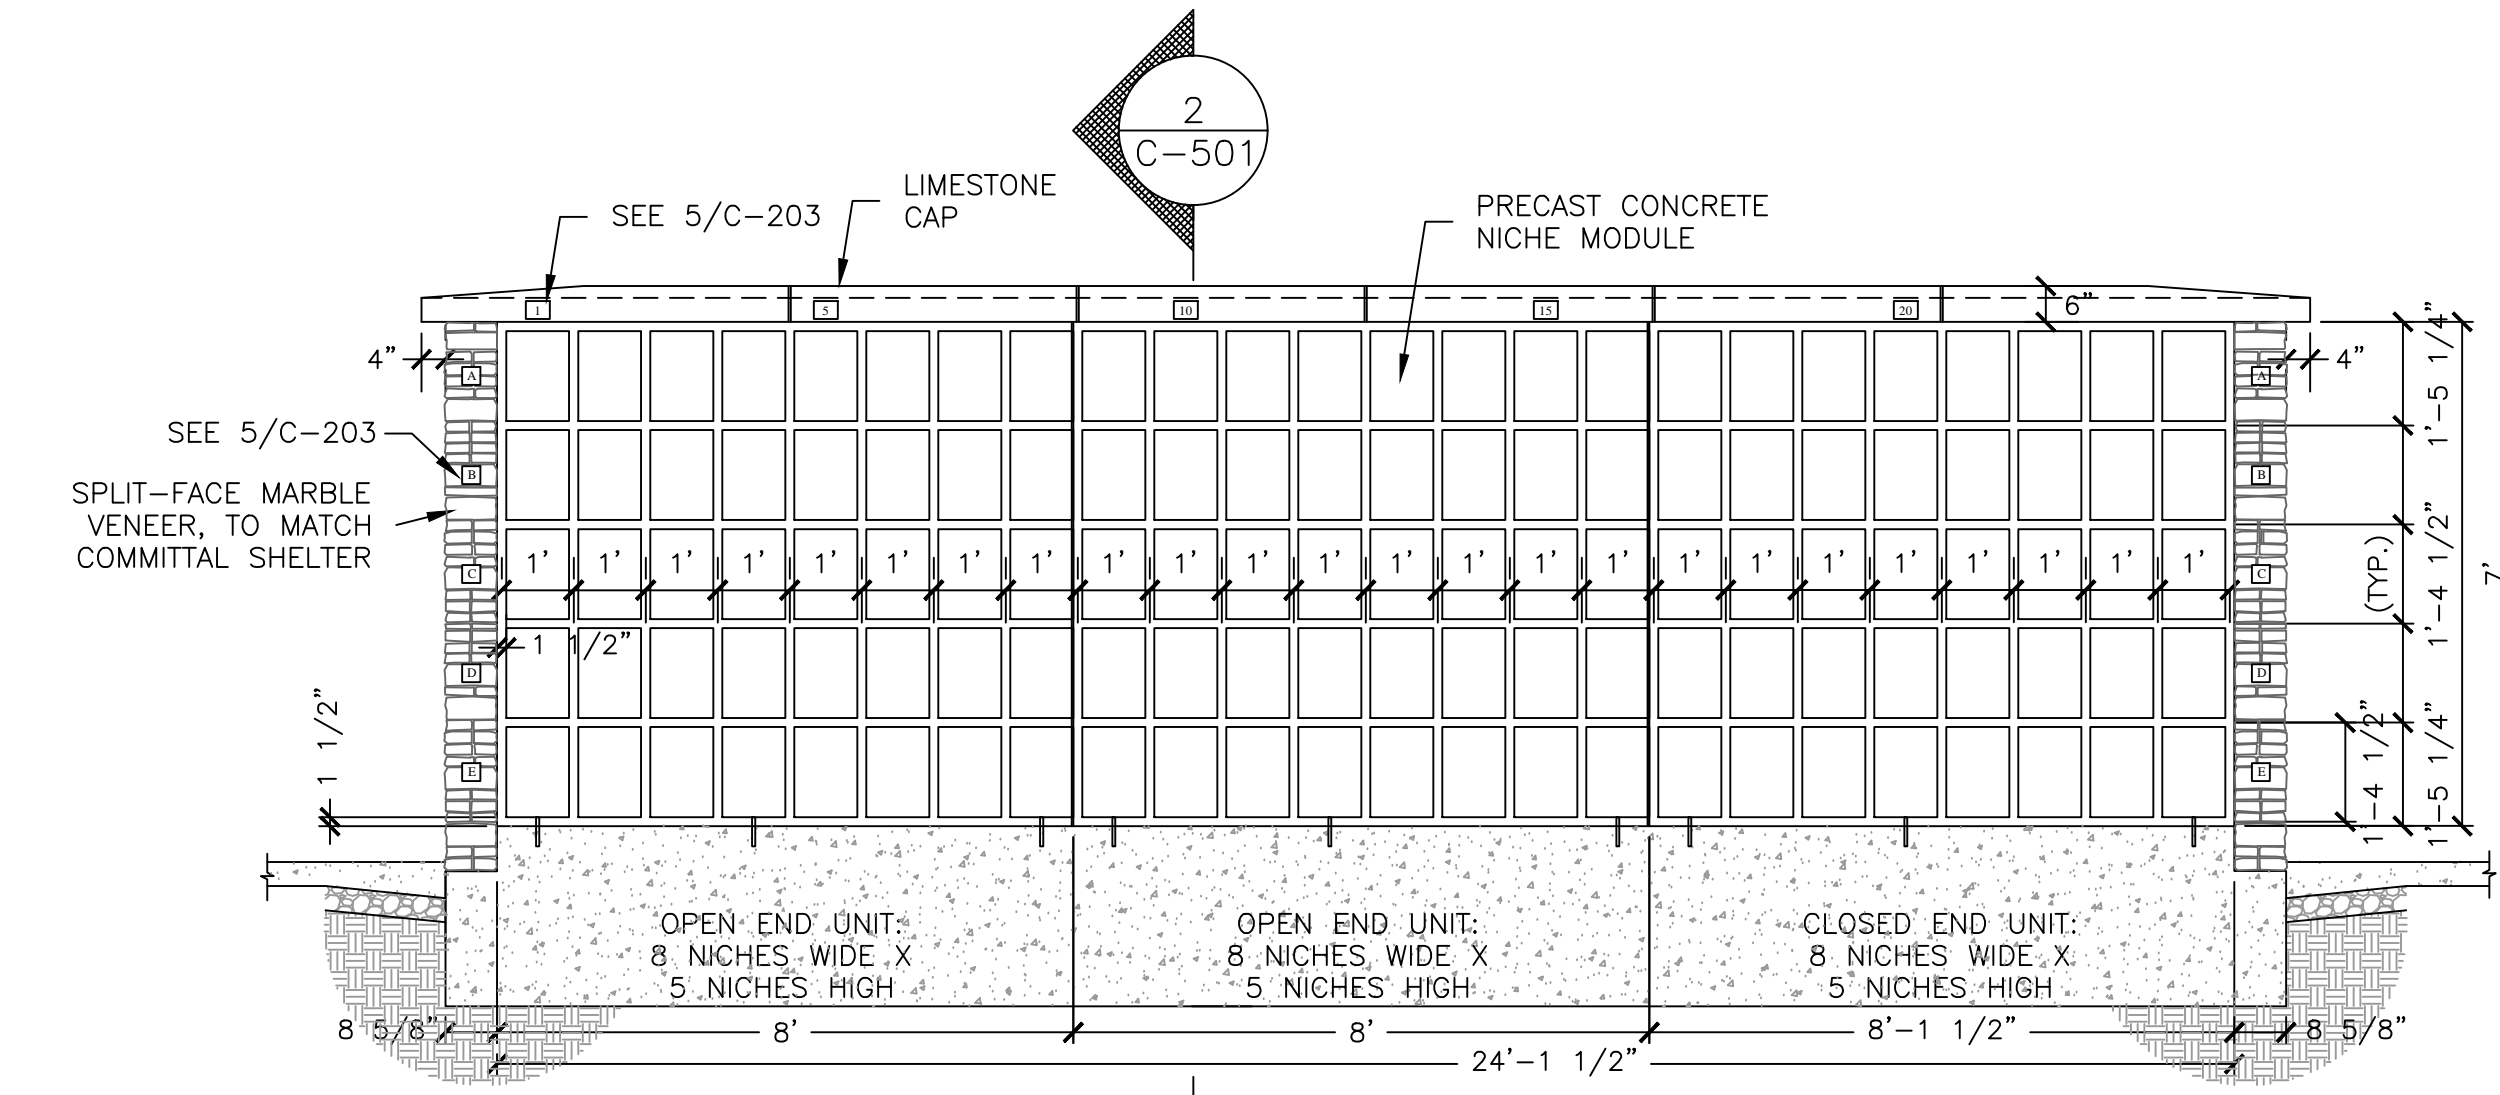
5 NICHE UNIT LAYOUT DETAIL
3/8" = 1'-0"



2 SECTION THRU FREE-STANDING COLUMBARIA
3/4" = 1'-0"

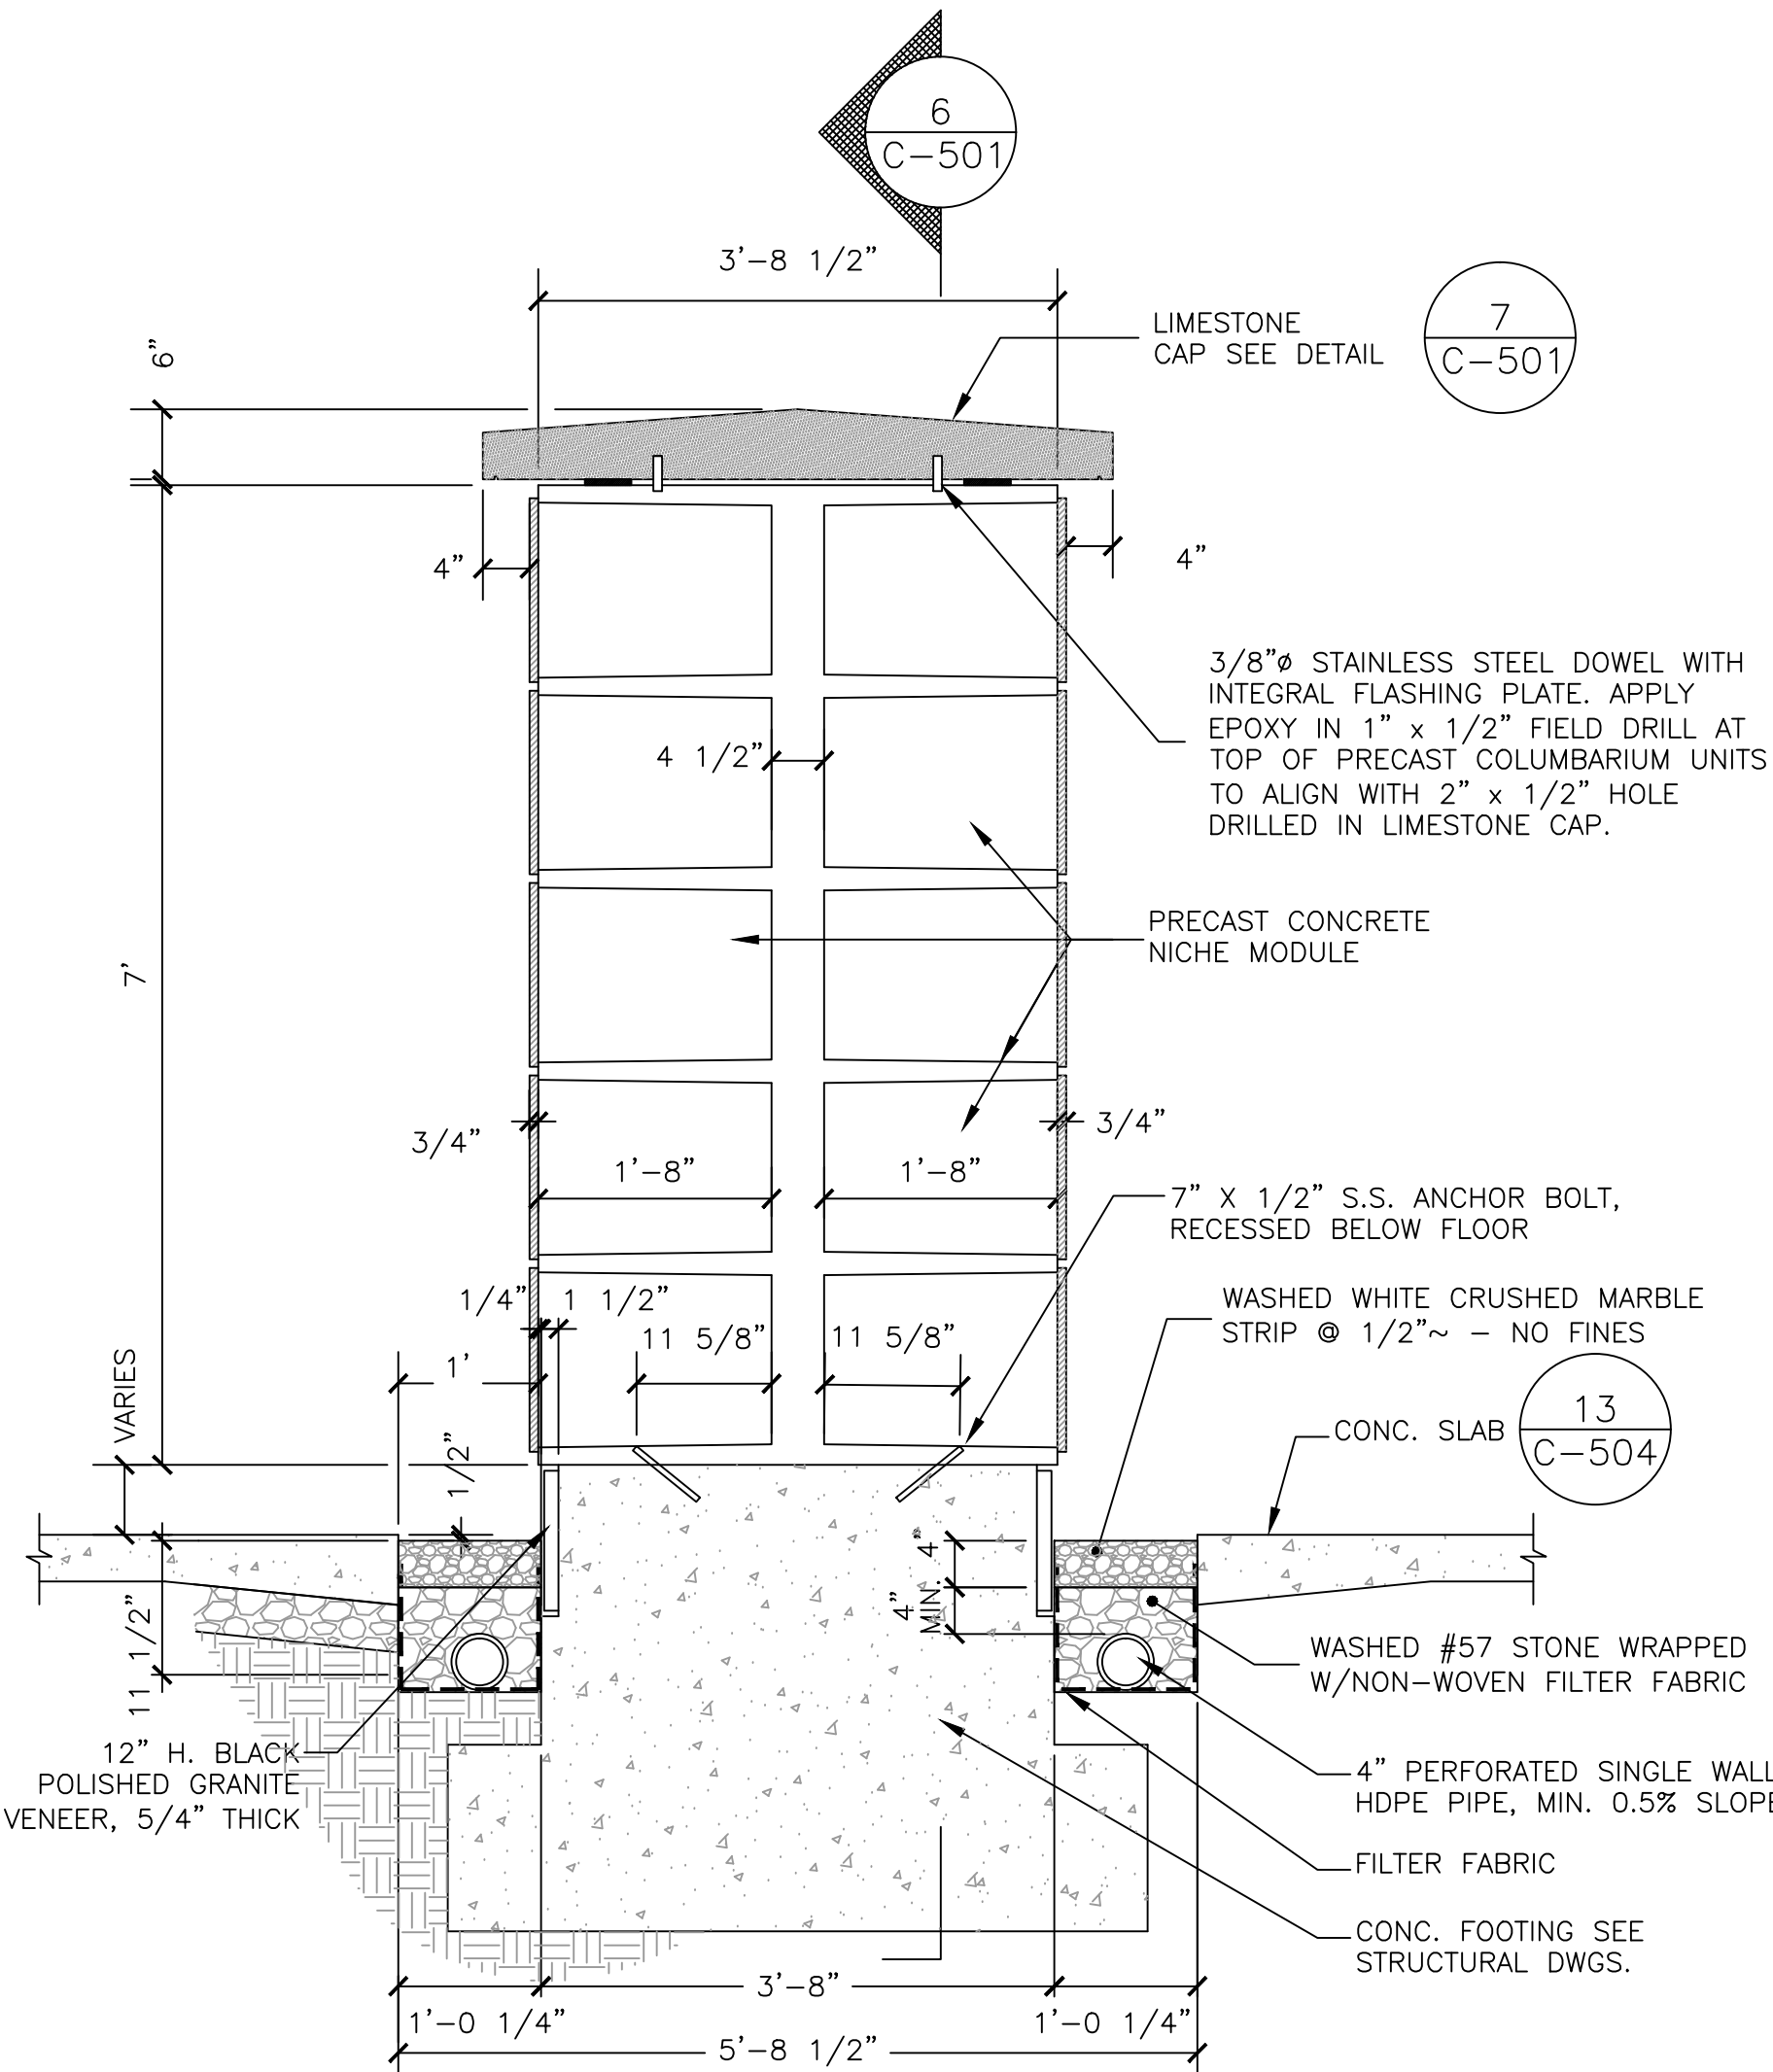


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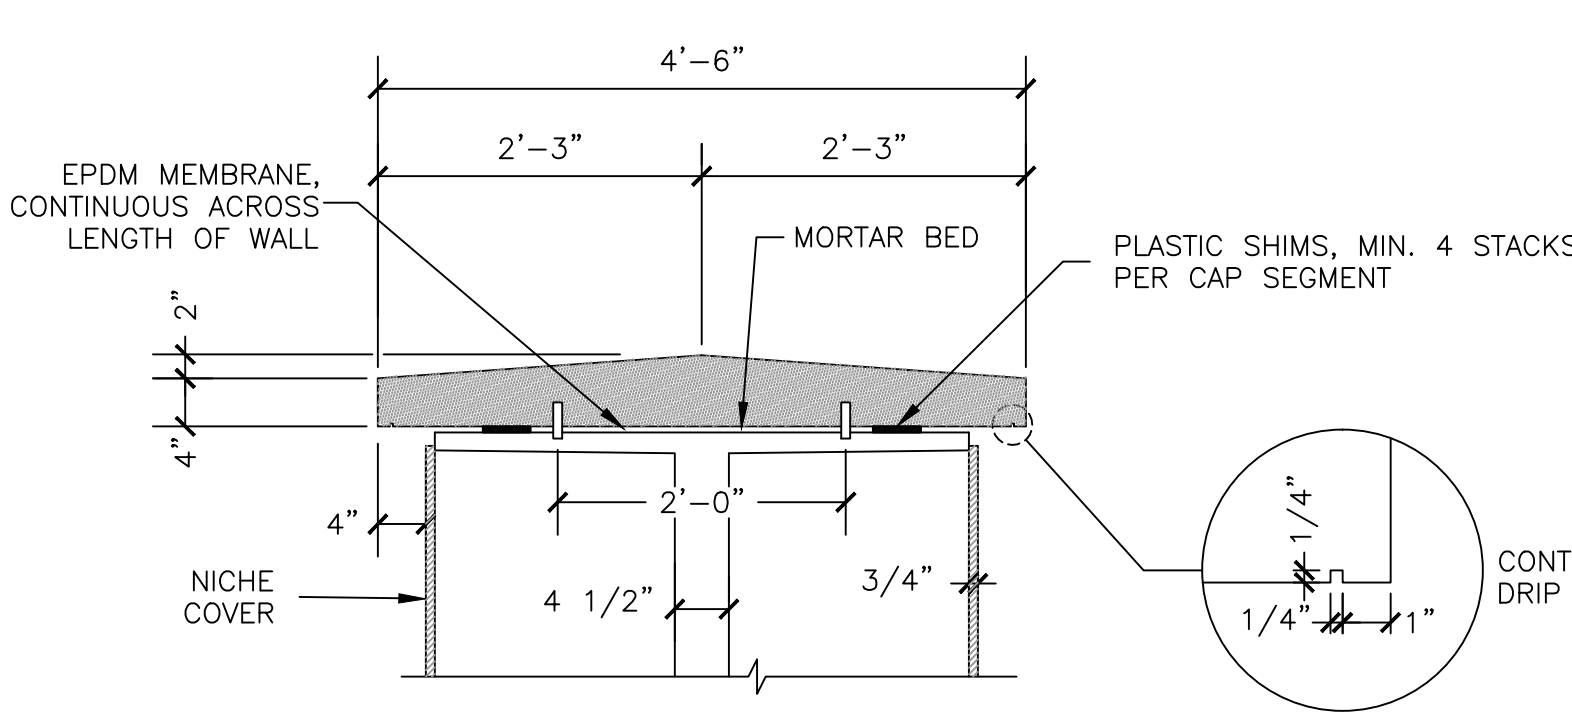


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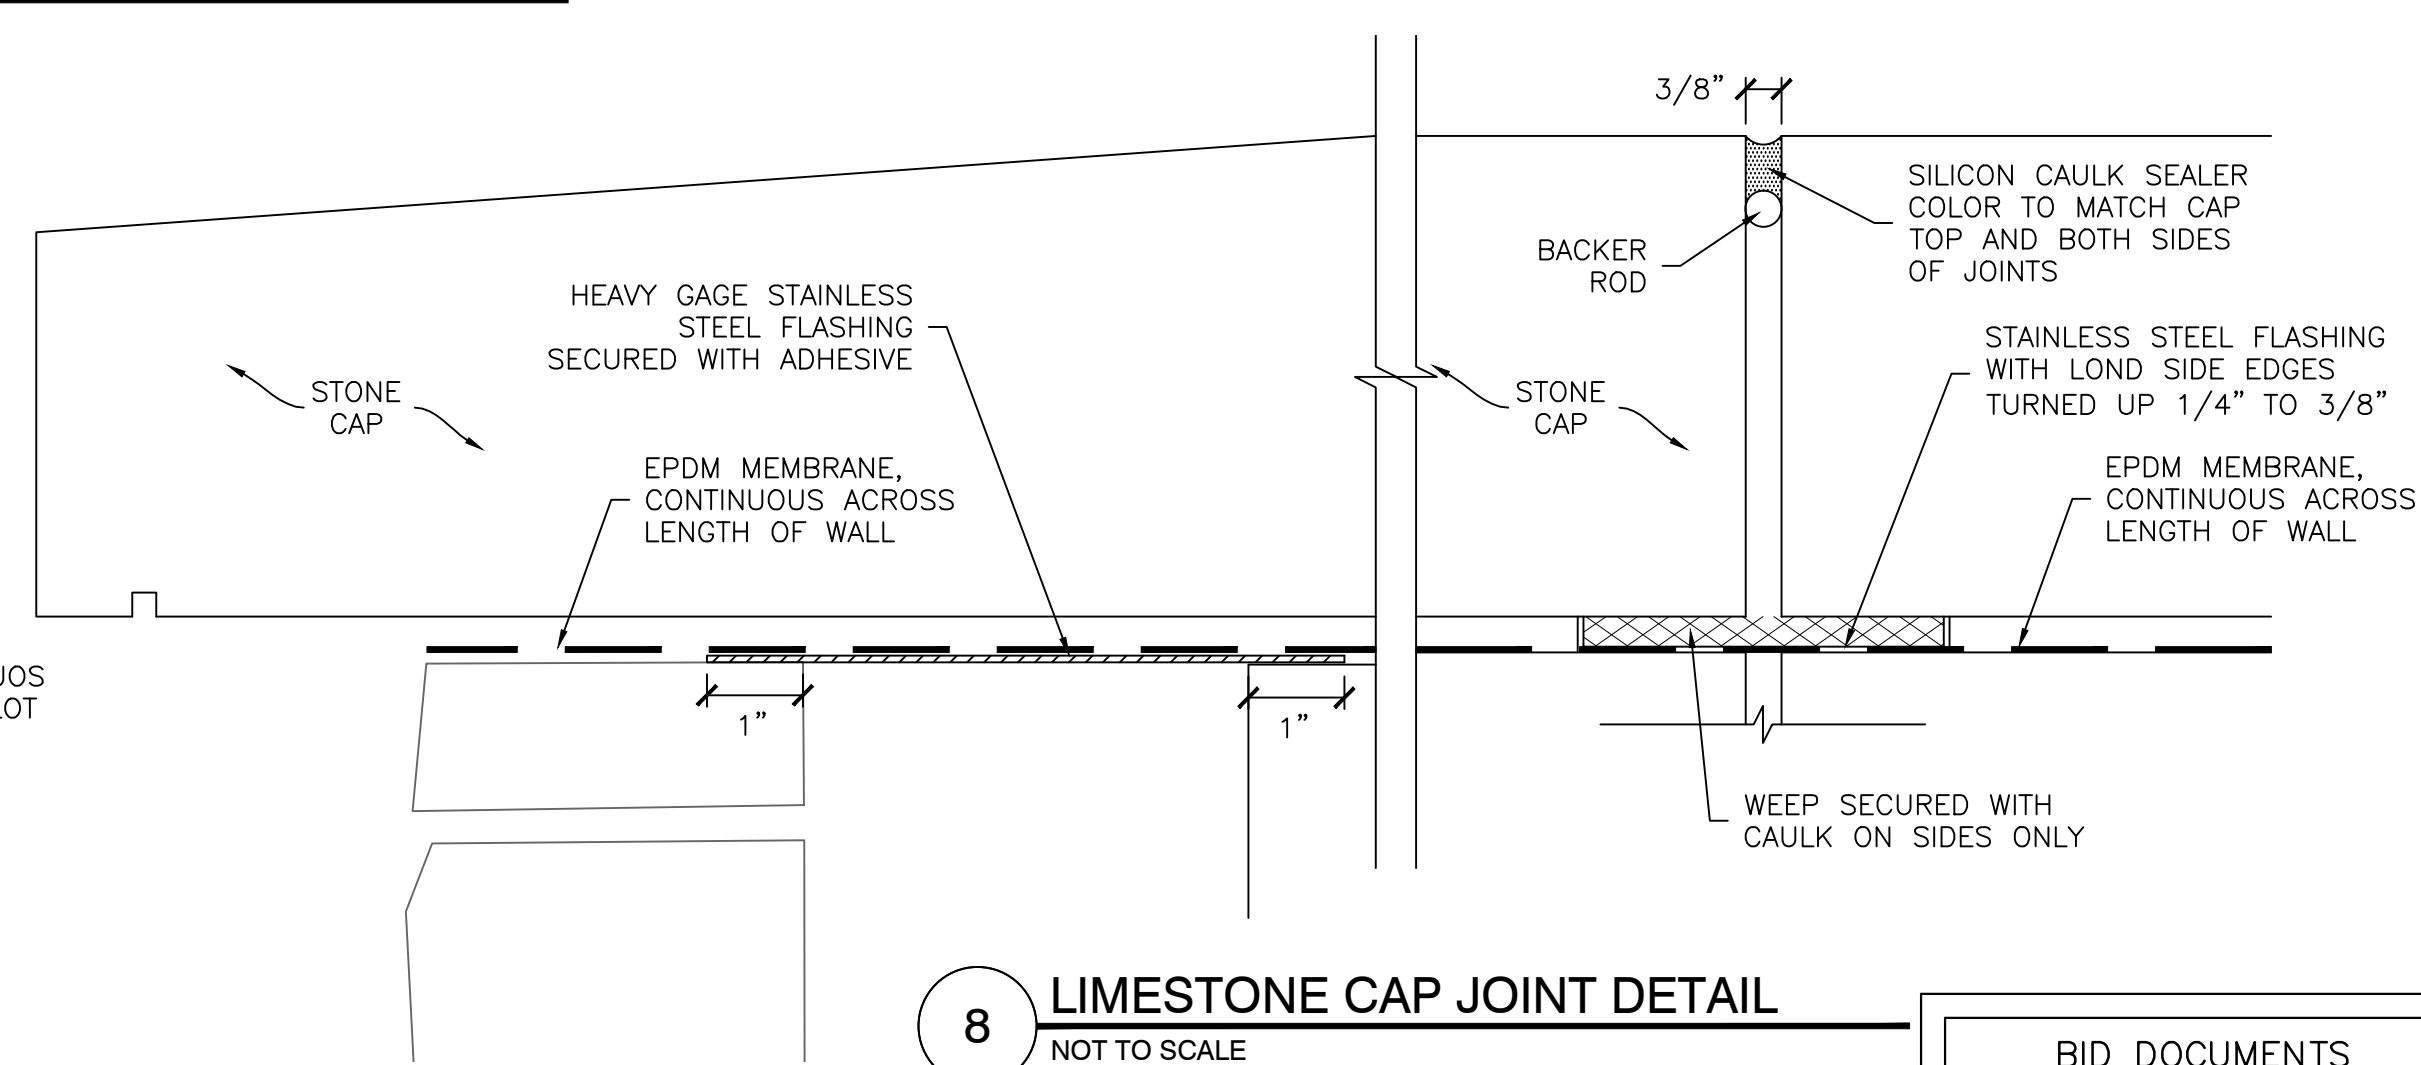
6 NICHE UNIT SIDE VIEW DETAIL
3/8" = 1'-0"



3 END - FREE-STANDING NICHE
3/4" = 1'-0"

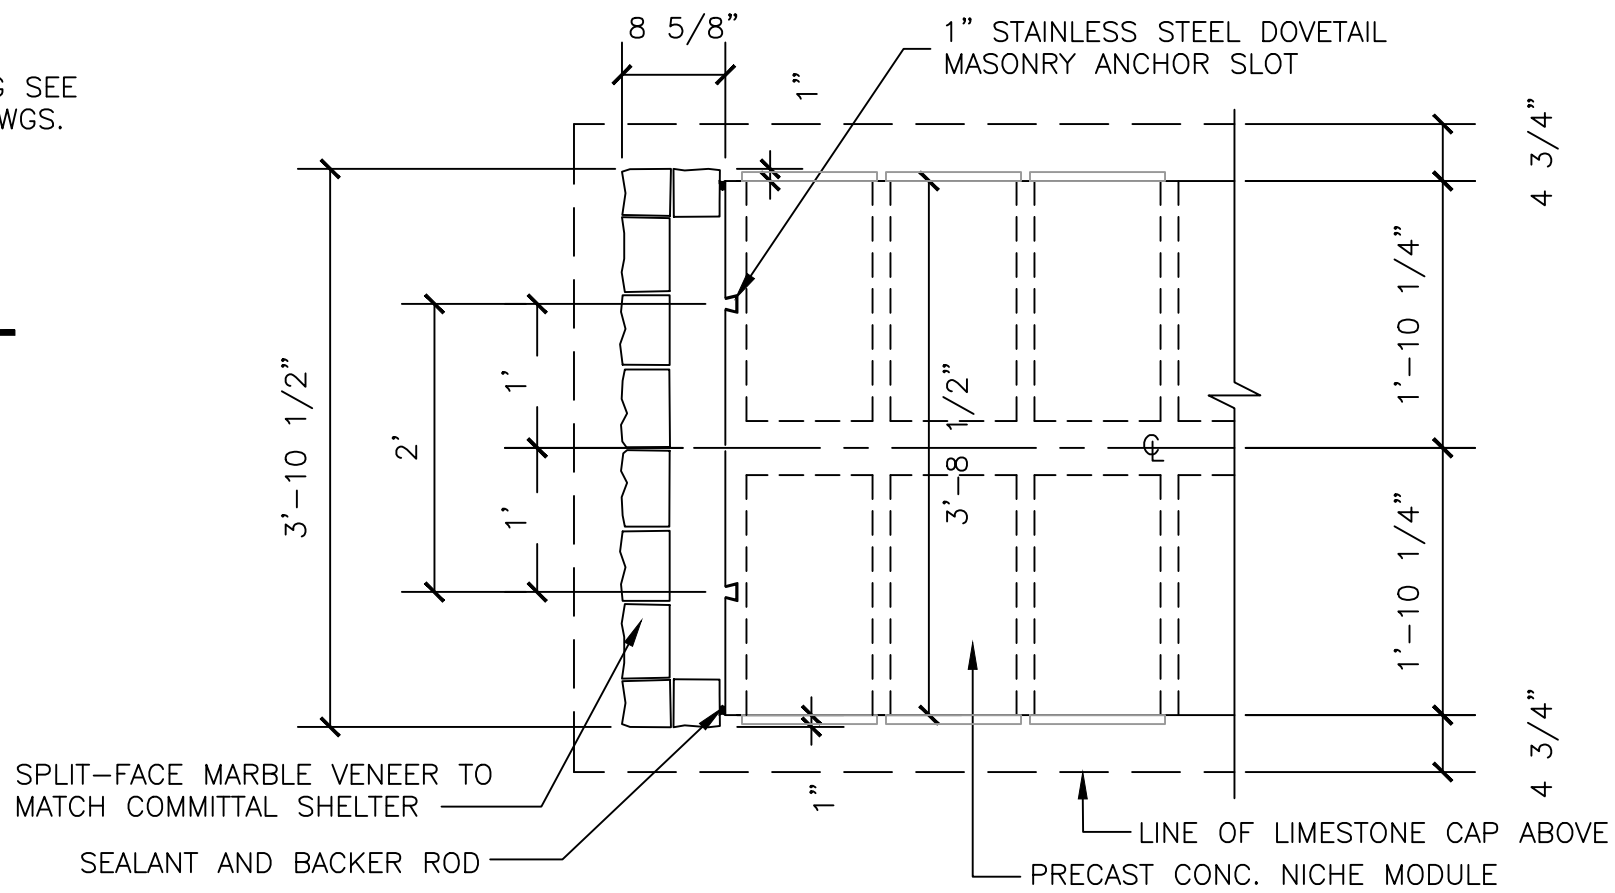




7 SECTION- FREE STANDING COLUMBARIA CAP
3/4" = 1'-0"





8 LIMESTONE CAP JOINT DETAIL
NOT TO SCALE

BID DOCUMENTS

<div>Revisions</div> <div>Date</div>	<div>PRIME:</div> <div><div>AMEC FOSTER WHEELER ENVIRONMENT & INFRASTRUCTURE 1075 BIG SHANTY ROAD NW, SUITE 100 KENNESAW, GA. 30144 (770) 421-3400 AMEC PROJECT: 6166-15-0011</div></div>	<div>MEP ENGINEER:</div>	<div></div>	<div>IRRIGATION DESIGNER:</div> <div><div>2231 Weatherstone Circle Conyers, GA 30094 (770) 929-0884, fax (770) 760-8025</div></div>	<div><div>NATIONAL CEMETERY ADMINISTRATION</div></div>	<div>Drawing Title</div> <div>DETAILS 1</div> <div>Approved: Director, Technical Support Service</div> <div>Approved: Chief, Architectural & Engineering Division</div>	<div>Project Title</div> <div>4000 NICHE COLUMBARIUM GEORGIA NATIONAL CEMETERY</div> <div>Building Number</div> <div>Checked</div> <div>Drawn</div> <div>Location</div> <div>1080 VETERANS CEMETERY RD, CANTON, GA 30114</div>	<div>Date</div> <div>23 OCTOBER 2015</div> <div>Project No.</div> <div>922CM3005</div> <div>DRAWING NO.</div> <div>C-501</div> <div>Sheet 16 Of 31</div>
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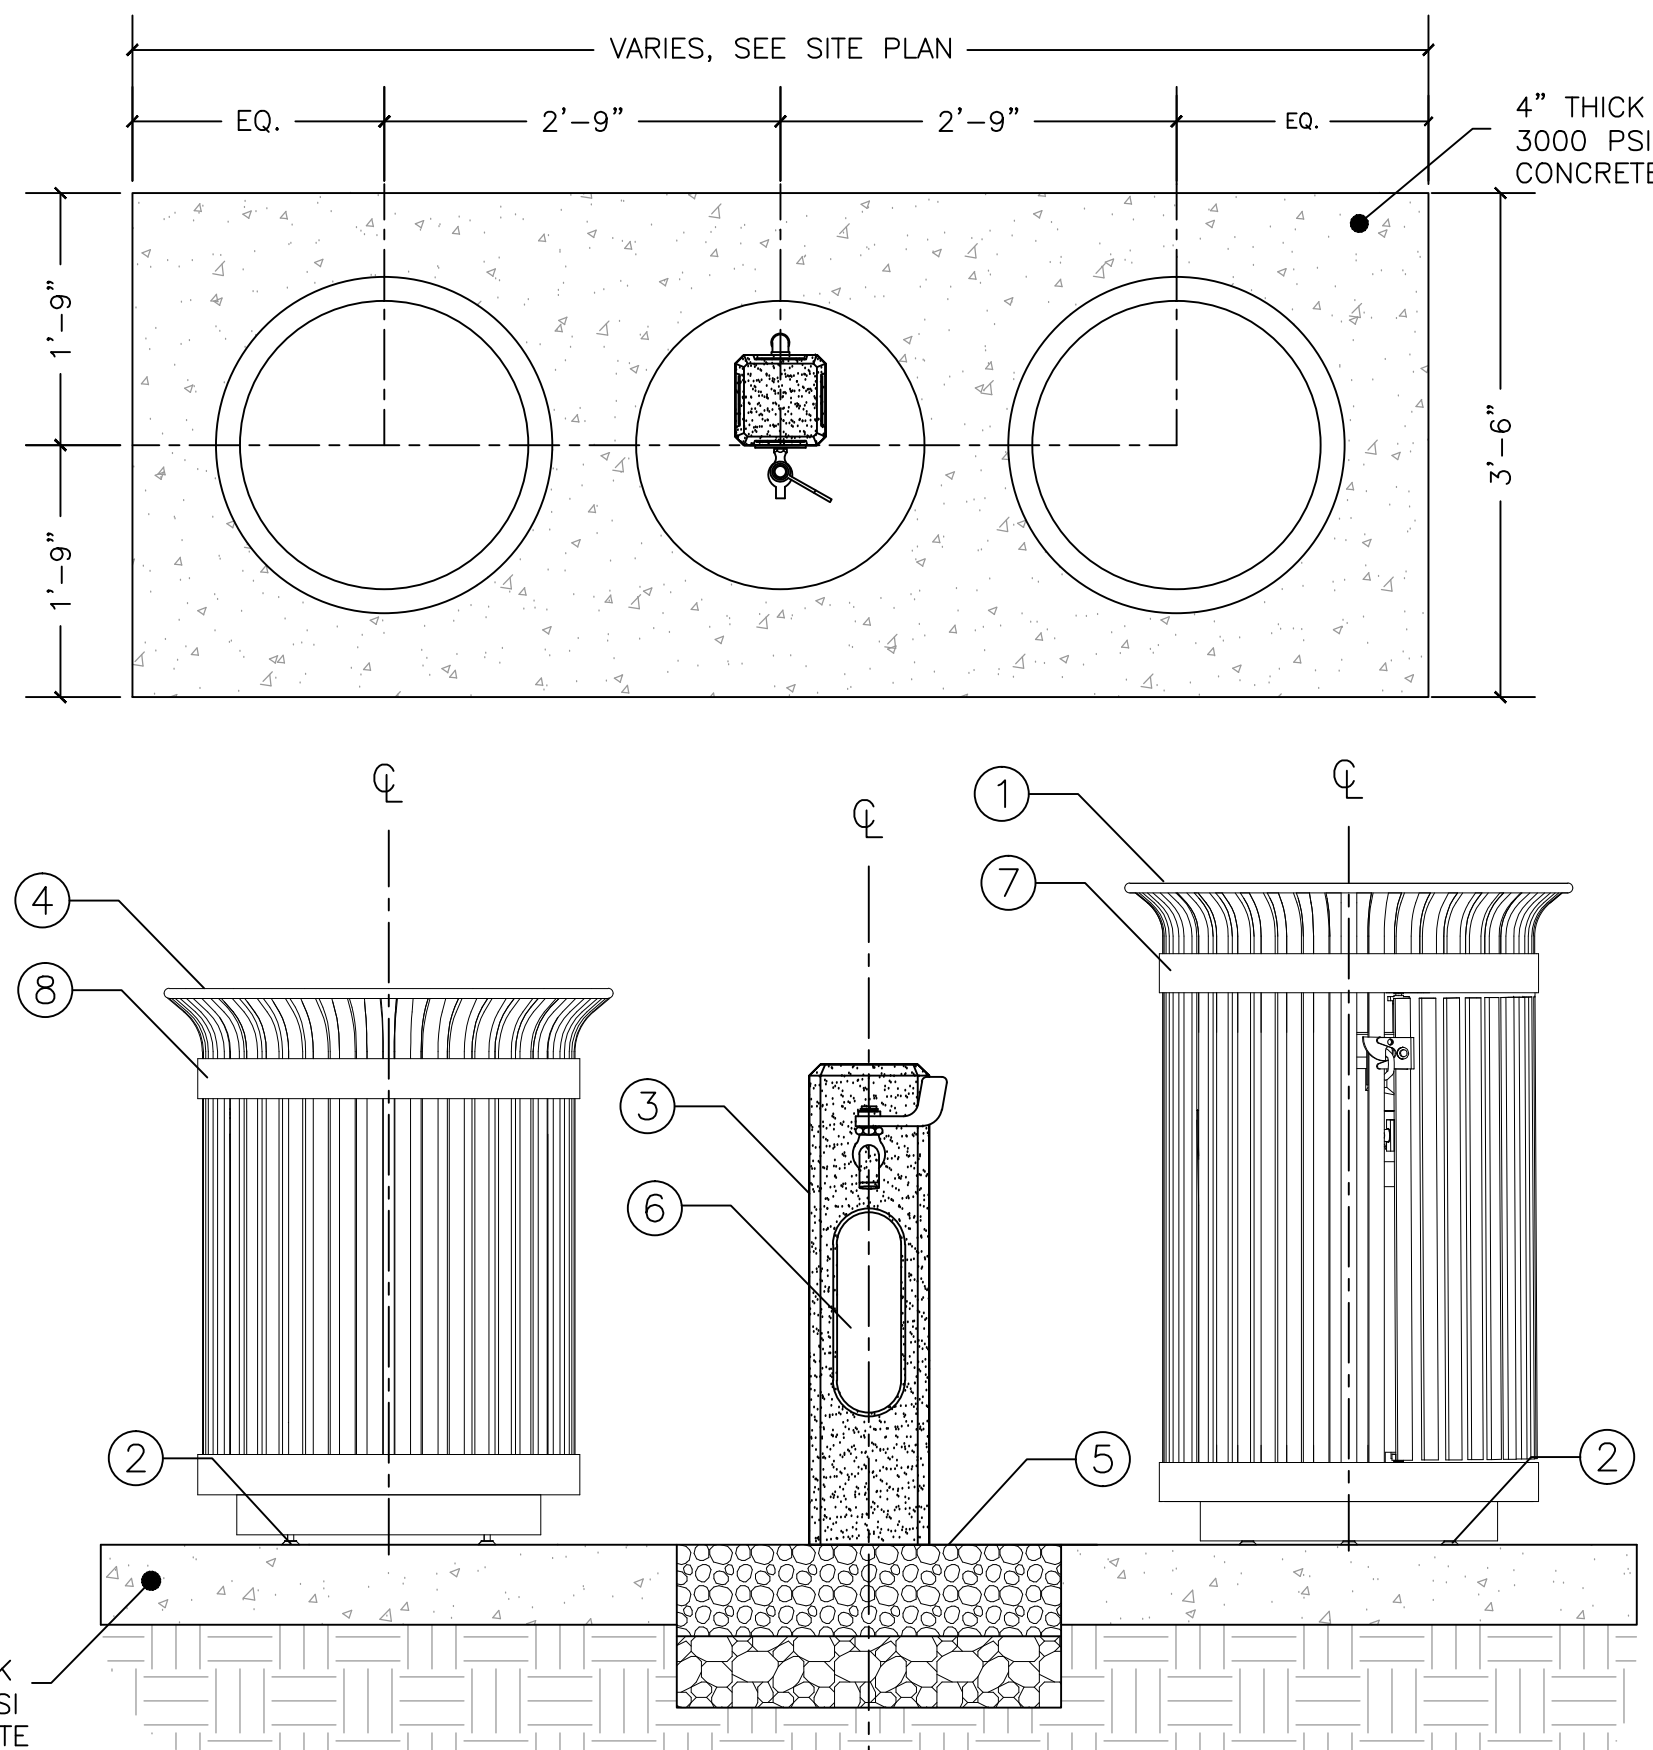
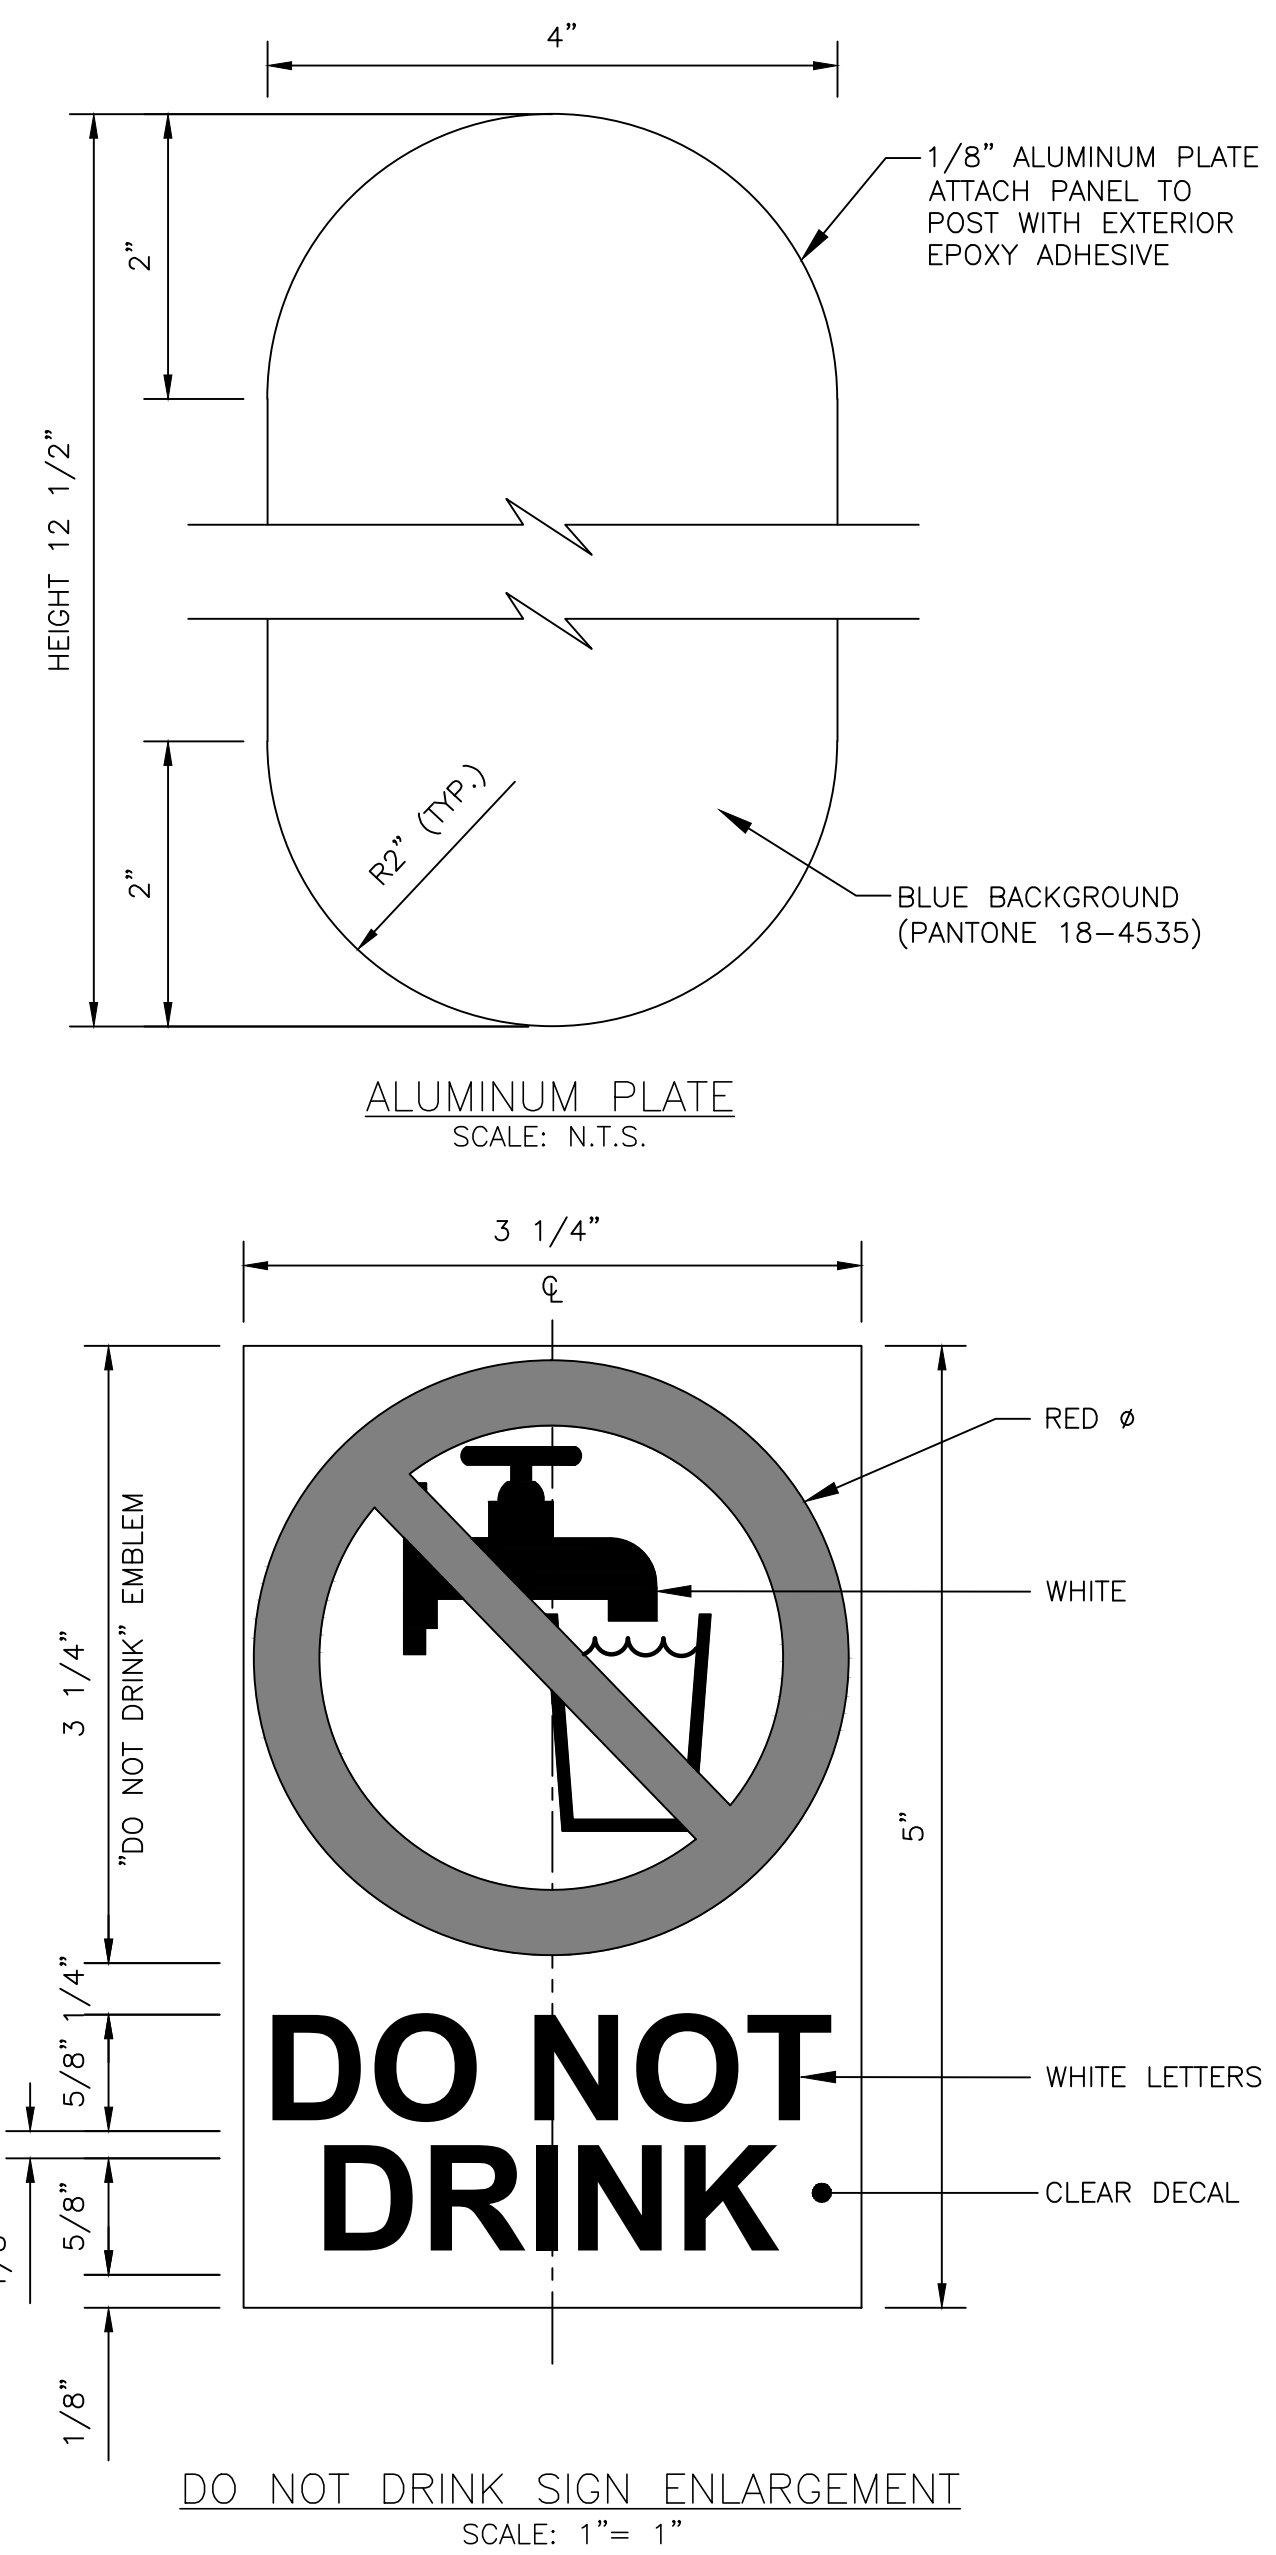
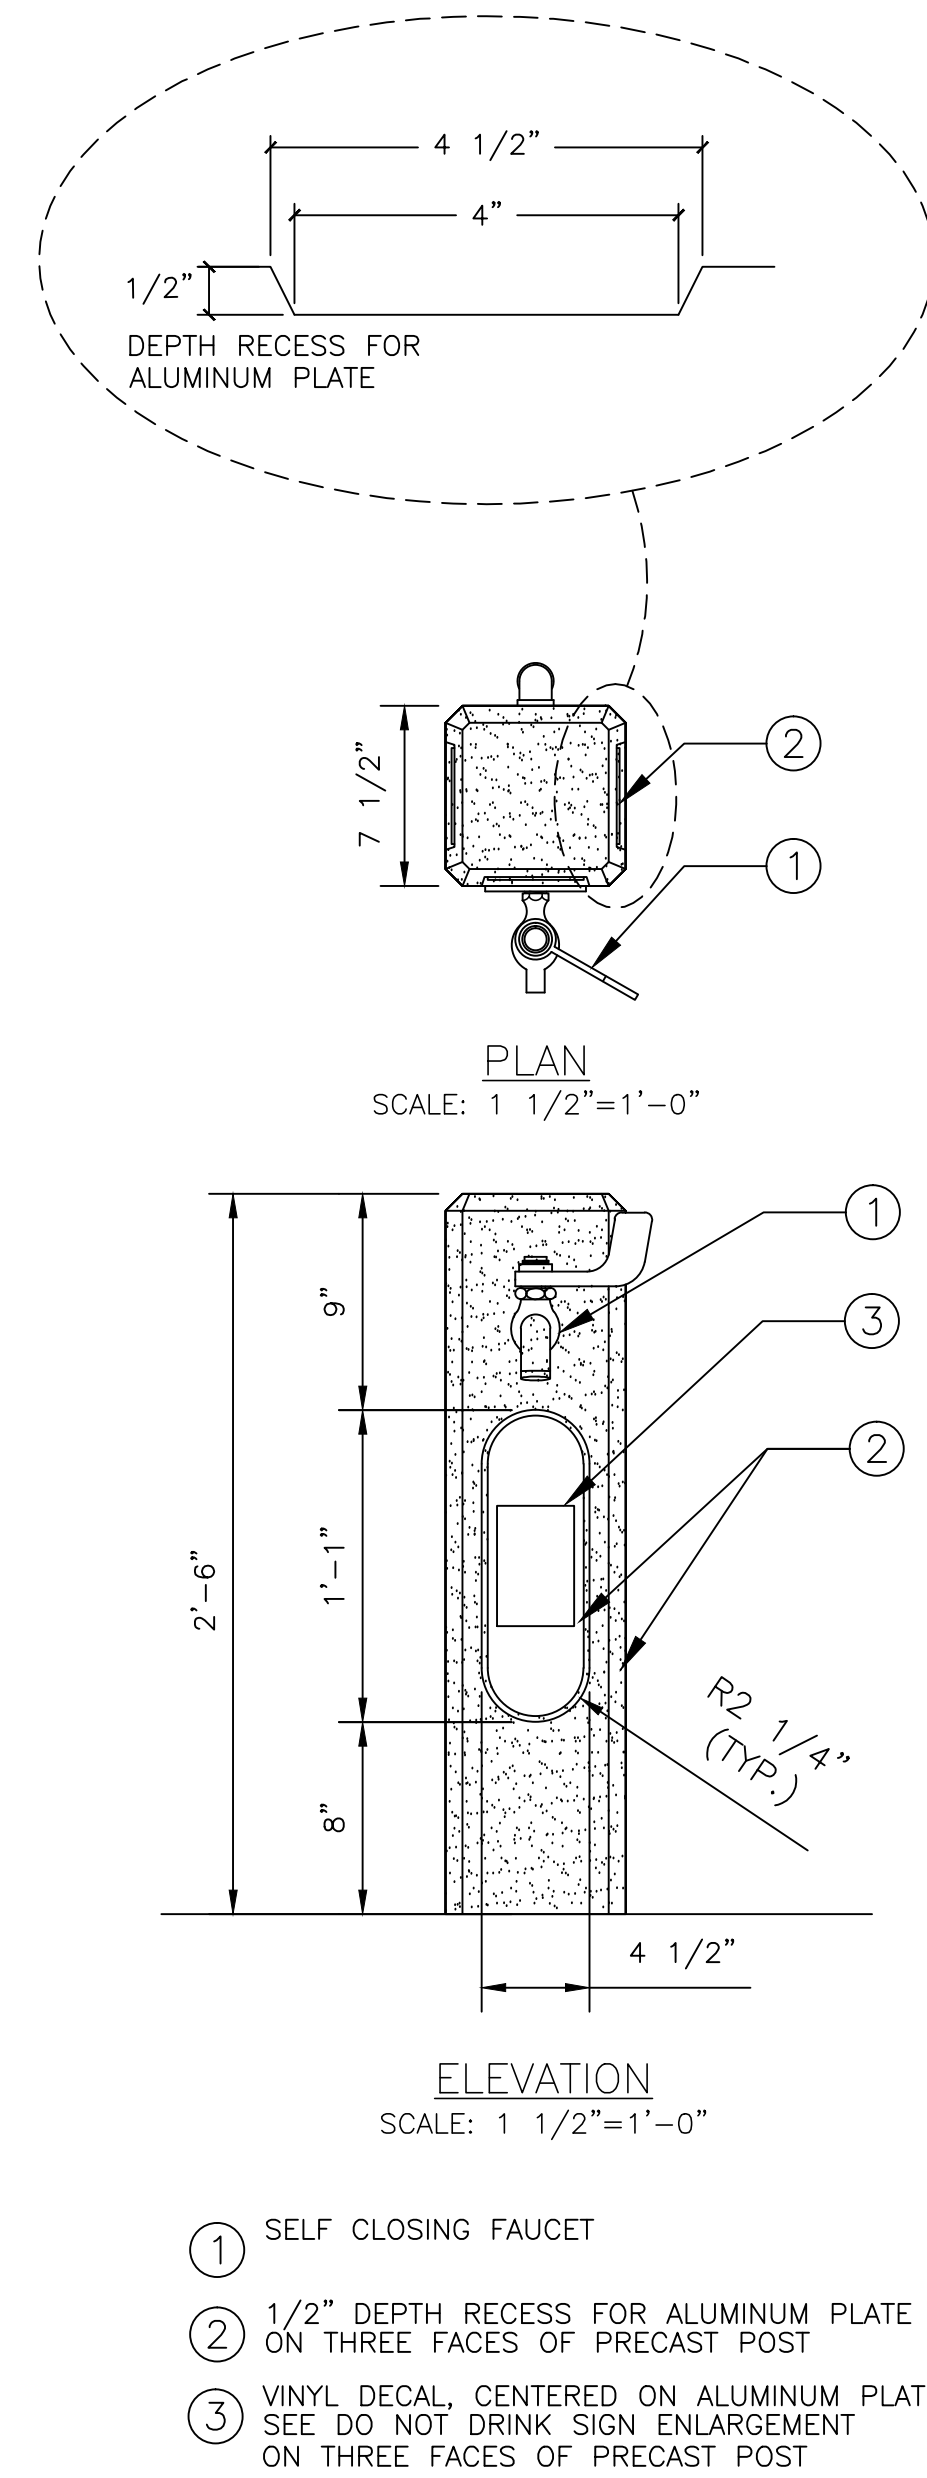


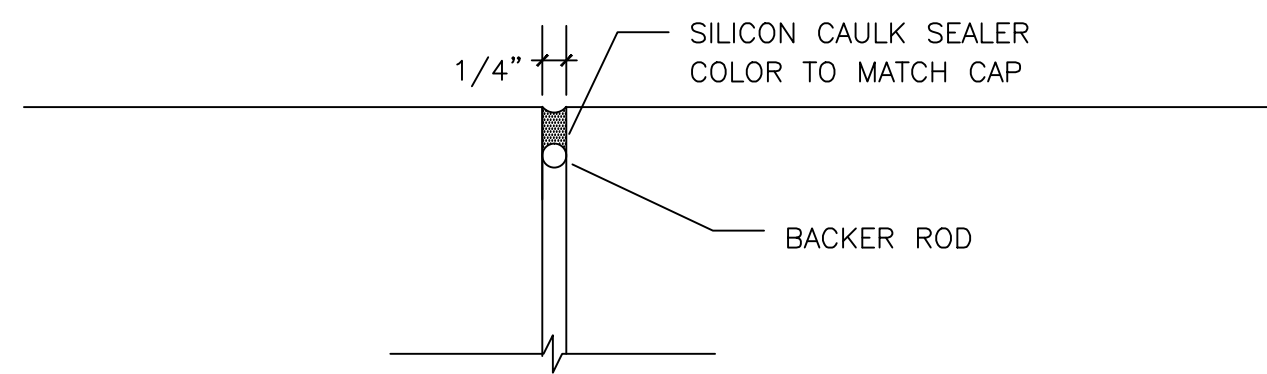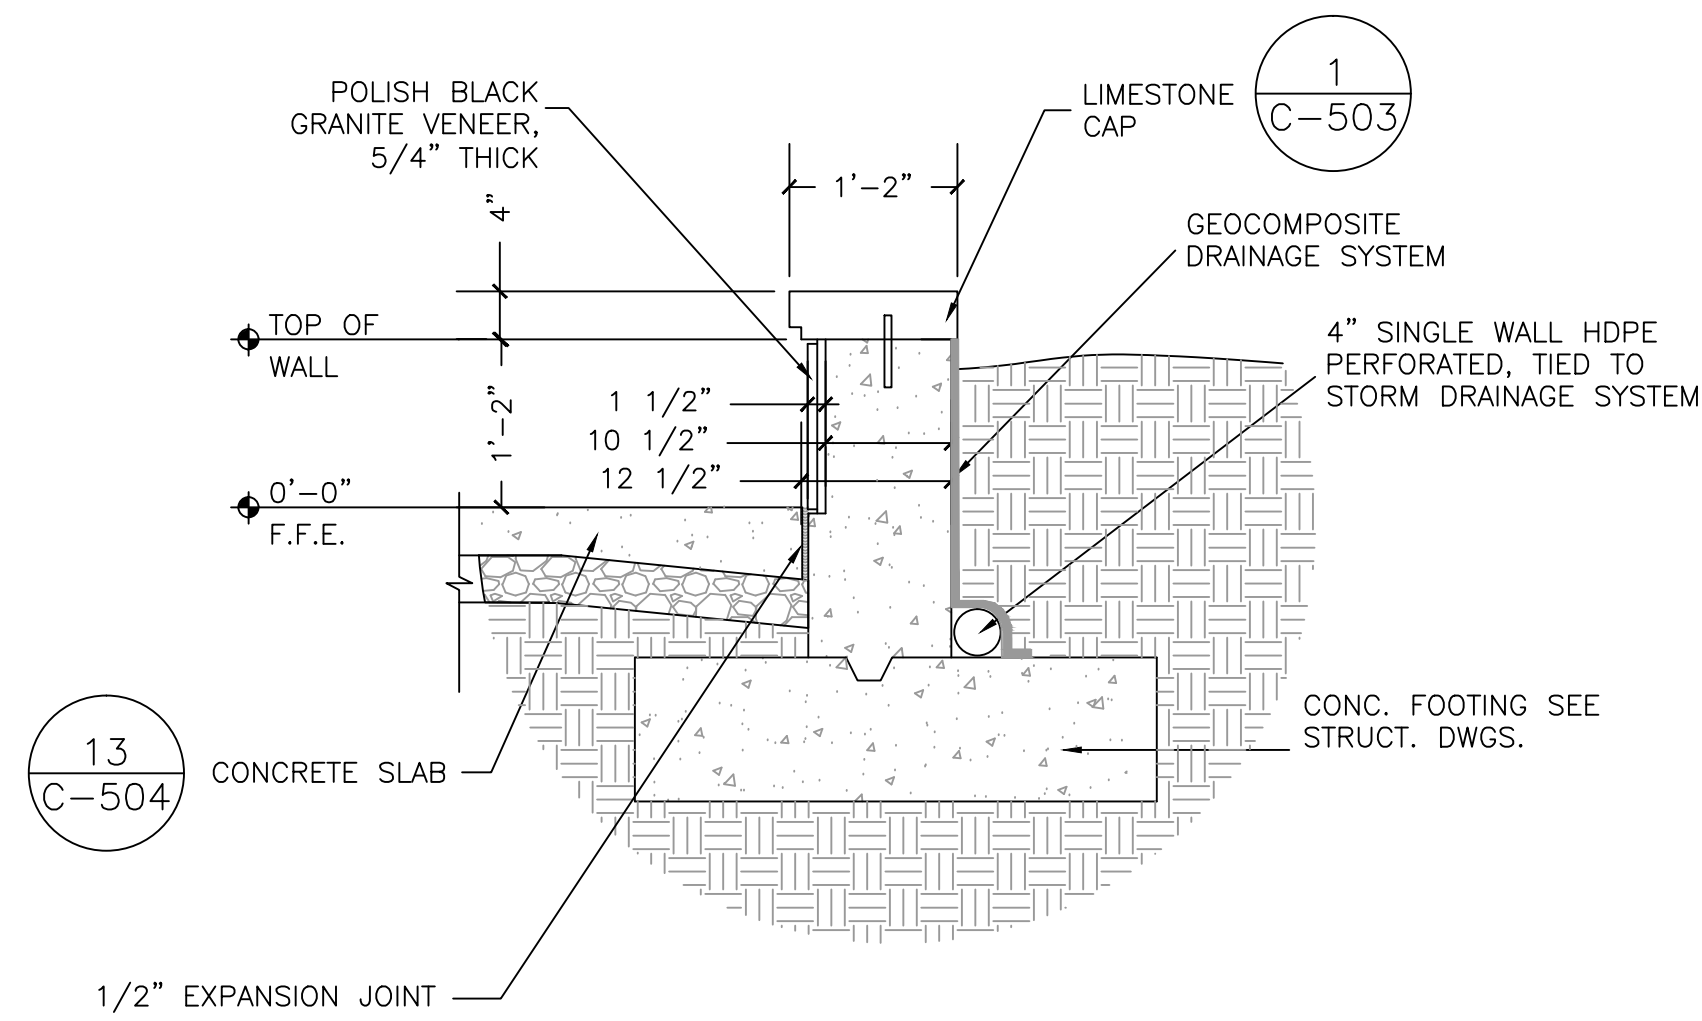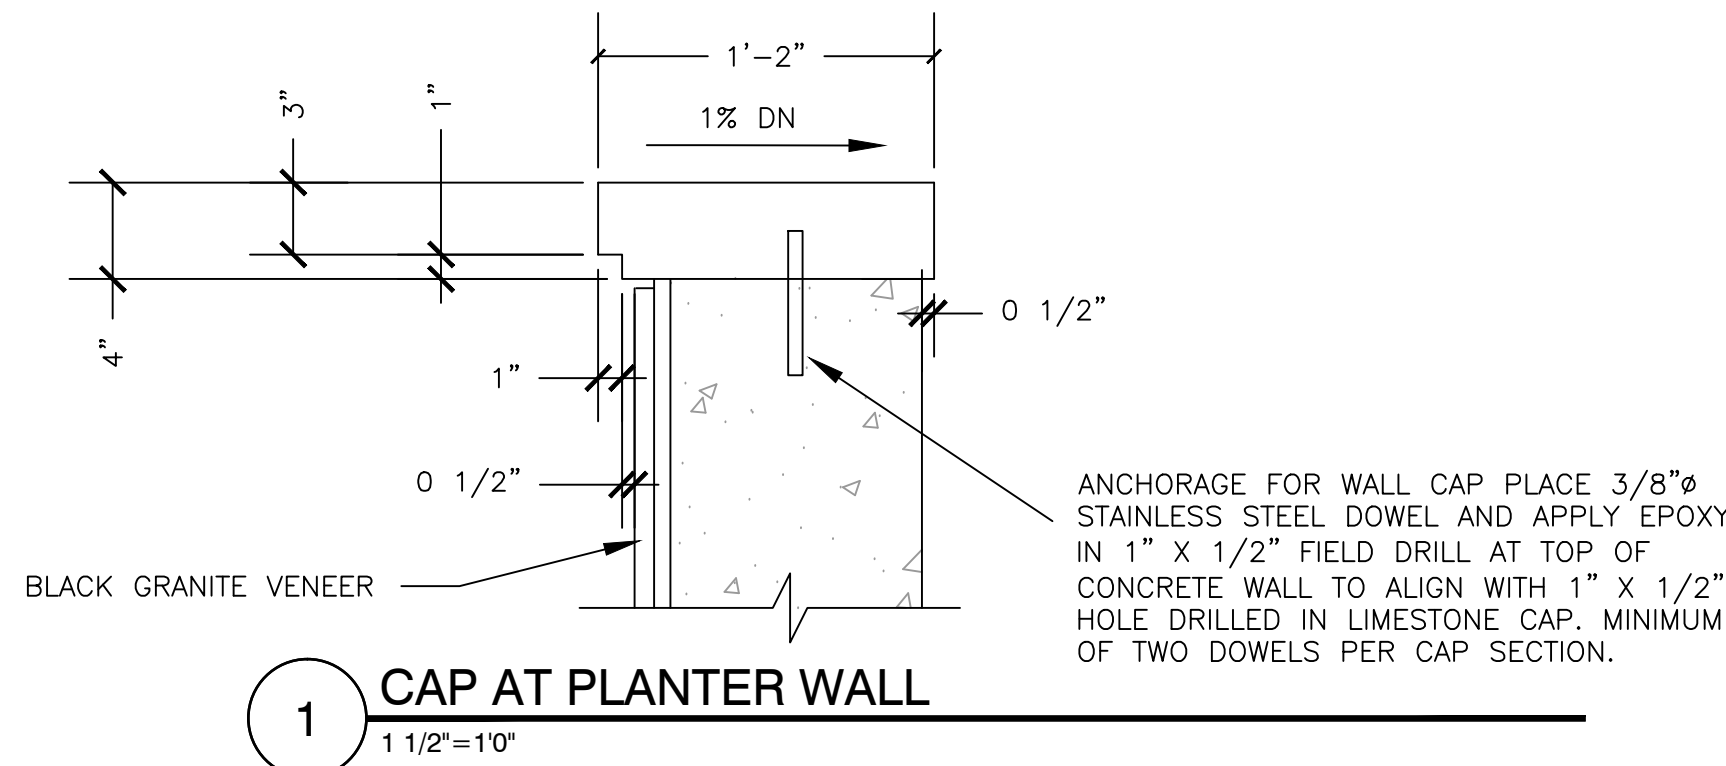3 PLANTER WALL CAP JOINT DETAIL
1/2"=1"

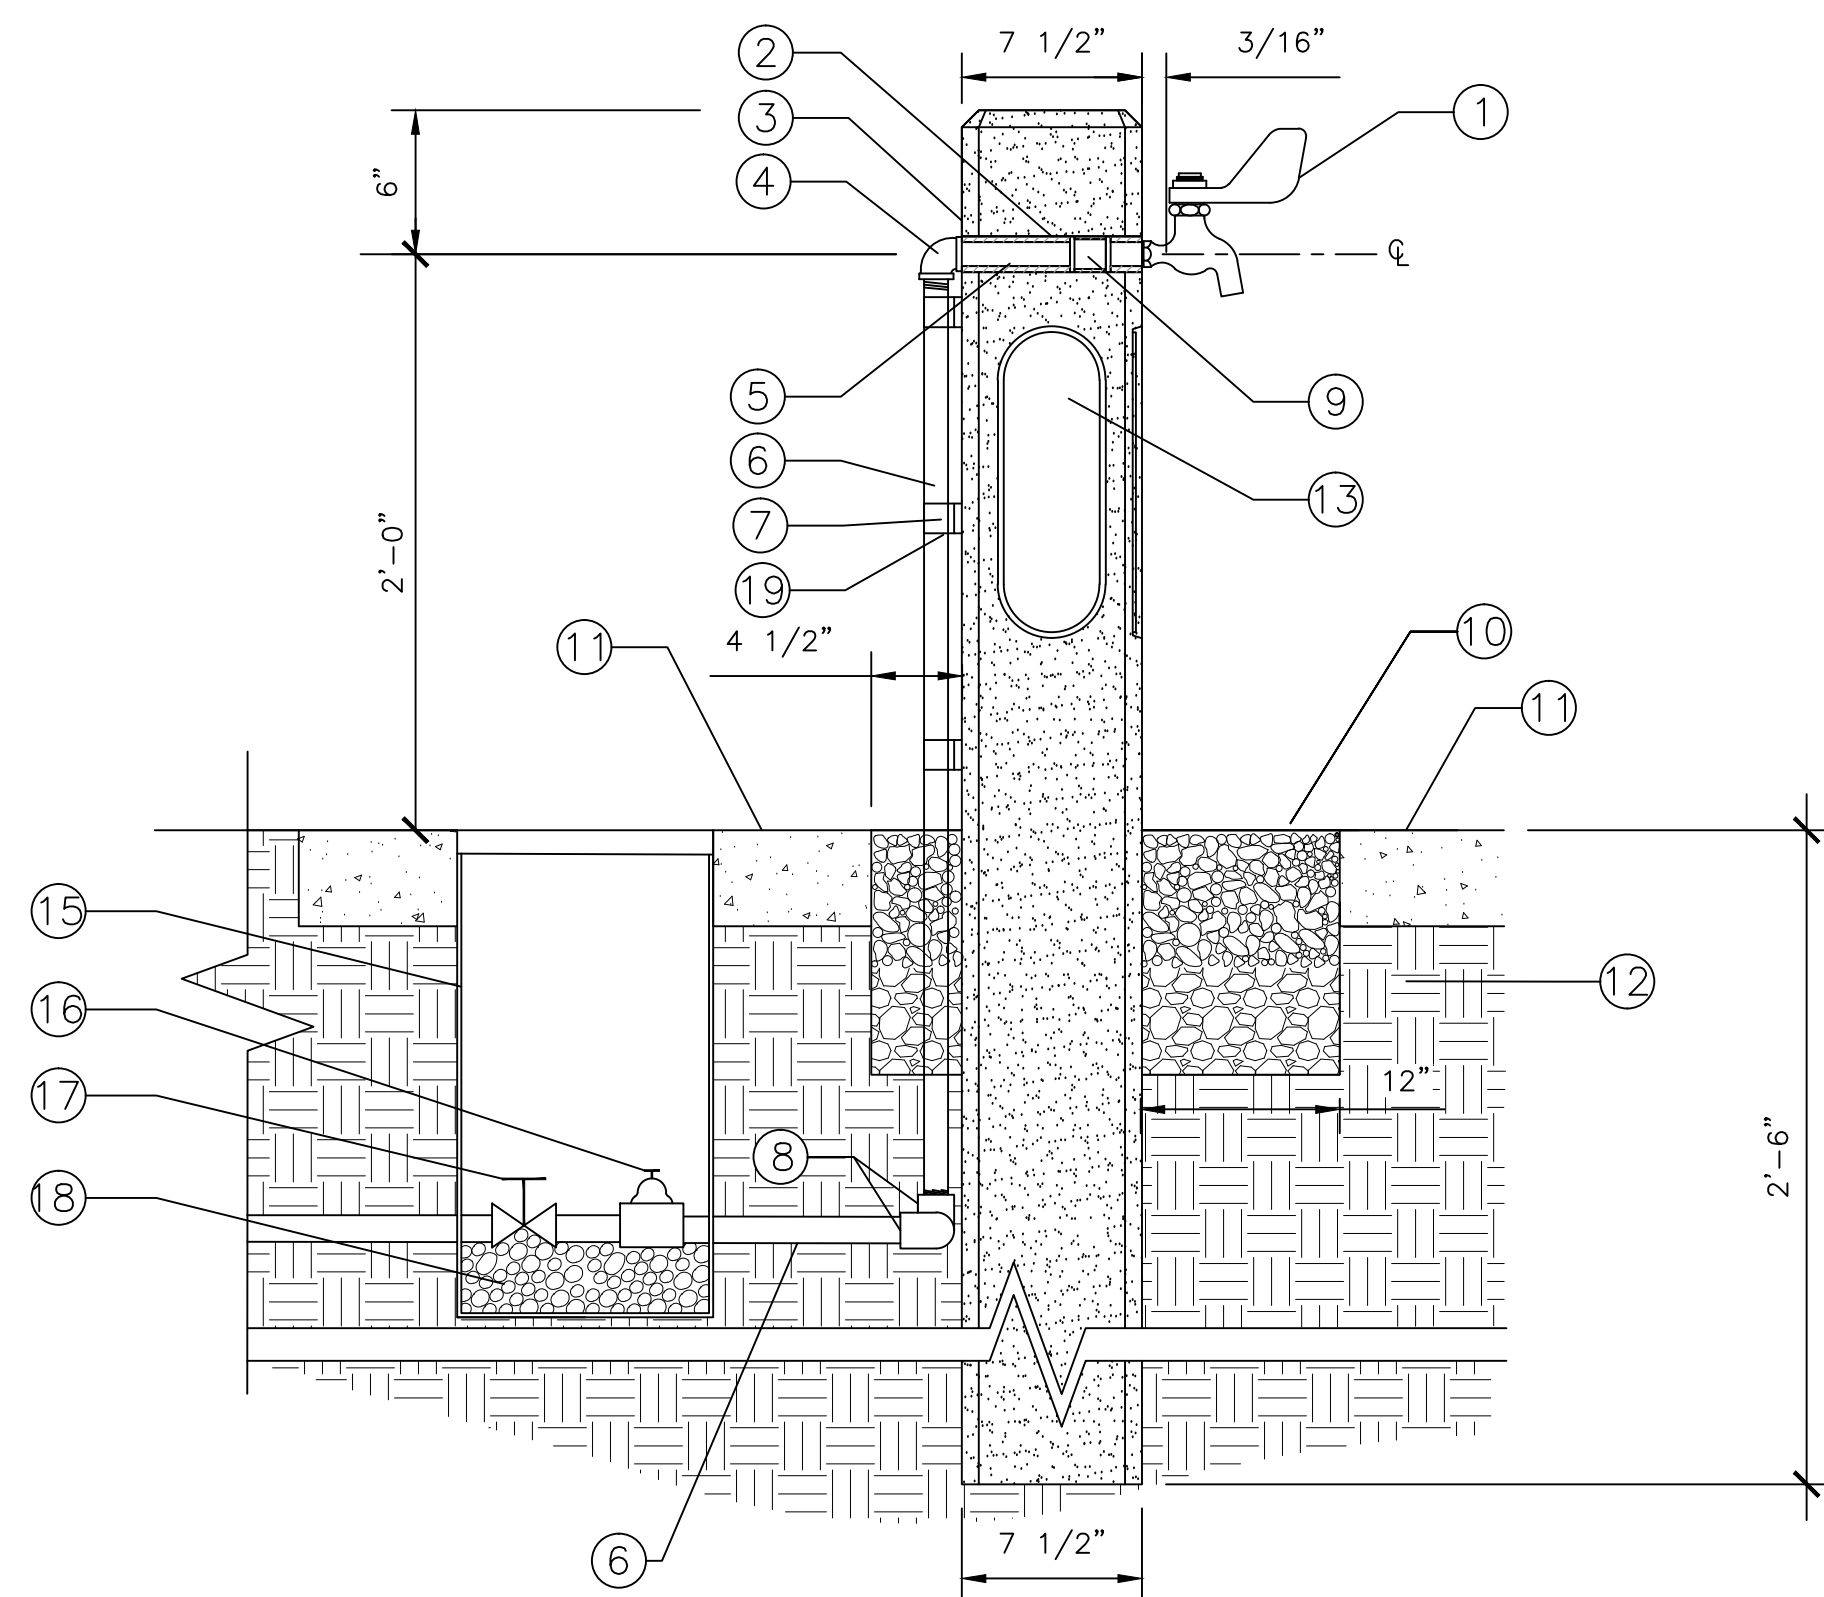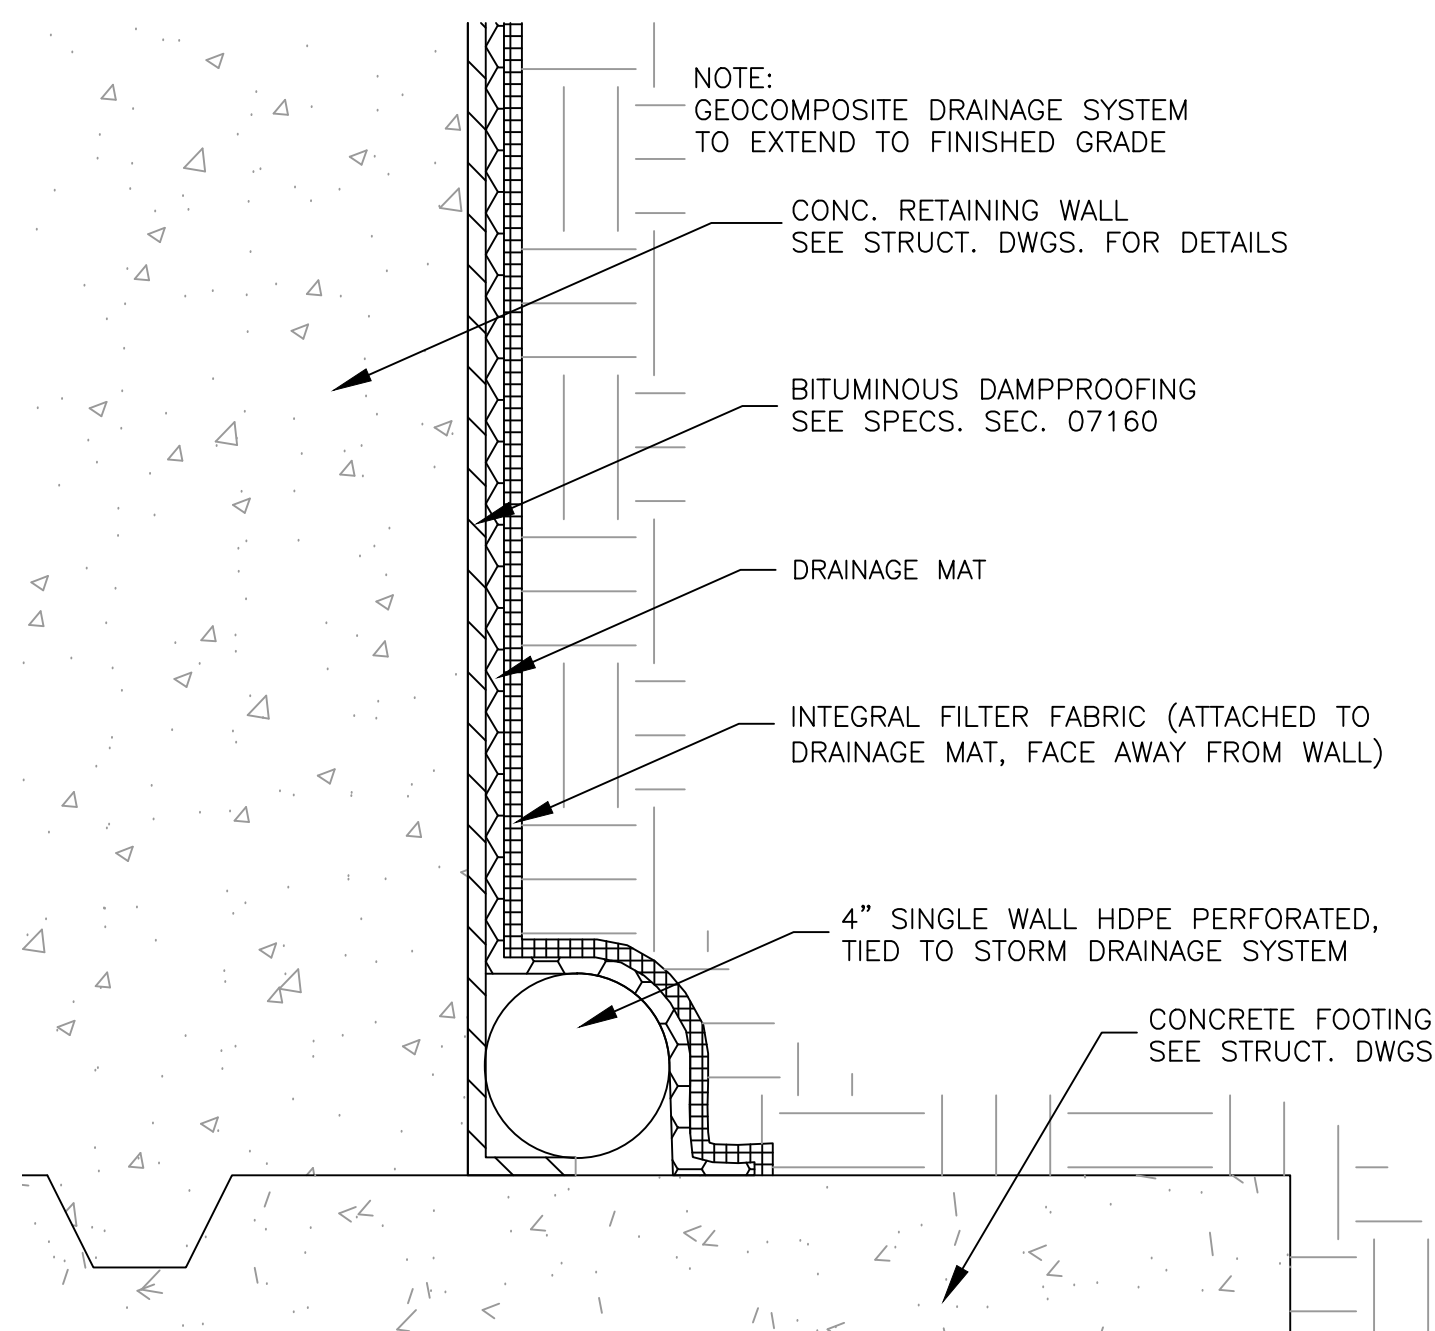


- 1 SELF CLOSING FAUCET (MATCH EXISTING) WITH 1/2" MIPT INLET THREAD INTO BRASS COUPLER
- 2 1 1/2" DIA. CAST HOLE THROUGH POST FILL WITH EPOXY AFTER PIPE INSTALLATION DO NOT ALLOW EPOXY TO INTERFERE WITH THREADED CONNECTION BETWEEN FAUCET AND COUPLER
- 3 PRECAST CONCRETE POST, INSTALL 2'-6" INTO GROUND.
- 4 1/2" FIPT X 3/4" FIPT BRASS REDUCING ELBOW
- 5 1/2" BRASS NIPPLE LENGTH AS REQUIRED
- 6 3/4" BRASS NIPPLES LENGTH AS REQUIRED
- 7 3/4" BRASS PIPE STRAPS SECURE TIGHTLY TO POST TO ELIMINATE PIPE MOVEMENT
- 8 3/4" FIPT X FIPT BRASS 90 DEGREE ELBOW
- 9 1/2" FIPT X FIPT BRASS COUPLER
- 10 2' DIAMETER GRAVEL SPLASH PIT 6" MIN. DECORATIVE STONE OVER DRAINAGE STONE, DEPTH VARIES TO PROMOTE POSITIVE DRAINAGE
- 11 ADJACENT CONCRETE SIDEWALK
- 12 90% COMPACTED SUBGRADE
- 13 1/2" DEEP RECESS FOR ALUMINUM PLATE ON THREE SIDES
- 14 not used
- 15 VALVE BOX
- 16 OUTPUT PRESSURE REGULATING VALVE
- 17 ISOLATION BALL VALVE
- 18 WASHED RIVER GRAVEL
- 19 RUBBER ISOLATION GASKET, (TYP.)

5 VASE WATERING STATION
N.T.S.




- 1 TRASH RECEPTACLE PER SPECIFICATIONS
- 2 ANCHOR TO CONCRETE PER MANUFACTURERS RECOMMENDATIONS
- 3 WATER FAUCET ASSEMBLY SEE DETAIL THIS SHEET
- 4 FLOWER VASE RECEPTACLE PER SPECIFICATIONS
- 5 2' DIAMETER CIRCLE GRAVEL SPLASH PIT SEE DETAIL THIS SHEET
- 6 RECESS FOR ALUMINUM PLATE PER SPECIFICATIONS
- 7 TRASH DECAL PER SPECIFICATIONS
- 8 FLOWER VASES DECAL PER SPECIFICATIONS

6 FLOWER WATERING STATION
N.T.S.

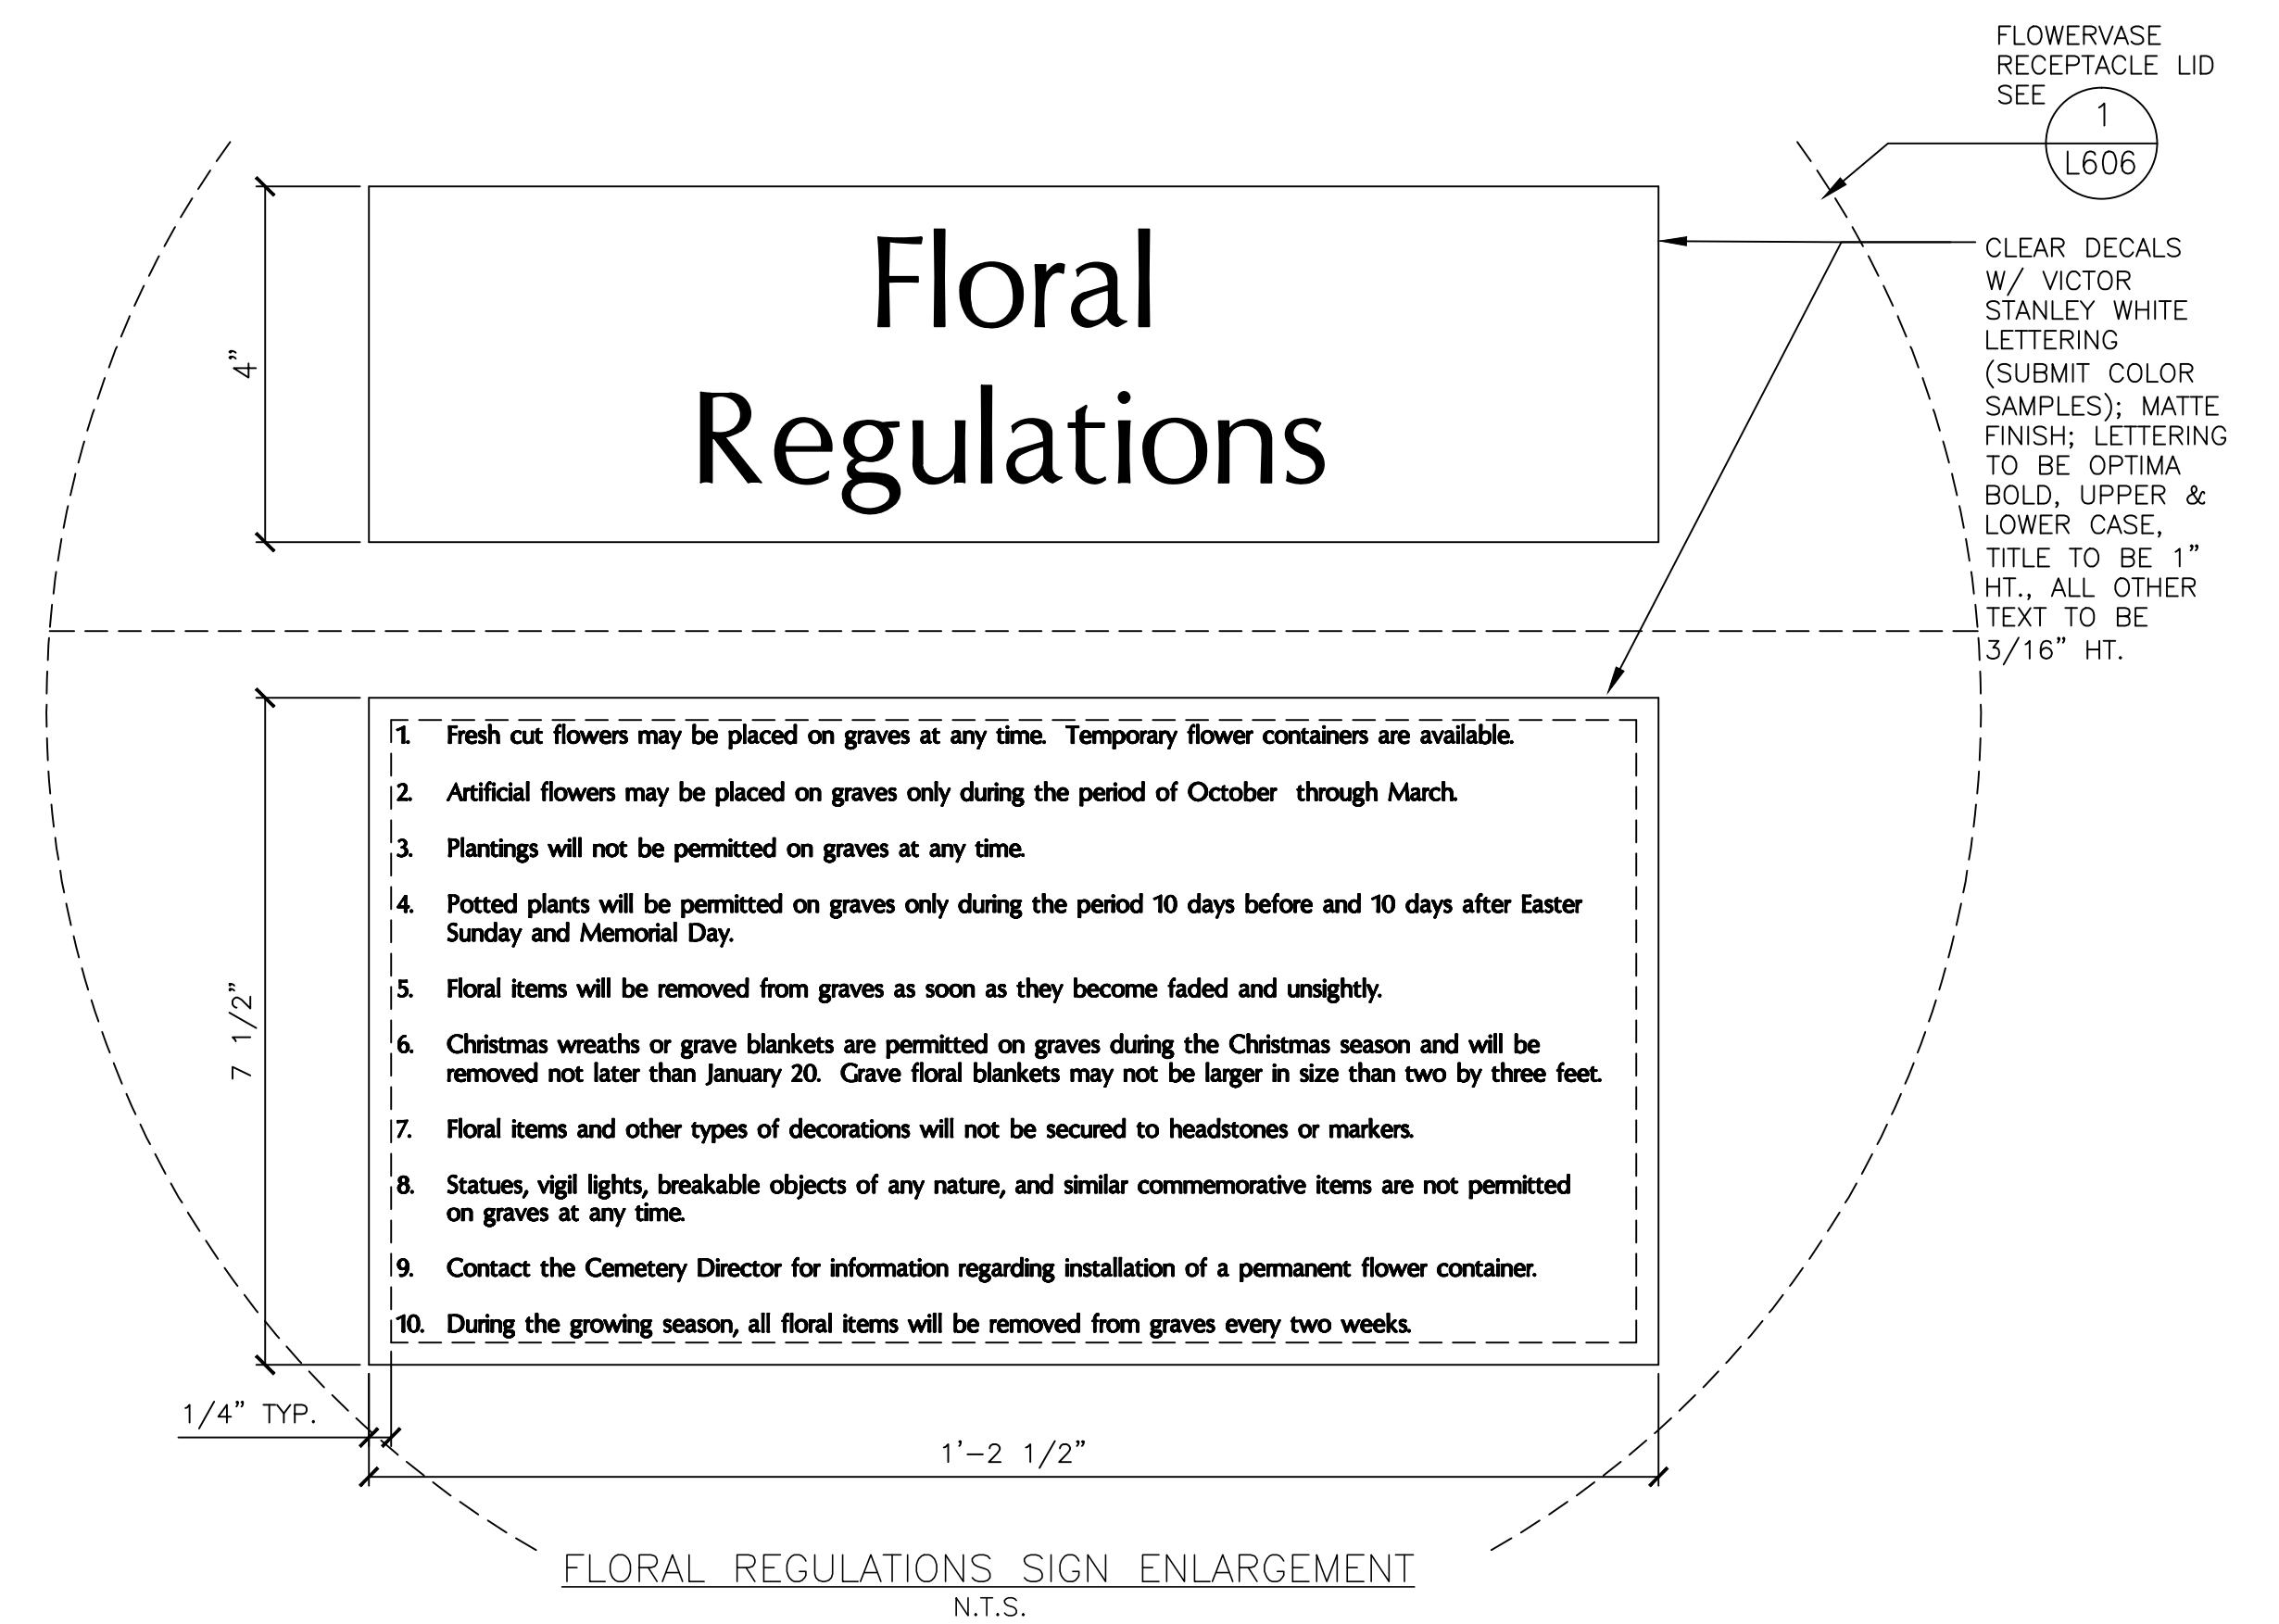


BID DOCUMENTS


<p>Revisions</p> <p>Date</p>	<p>PRIME:</p> <p>AMEC FOSTER WHEELER ENVIRONMENT & INFRASTRUCTURE 1075 BIG SHANTY ROAD NW, SUITE 100 KENNESAW, GA. 30144 (770) 421-3400 AMEC PROJECT: 6166-15-0011</p>	<p>MEP ENGINEER:</p>	<p>IRRIGATION DESIGNER:</p> <p>GEORGIA REGISTERED PROFESSIONAL ENGINEER JAMES L. STUDER</p>	<p>IRRIGATION CONSULTANT SERVICES</p> <p>2231 Weatherstone Circle Conyers, GA 30094 (770) 929-0884, fax (770) 760-8025</p>	<p>NATIONAL CEMETERY ADMINISTRATION</p>	<p>Drawing Title</p> <p>DETAILS 3</p> <p>Approved: Director, Technical Support Service</p> <p>Approved: Chief, Architectual & Engineering Division</p>	<p>Project Title</p> <p>4000 NICHE COLUMBARIUM GEORGIA NATIONAL CEMETERY</p> <p>Building Number</p> <p>Checked</p> <p>Drawn</p> <p>Location</p> <p>1080 VETERANS CEMETERY RD, CANTON, GA 30114</p>	<p>Date</p> <p>23 OCTOBER 2015</p> <p>Project No.</p> <p>922CM3005</p> <p>DRAWING NO.</p> <p>C-503</p> <p>Sheet 18 Of 31</p>
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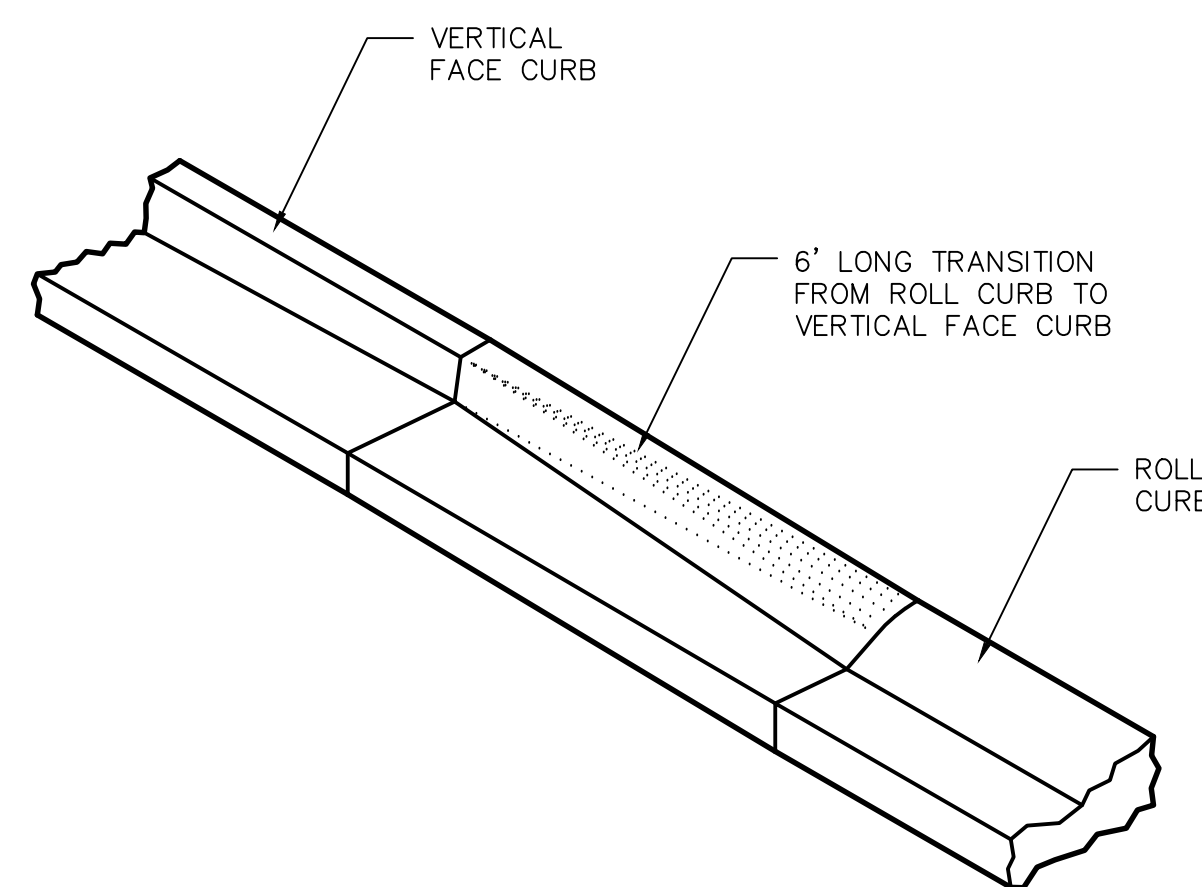
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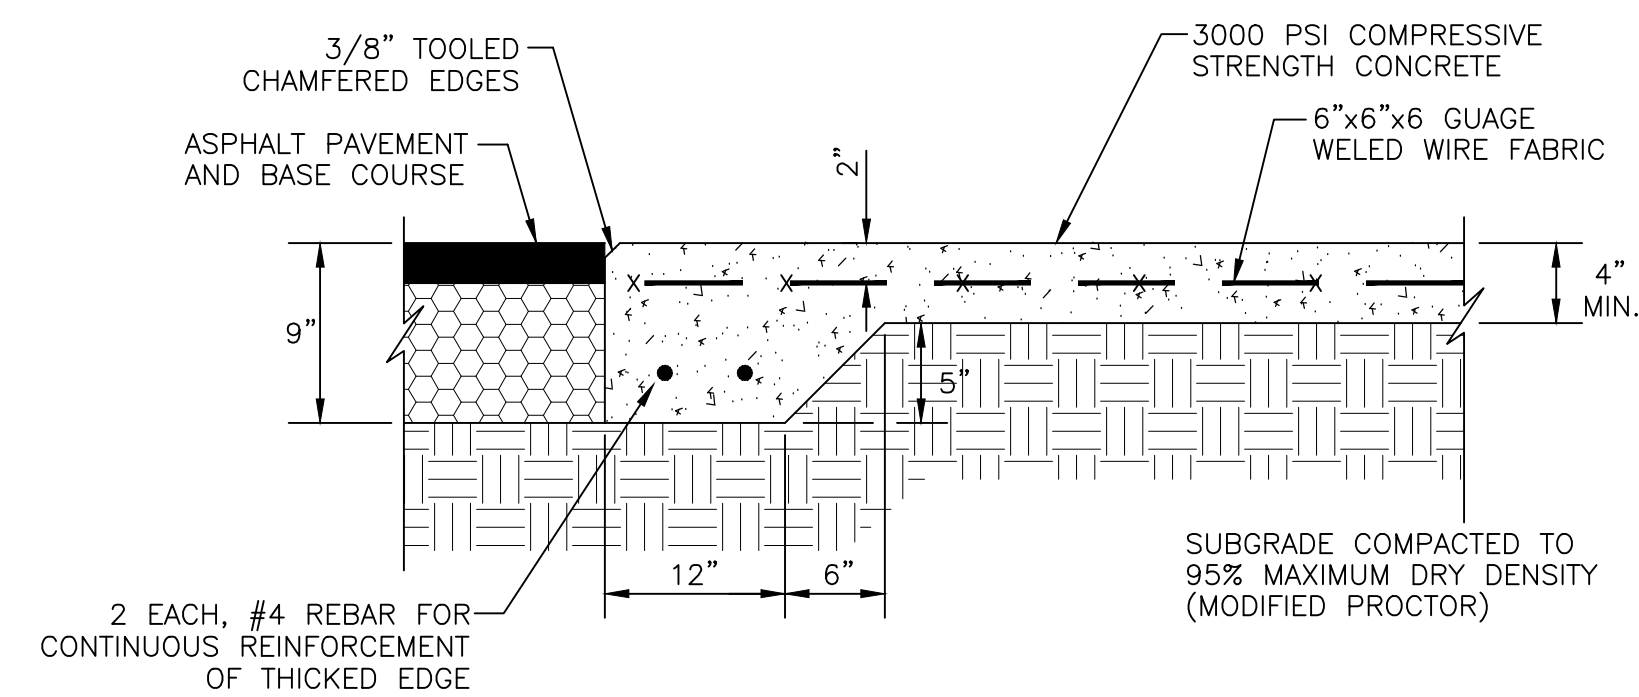
5 VERTICAL FACE CURB SECTION
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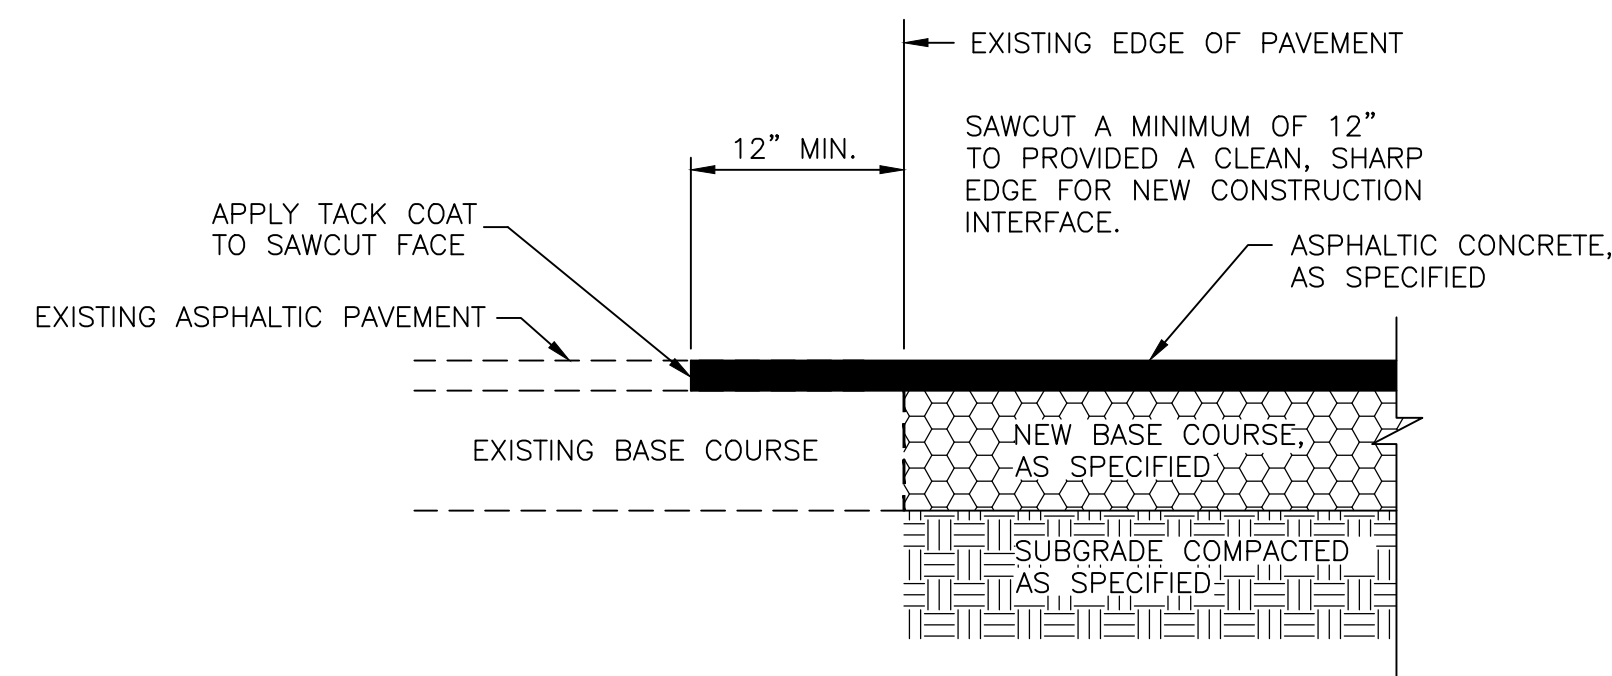
2 VERTICAL CURB TO ZERO CURB HEIGH TRANSITION
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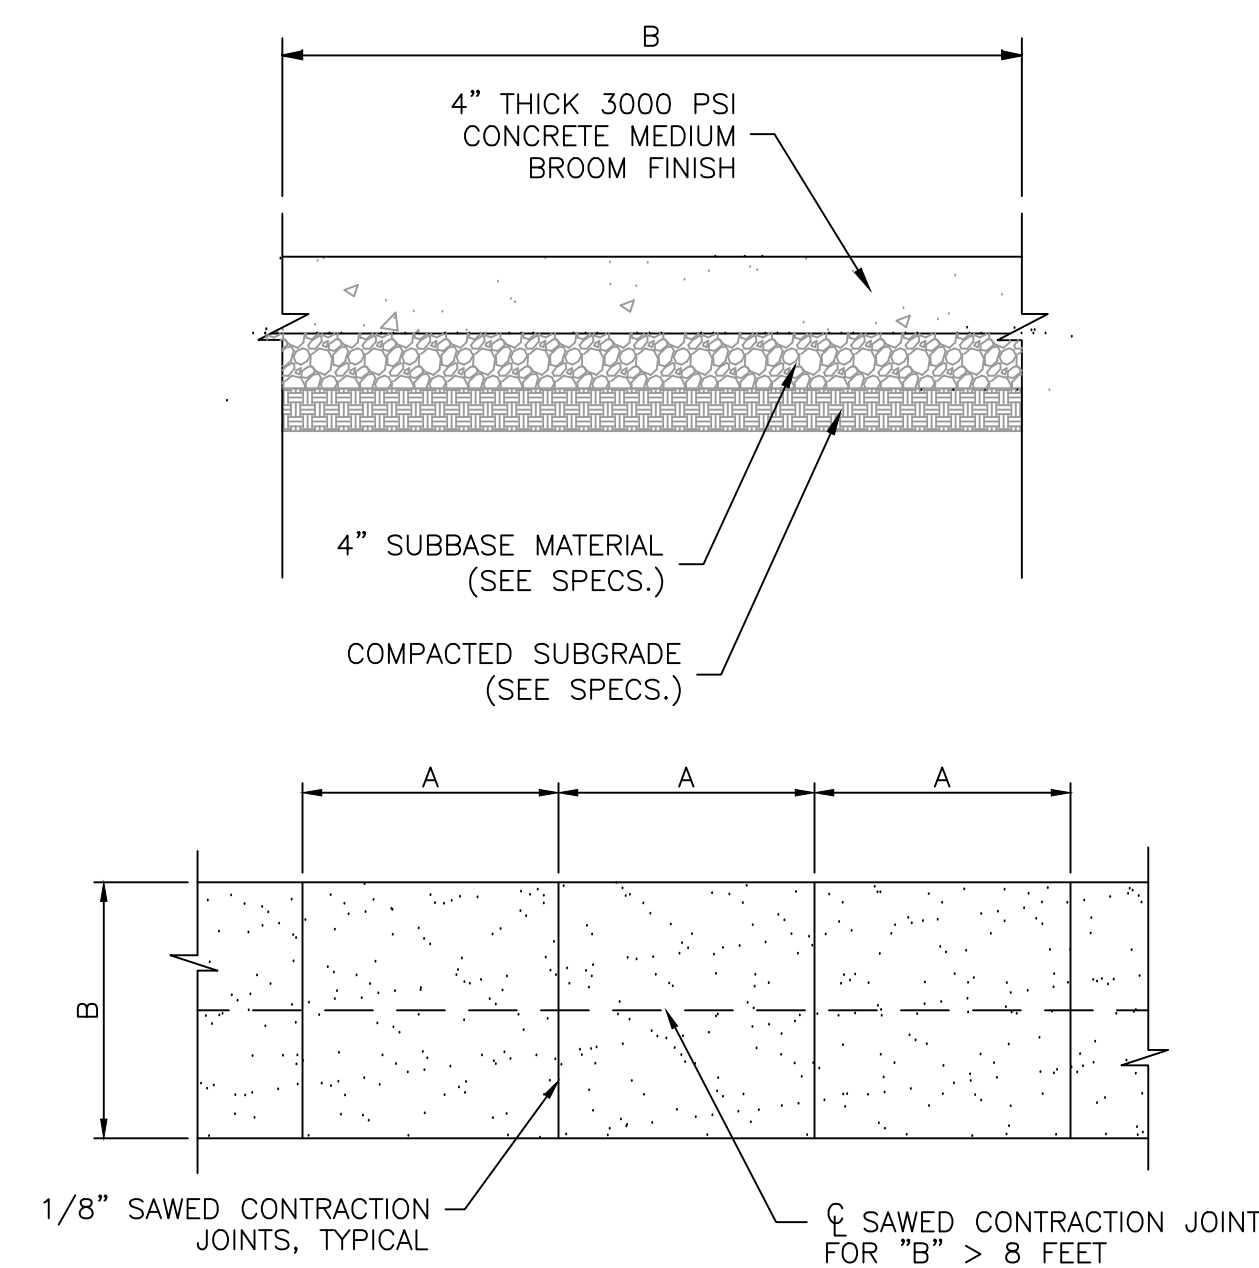
6 VERTICAL CURB TO ROLL-BACK CURB TRANSITION
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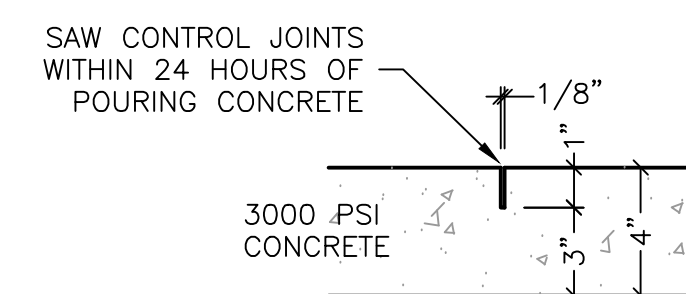
3 ASPHALT AND CONCRETE PAVEMENT INTERFACE
N.T.S.

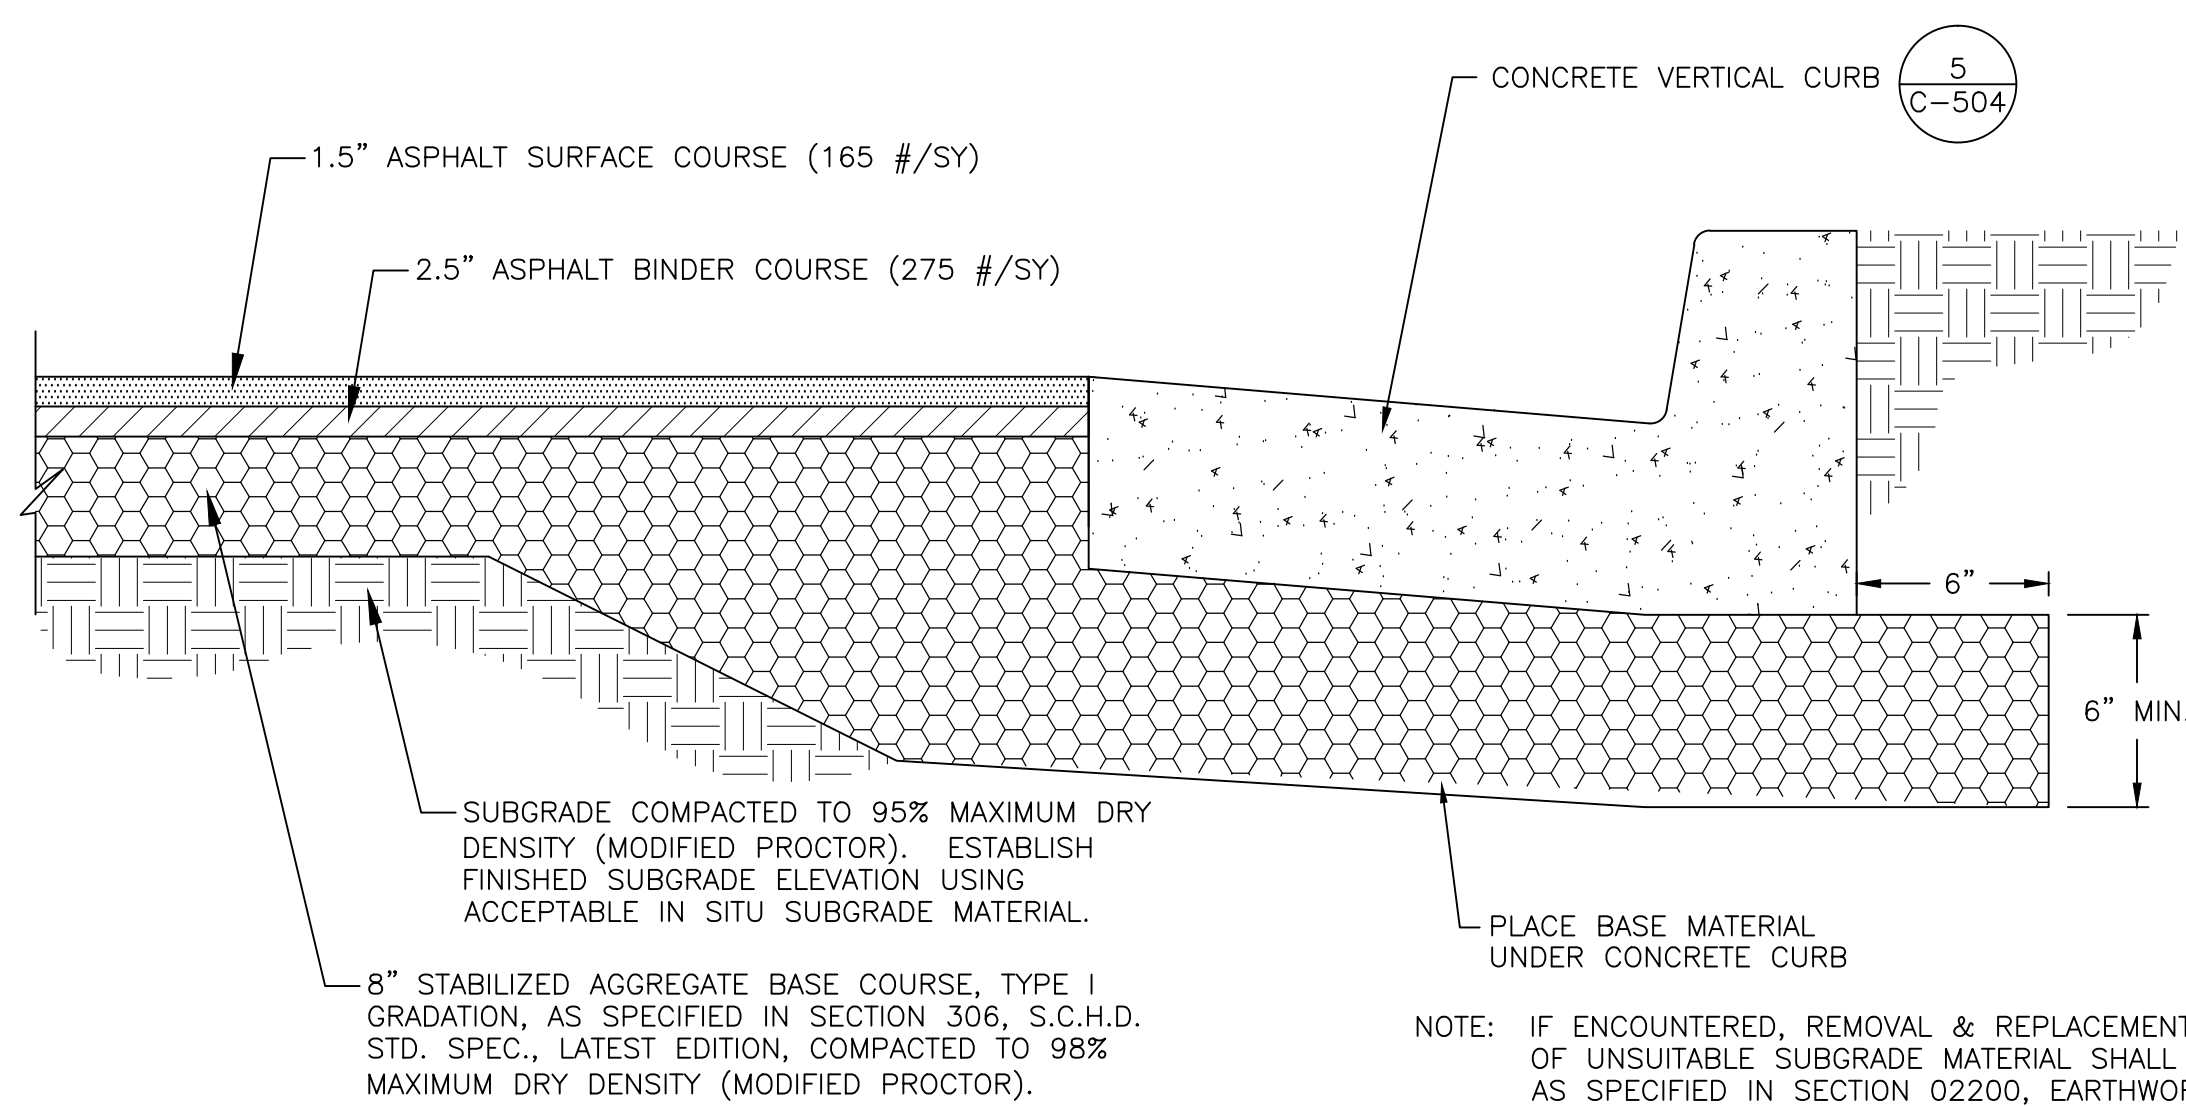


7 NEW/EXISTING PAVEMENT INTERFACE
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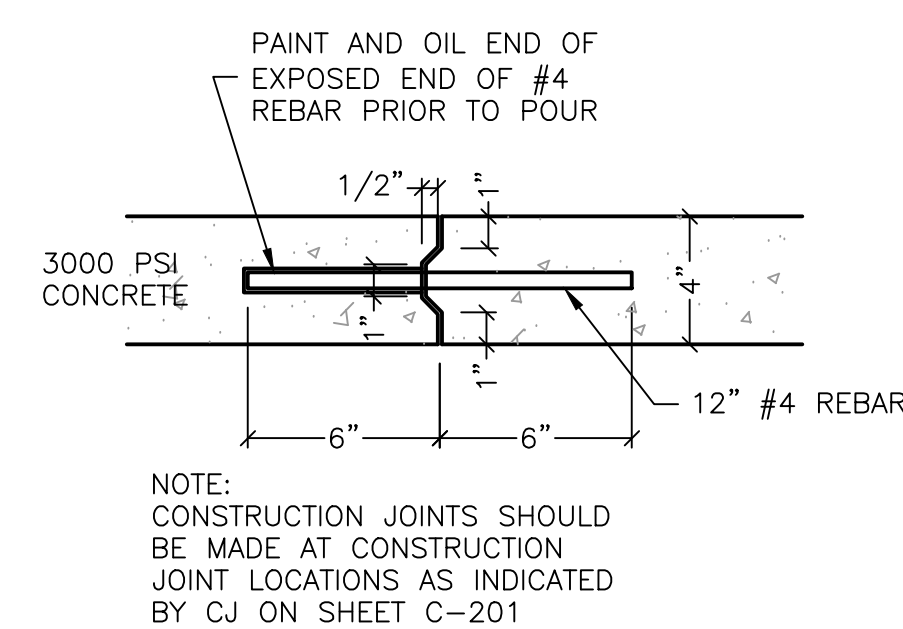
4 CONCRETE PAVEMENT DETAIL
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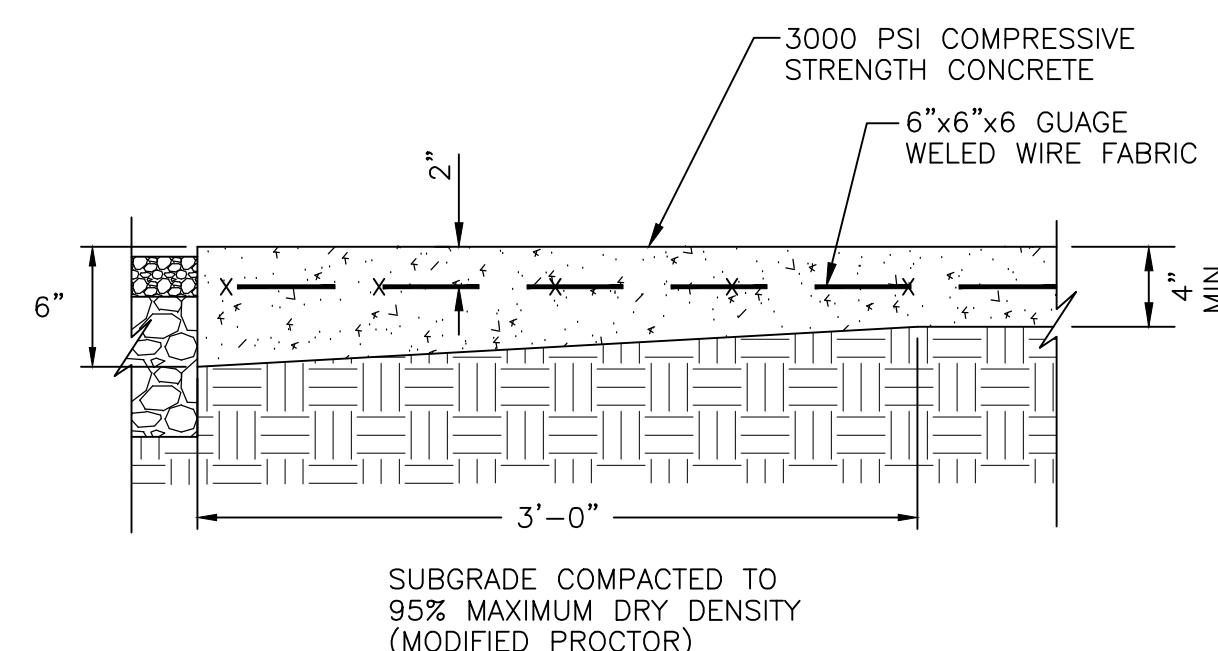
8 CONTROL JOINT DETAIL
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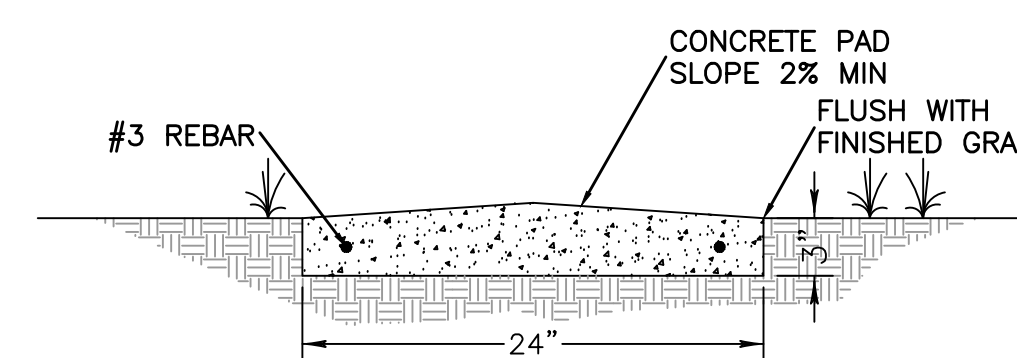
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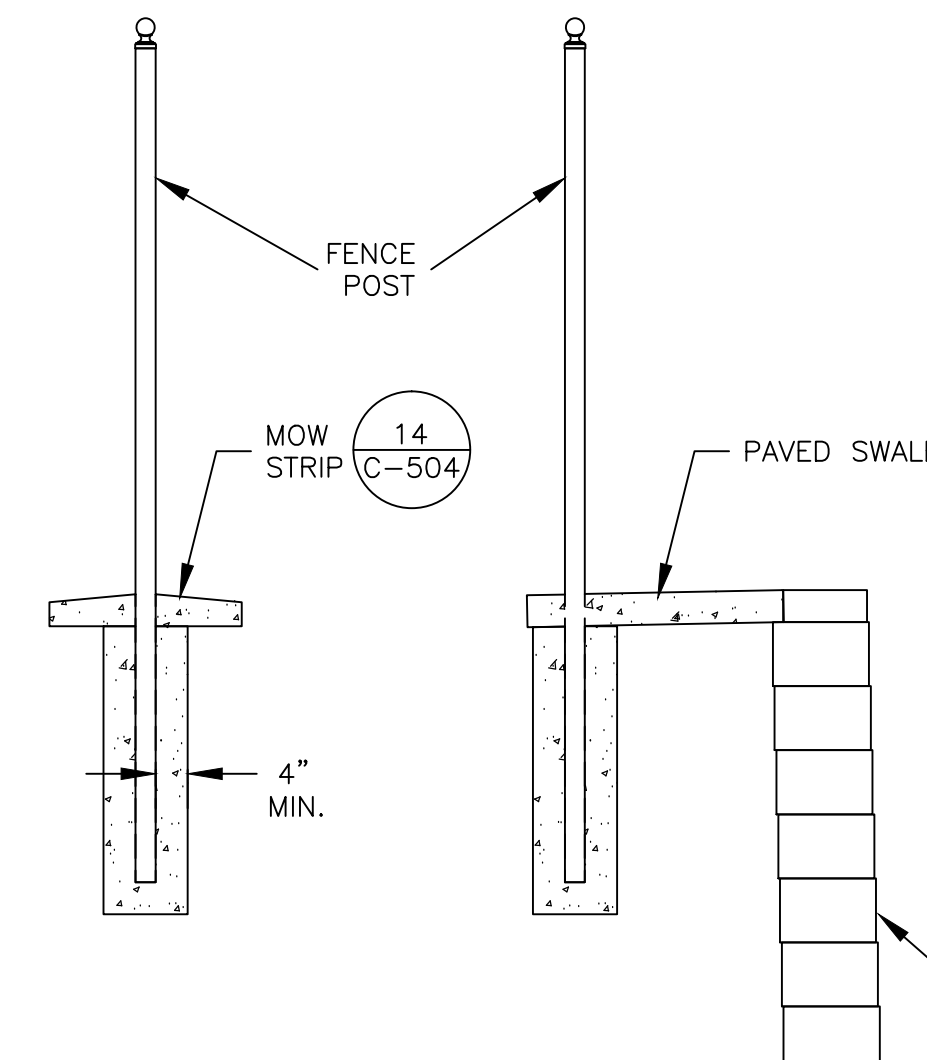
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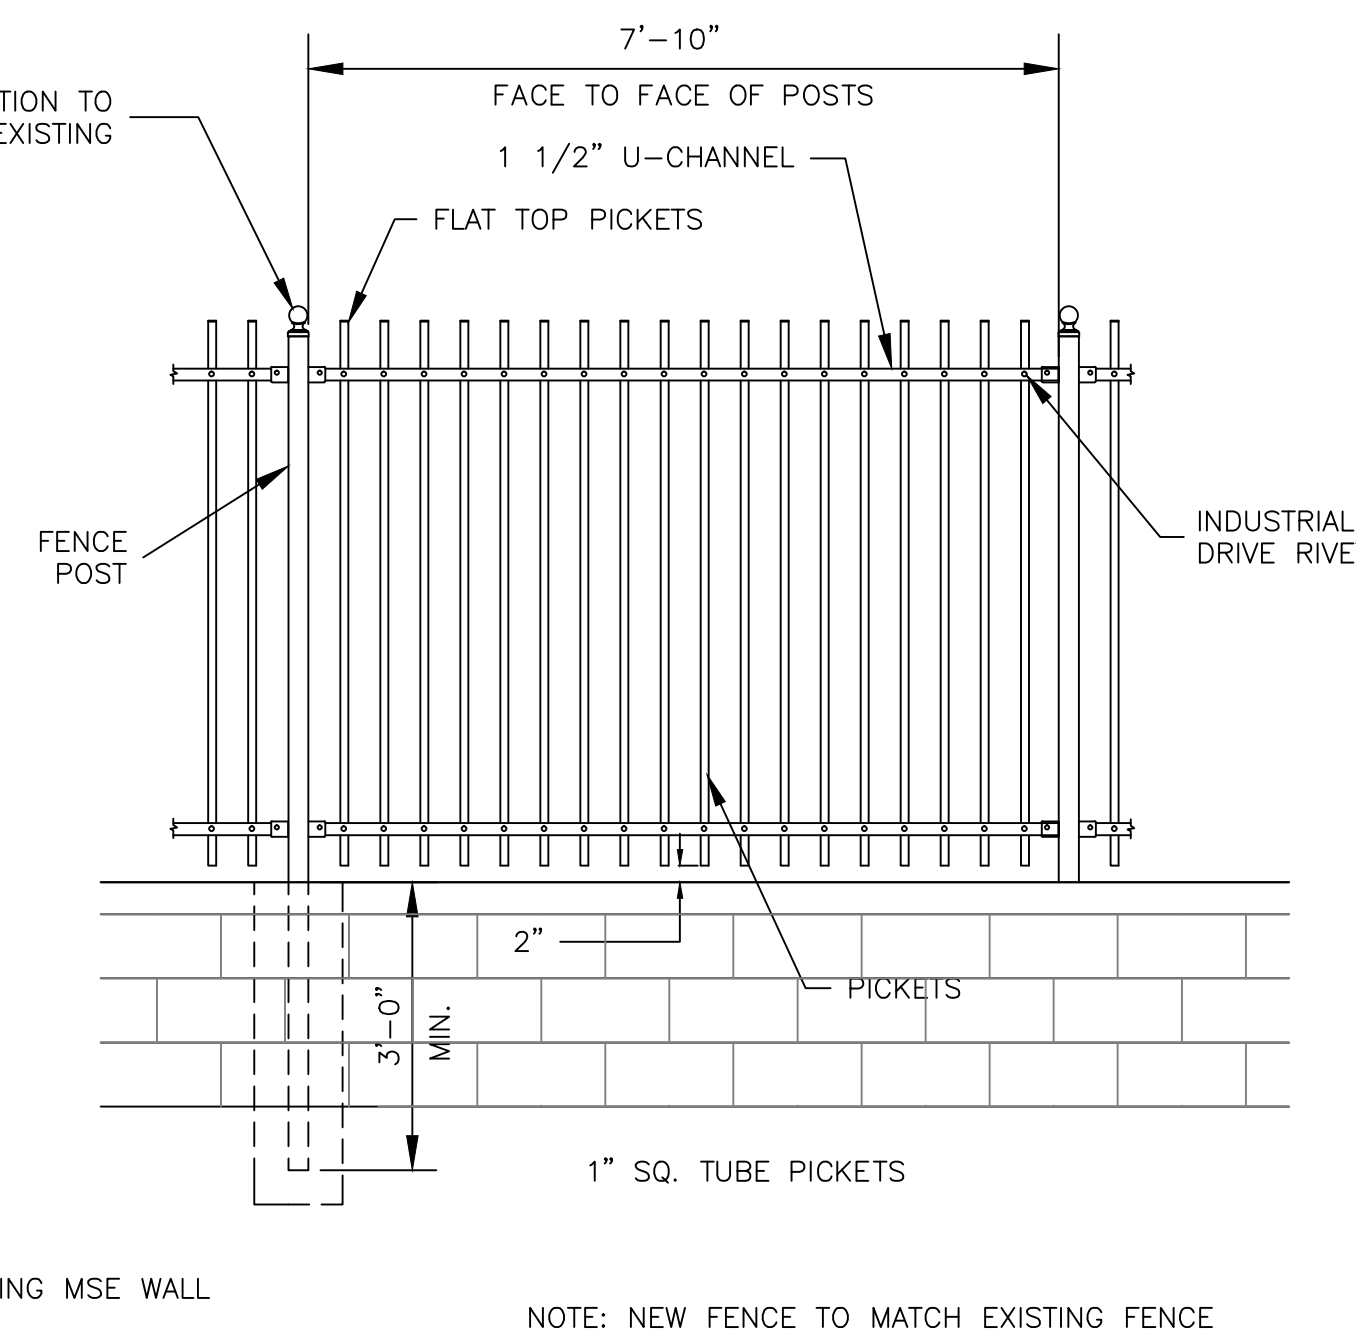
13 CONCRETE PAVEMENT ADJACENT TO NICHE UNIT
N.T.S.

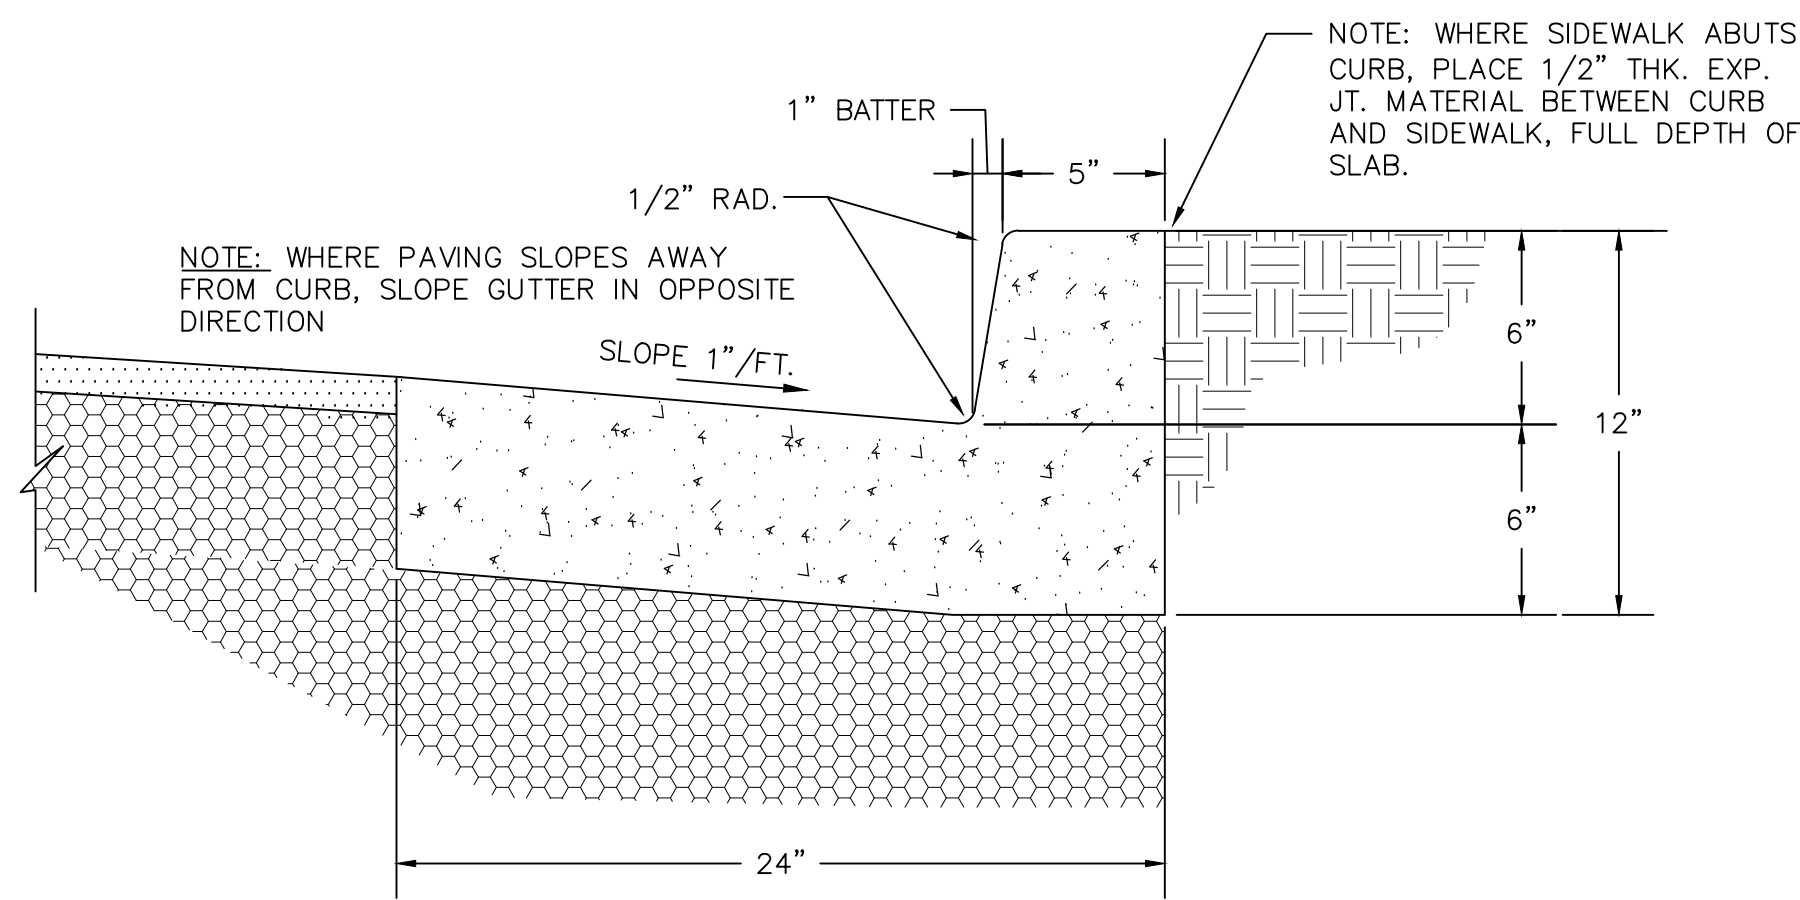


14 CONCRETE MOW STRIP - LAWN APPLICATION
N.T.S.

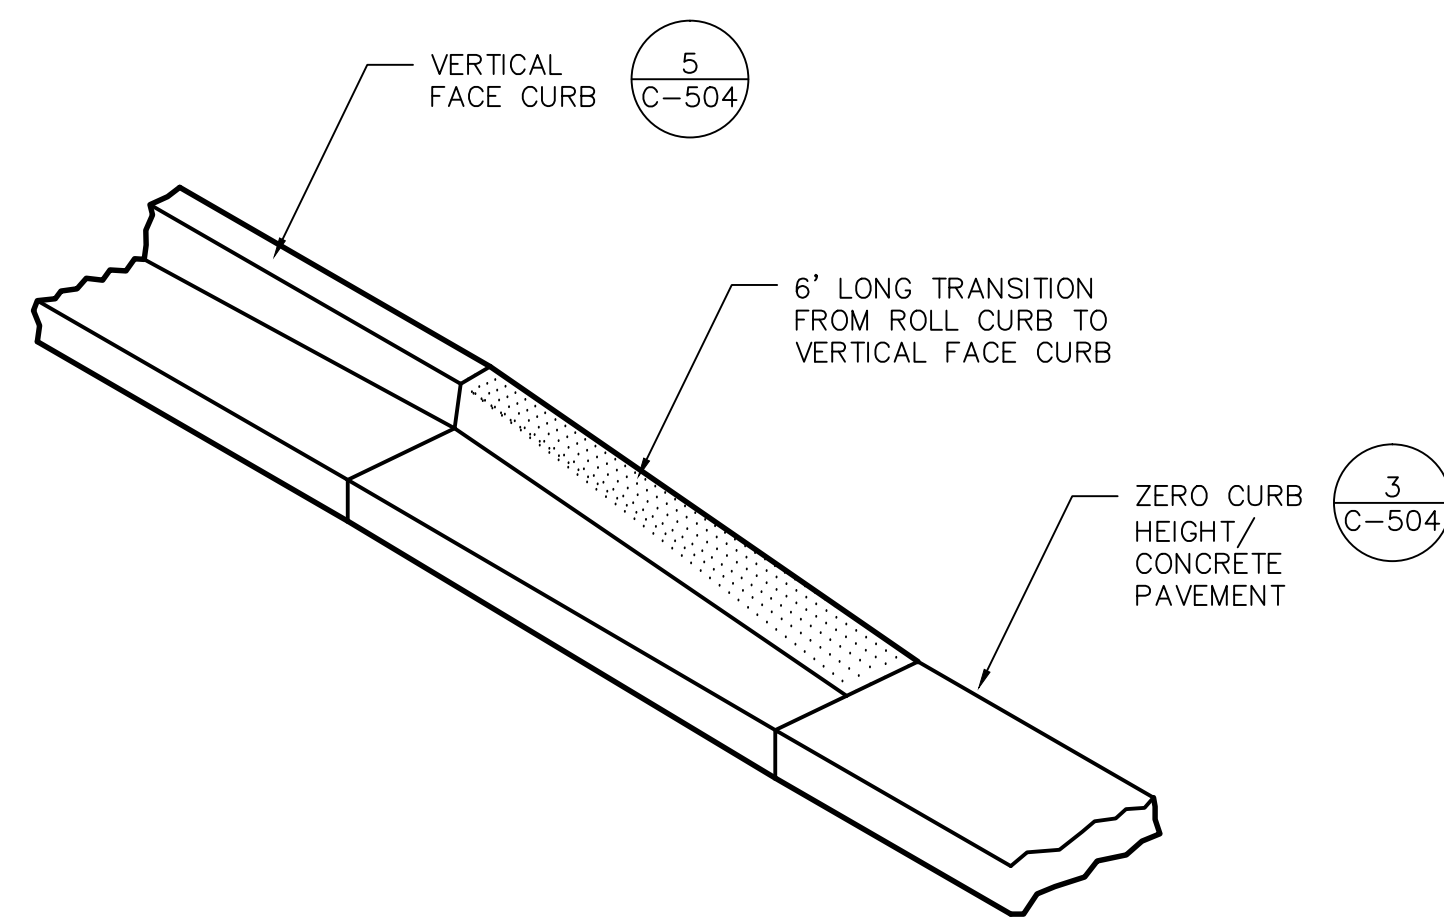


15 ORNAMENTAL FENCE DETAIL
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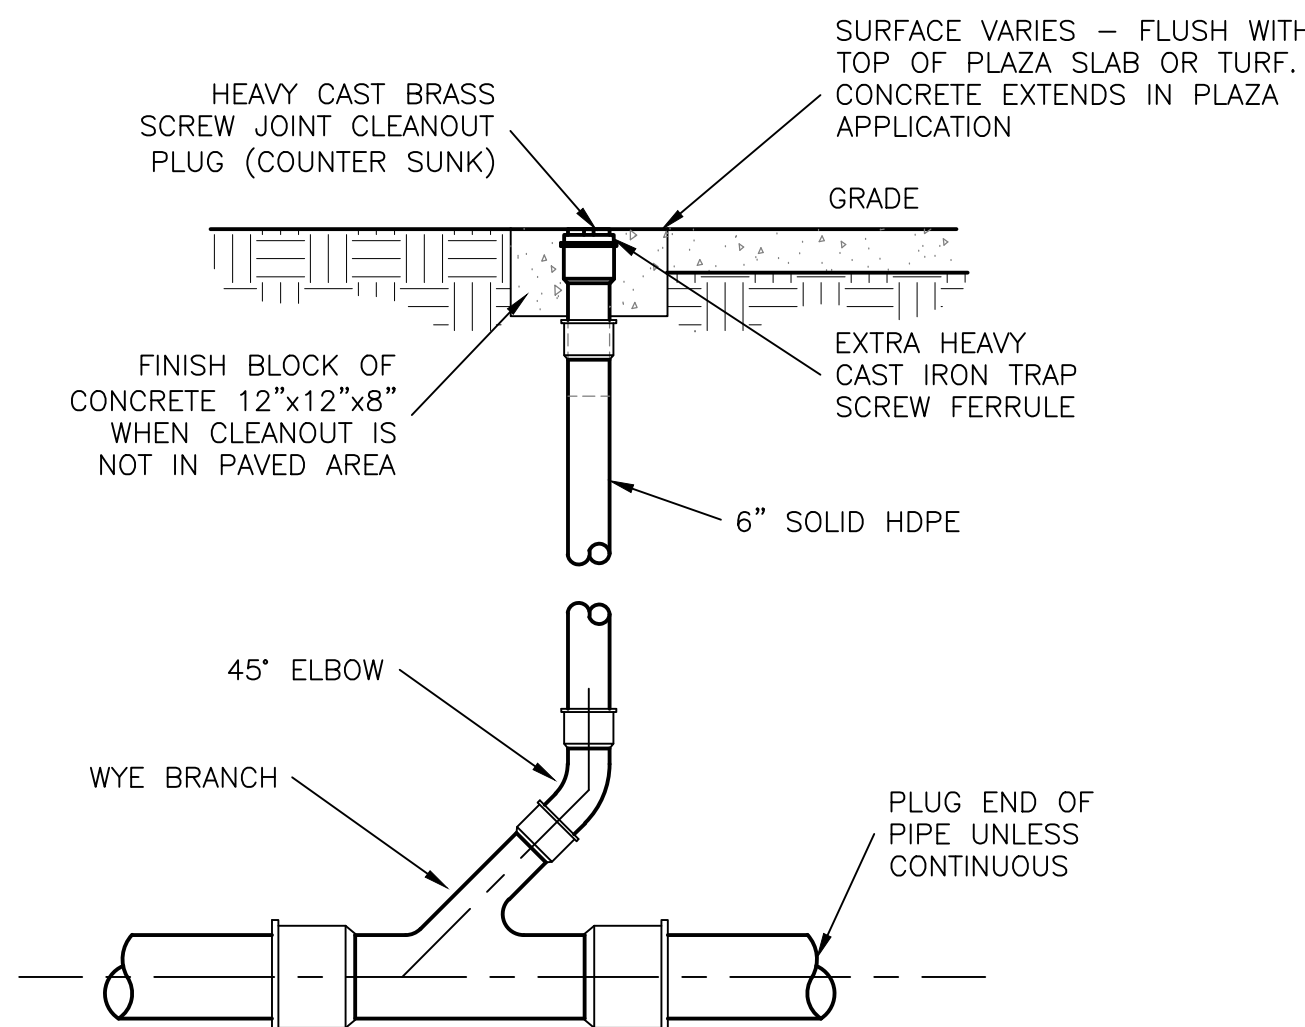
Revisions		Date		PRIME:		MEP ENGINEER:		IRRIGATION DESIGNER:		DRAWING TITLE		PROJECT TITLE		DATE	
				amec foster wheeler				Irrigation Consultant Services		DETAILS 4		4000 NICHE COLUMBARIUM GEORGIA NATIONAL CEMETERY		23 OCTOBER 2015	
				AMEC FOSTER WHEELER ENVIRONMENT & INFRASTRUCTURE 1075 BIG SHANTY ROAD NW, SUITE 100 KENNESAW, GA. 30144 (770) 421-3400 AMEC PROJECT: 6166-15-0011				2231 Weatherstone Circle Conyers, GA 30094 (770) 929-0884, fax (770) 760-8025		Approved: Director, Technical Support Service		Building Number		Checked	
										Approved: Chief, Architectual & Engineering Division		Location		DRAWING NO.	
												1080 VETERANS CEMETERY RD, CANTON, GA 30114		C-504	
														Sheet 19 Of 31	

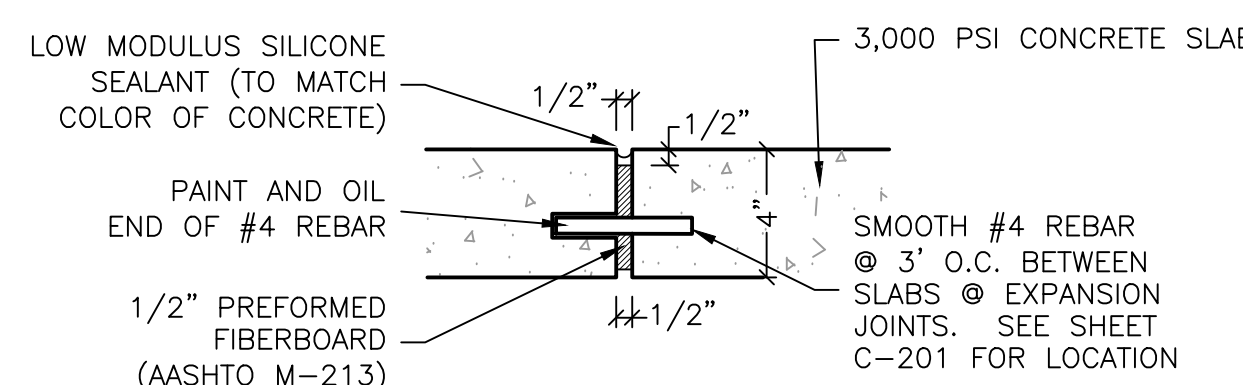


9 CLEAN OUT DETAIL - FLOWER STRIP APPLICATION
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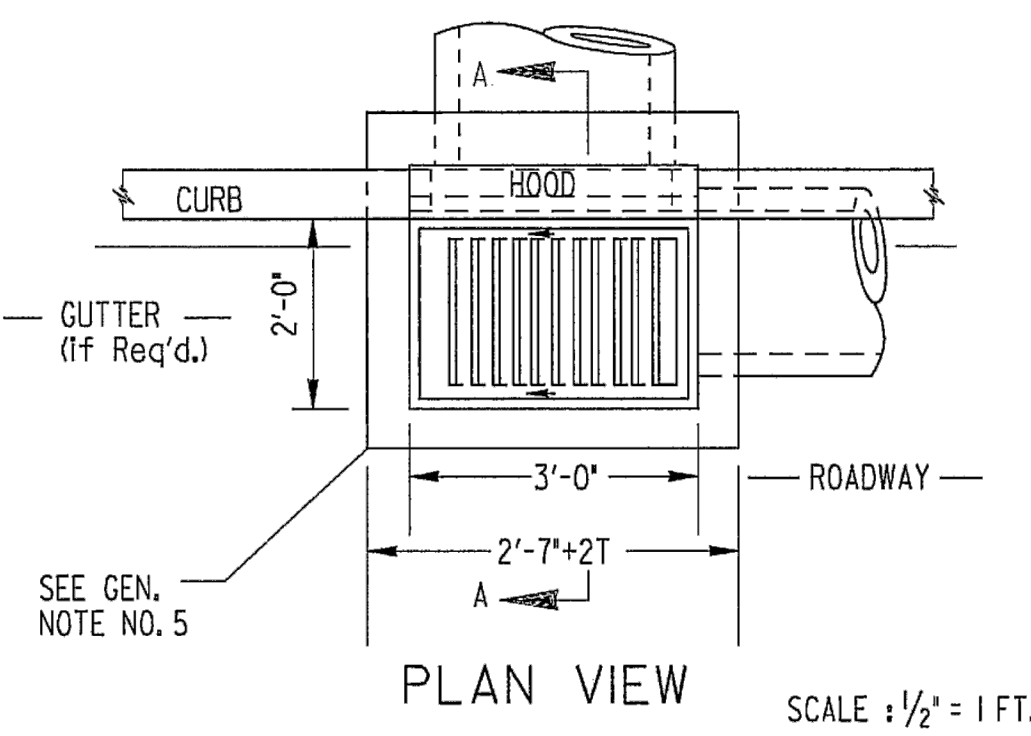
1 BASIS OF DESIGN - CONCRETE ALTERNATIVES MAY BE SUBMITTED.
UNDERGROUND DETENTION FACILITY
N.T.S.

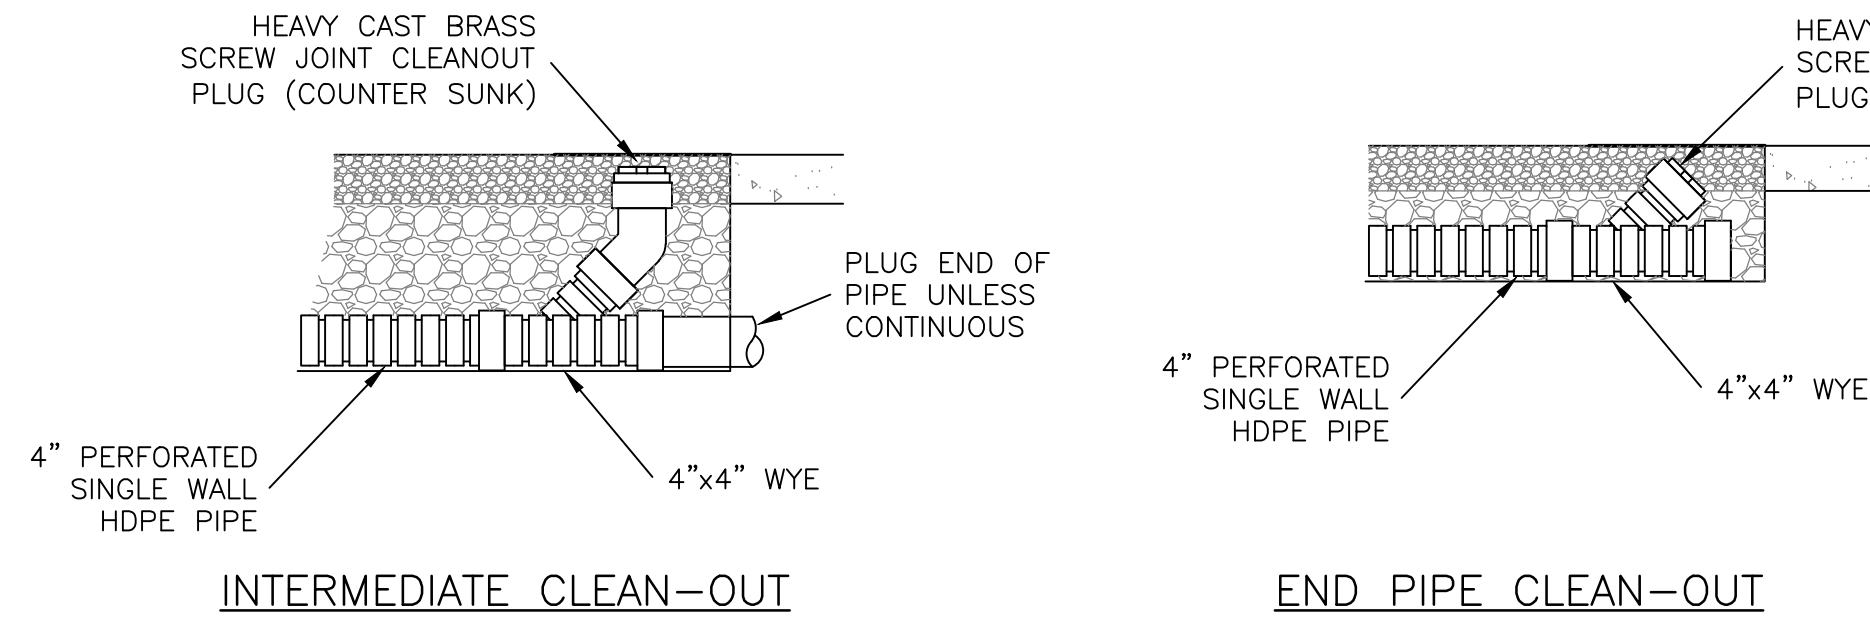




7 CLEAN OUT DETAIL - TURF/PLAZA APPLICATION
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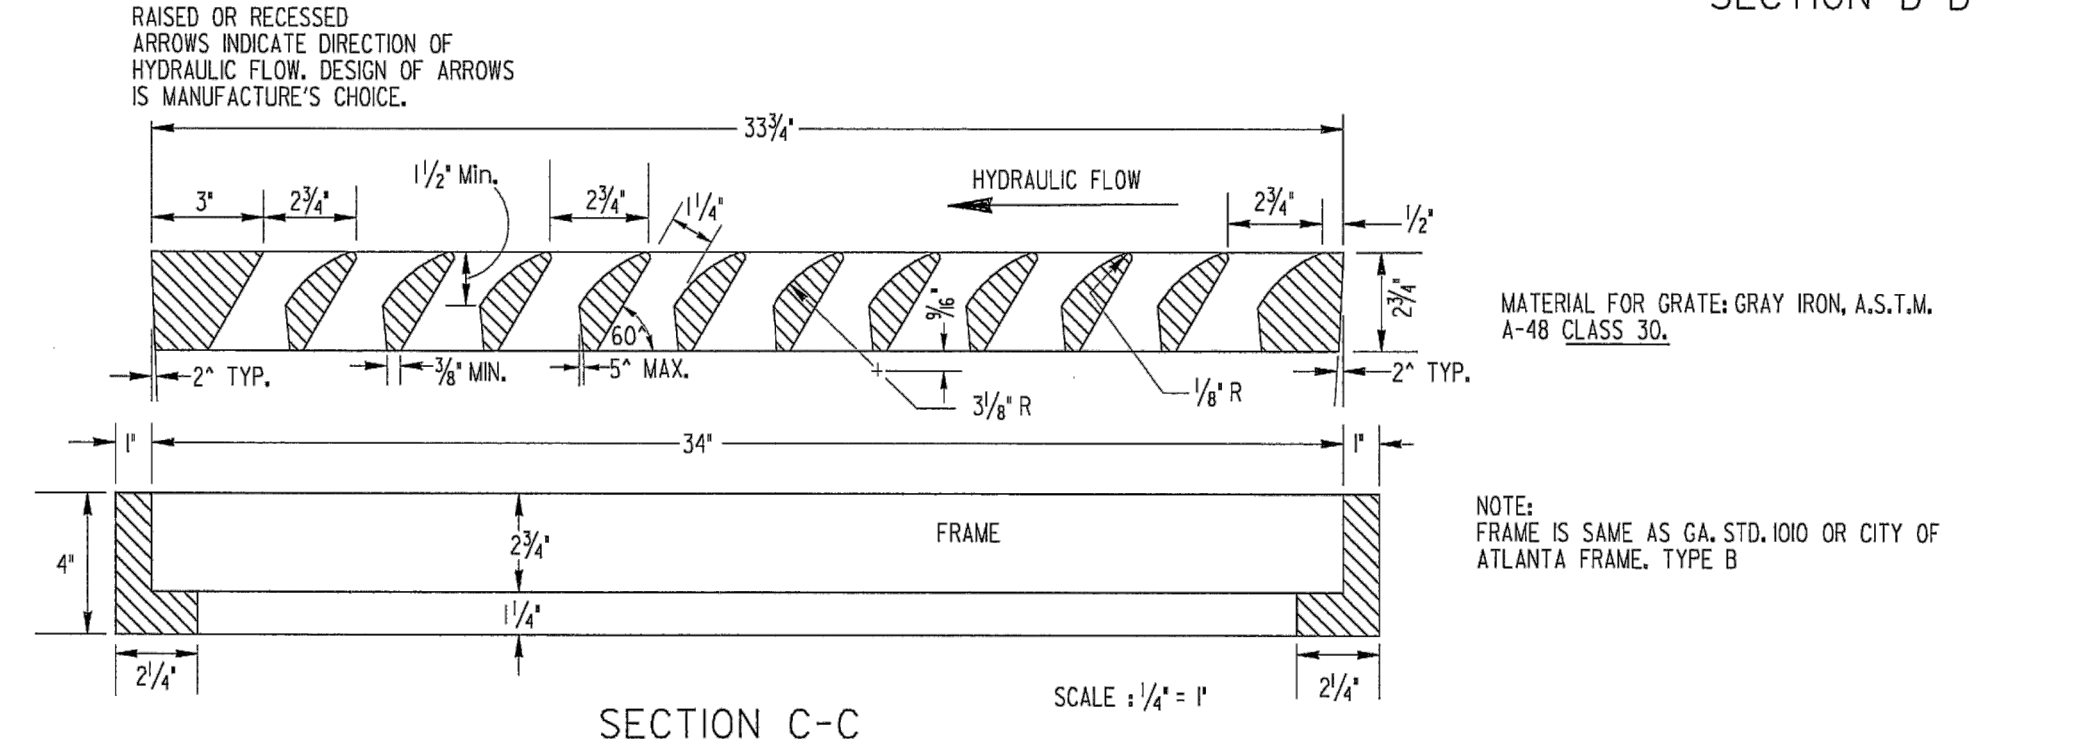
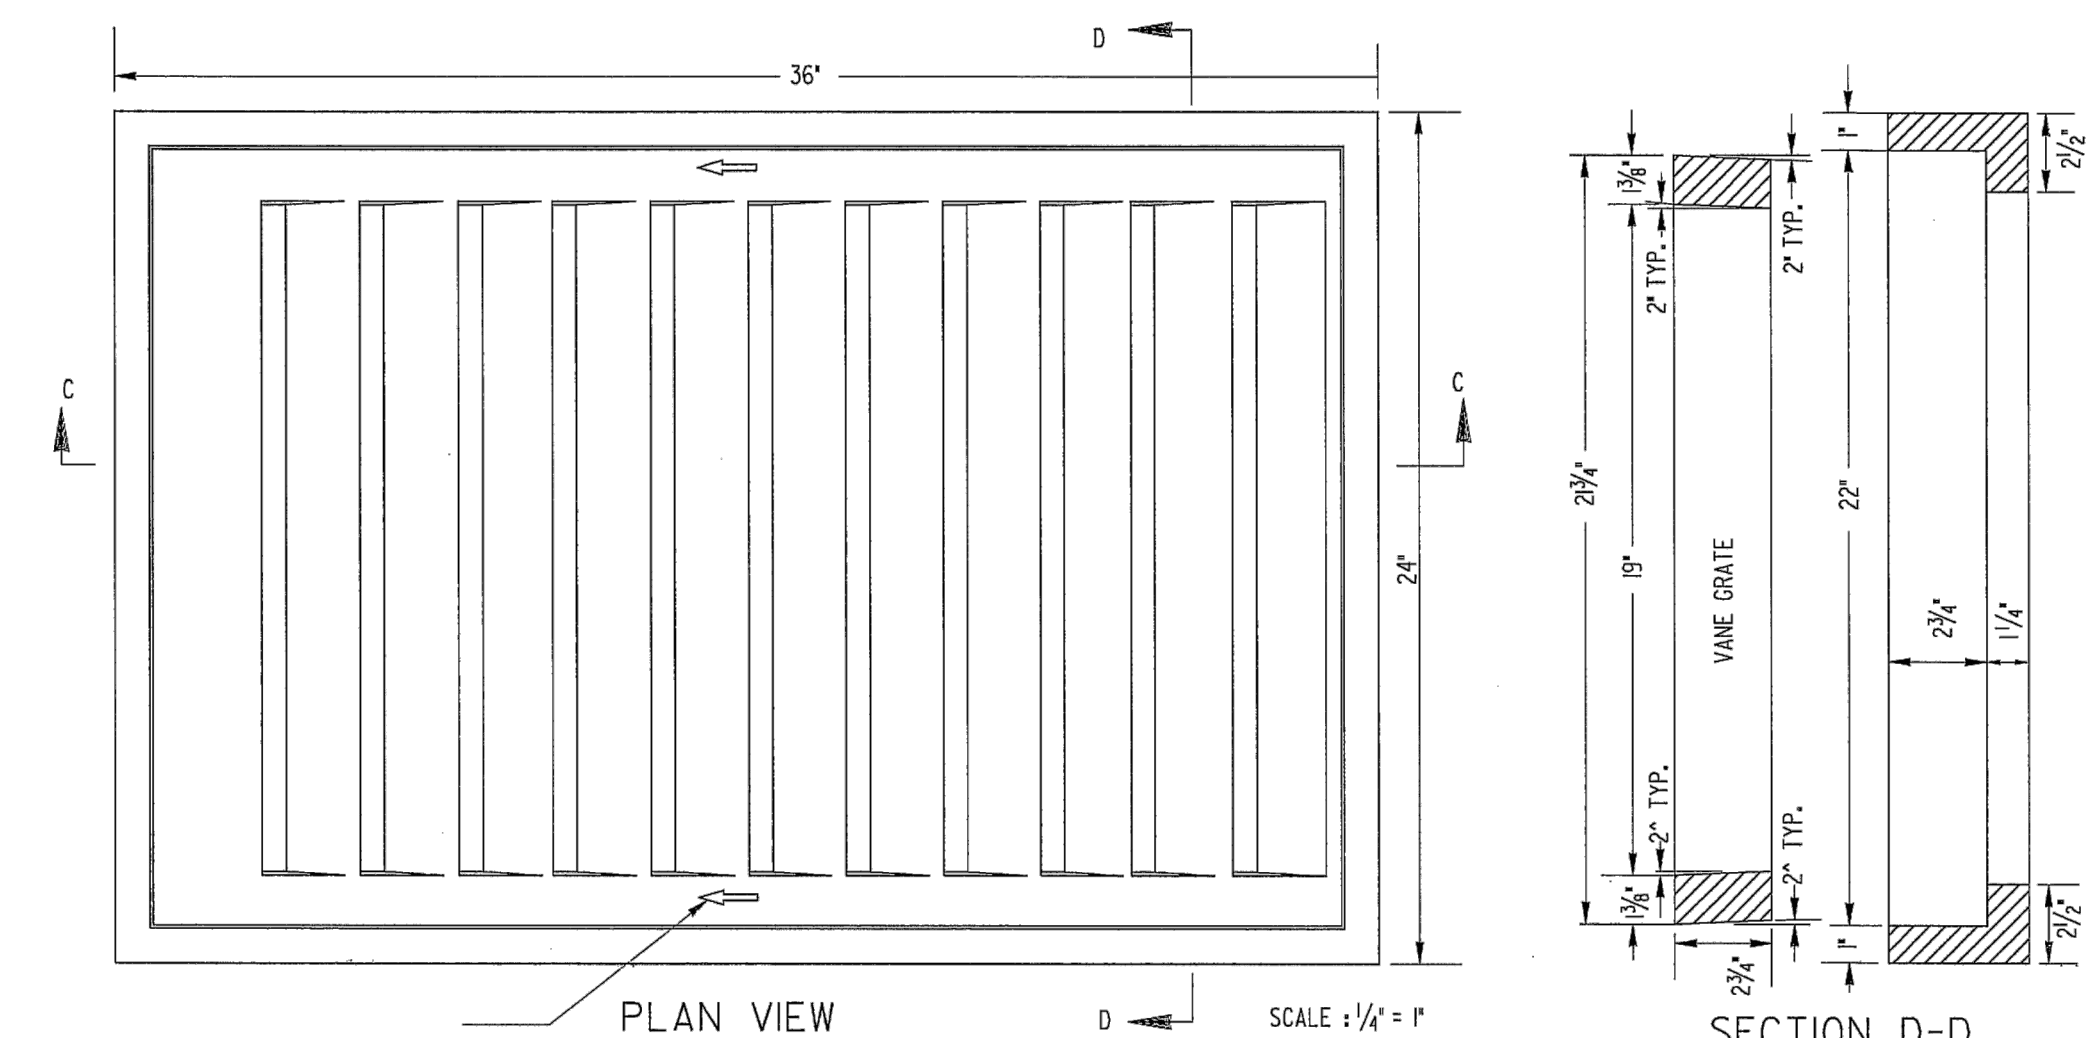
8 OUTLET CONTROL STRUCTURE
N.T.S.

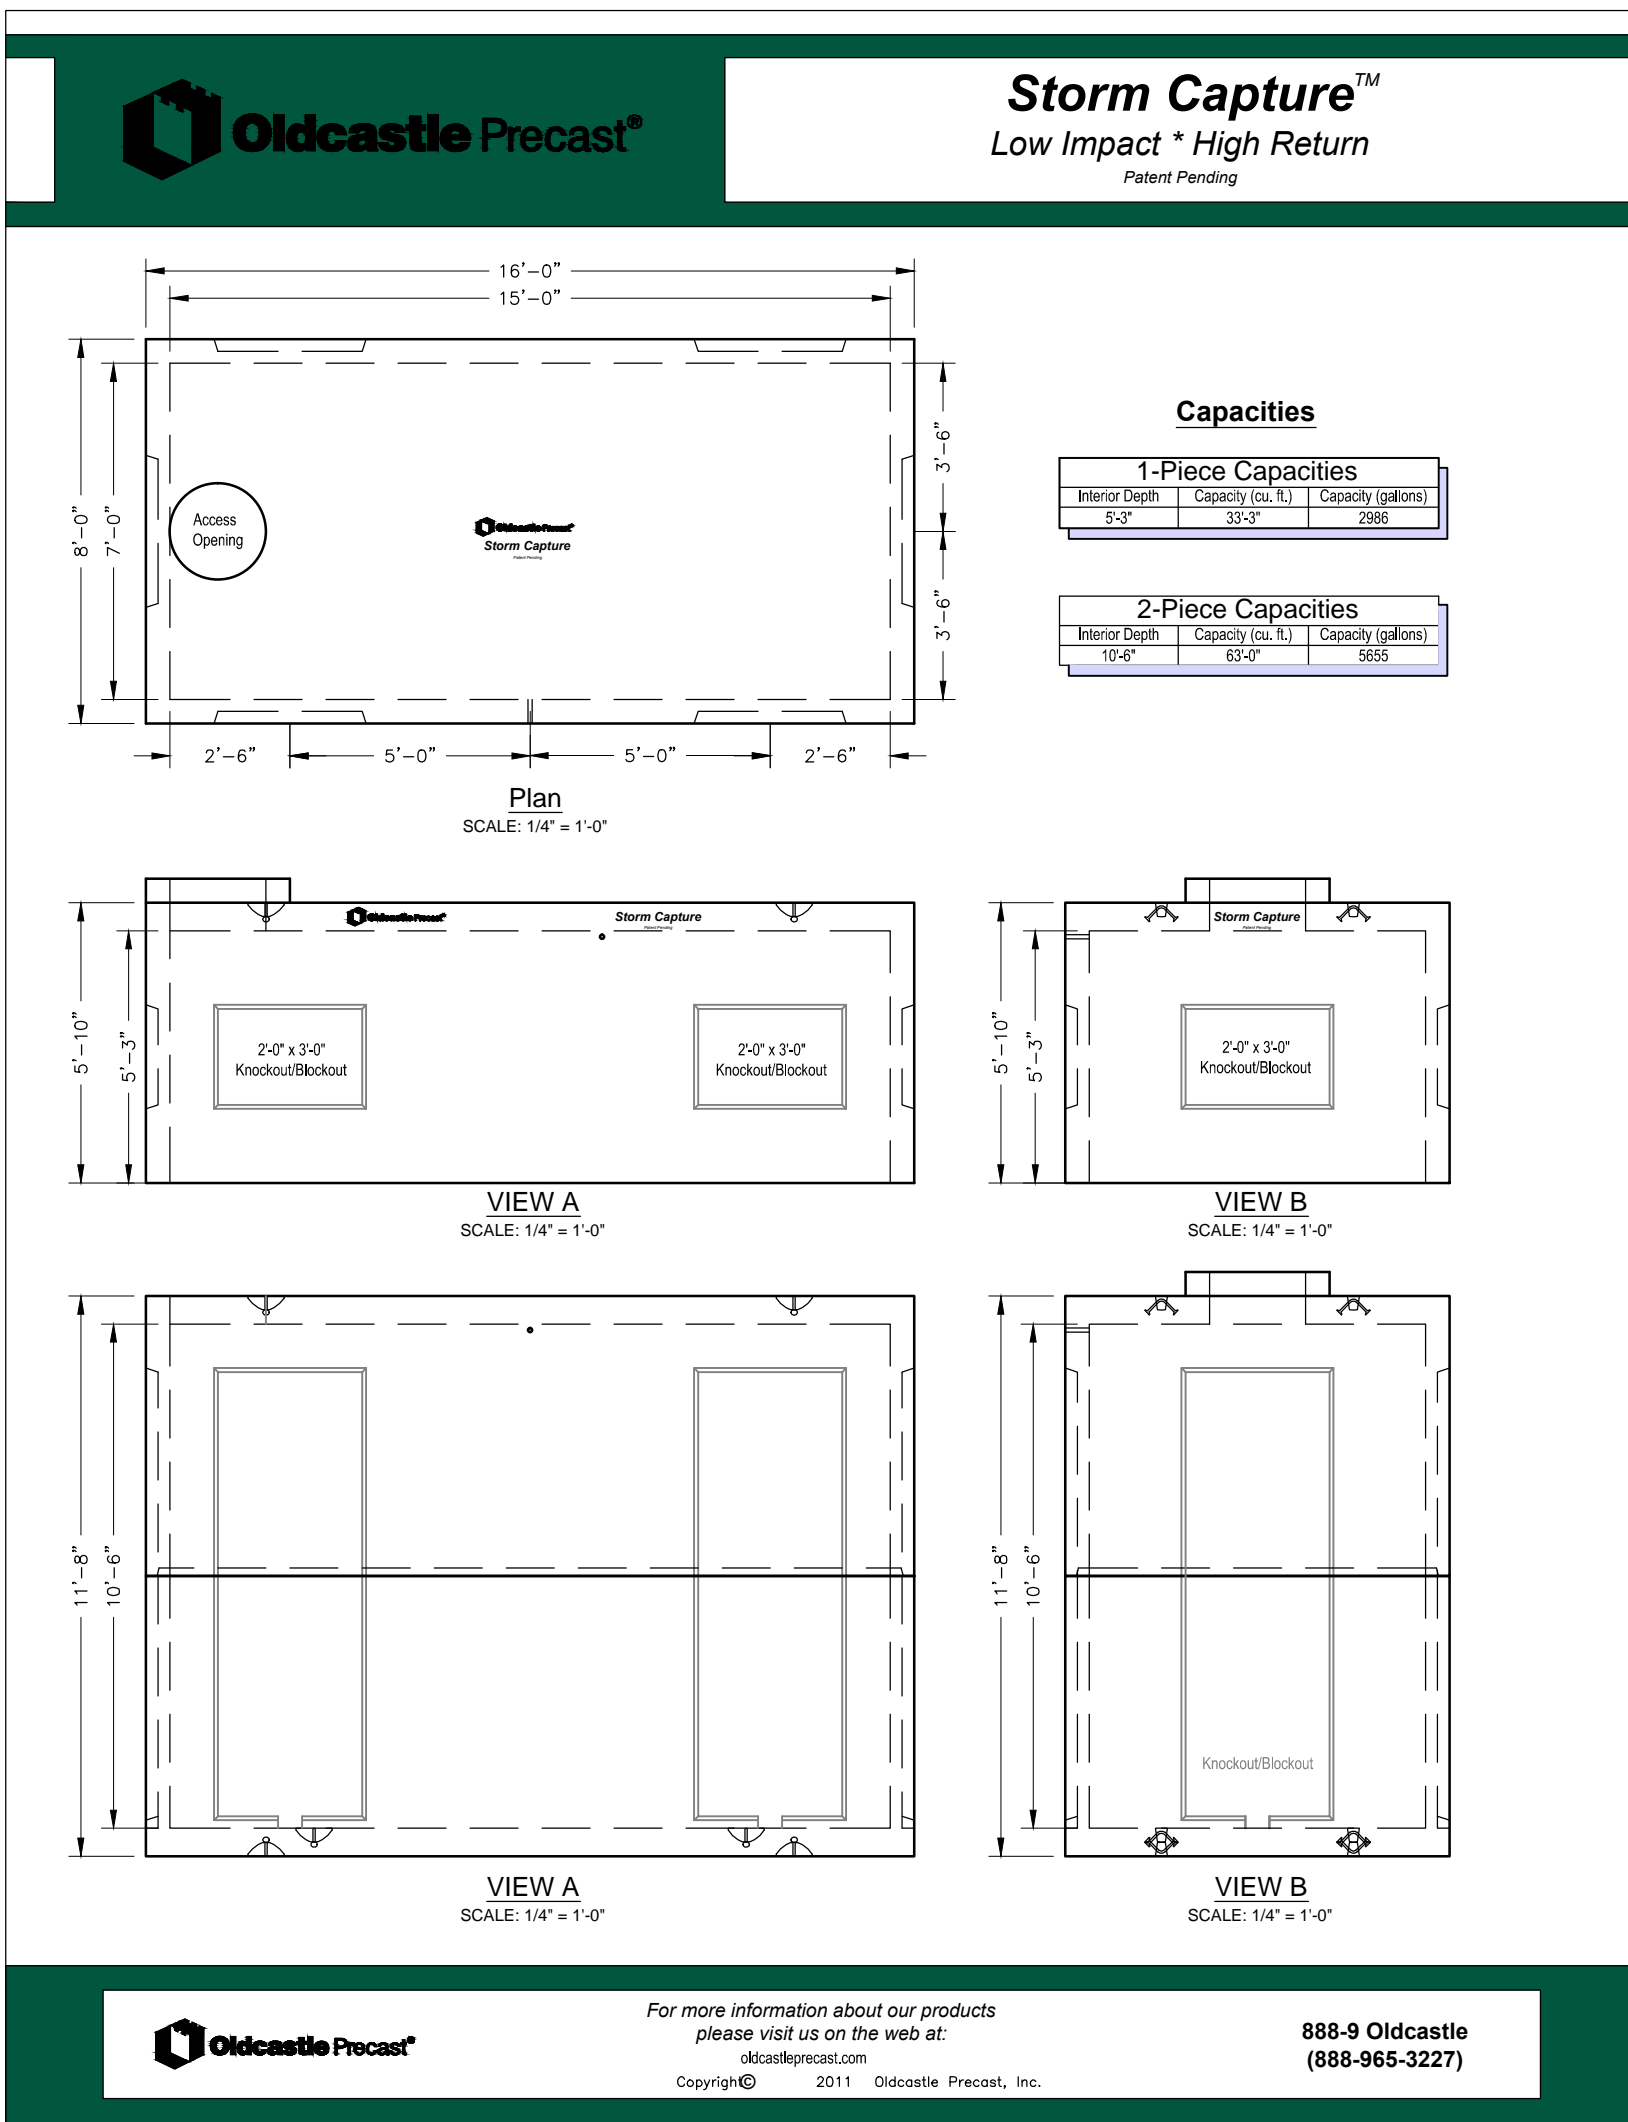

5 24-INCH DIAMETER BEEHIVE GRATE
N.T.S.


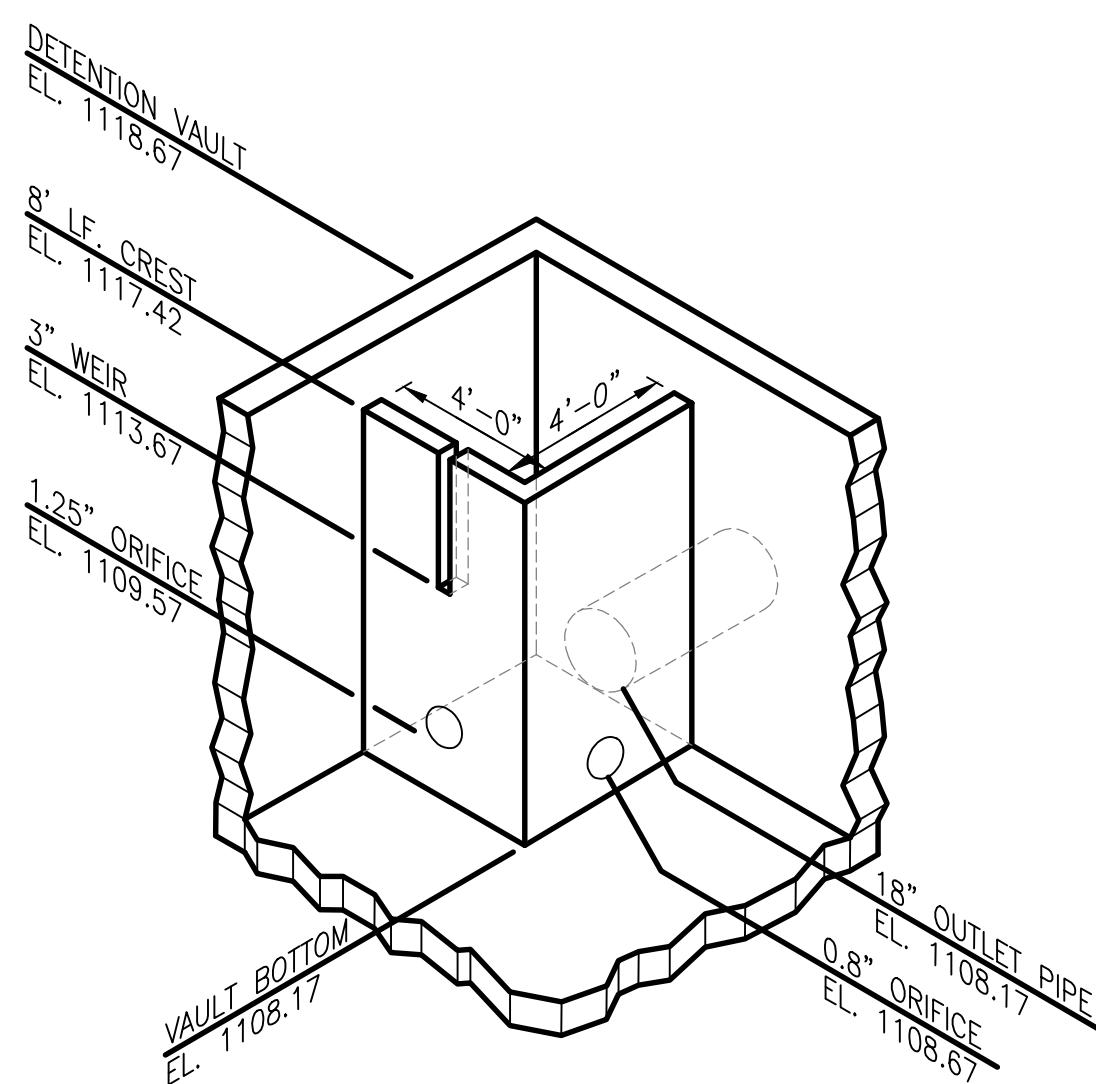


2 CURB INLET DETAIL - GDOT STD. 1019
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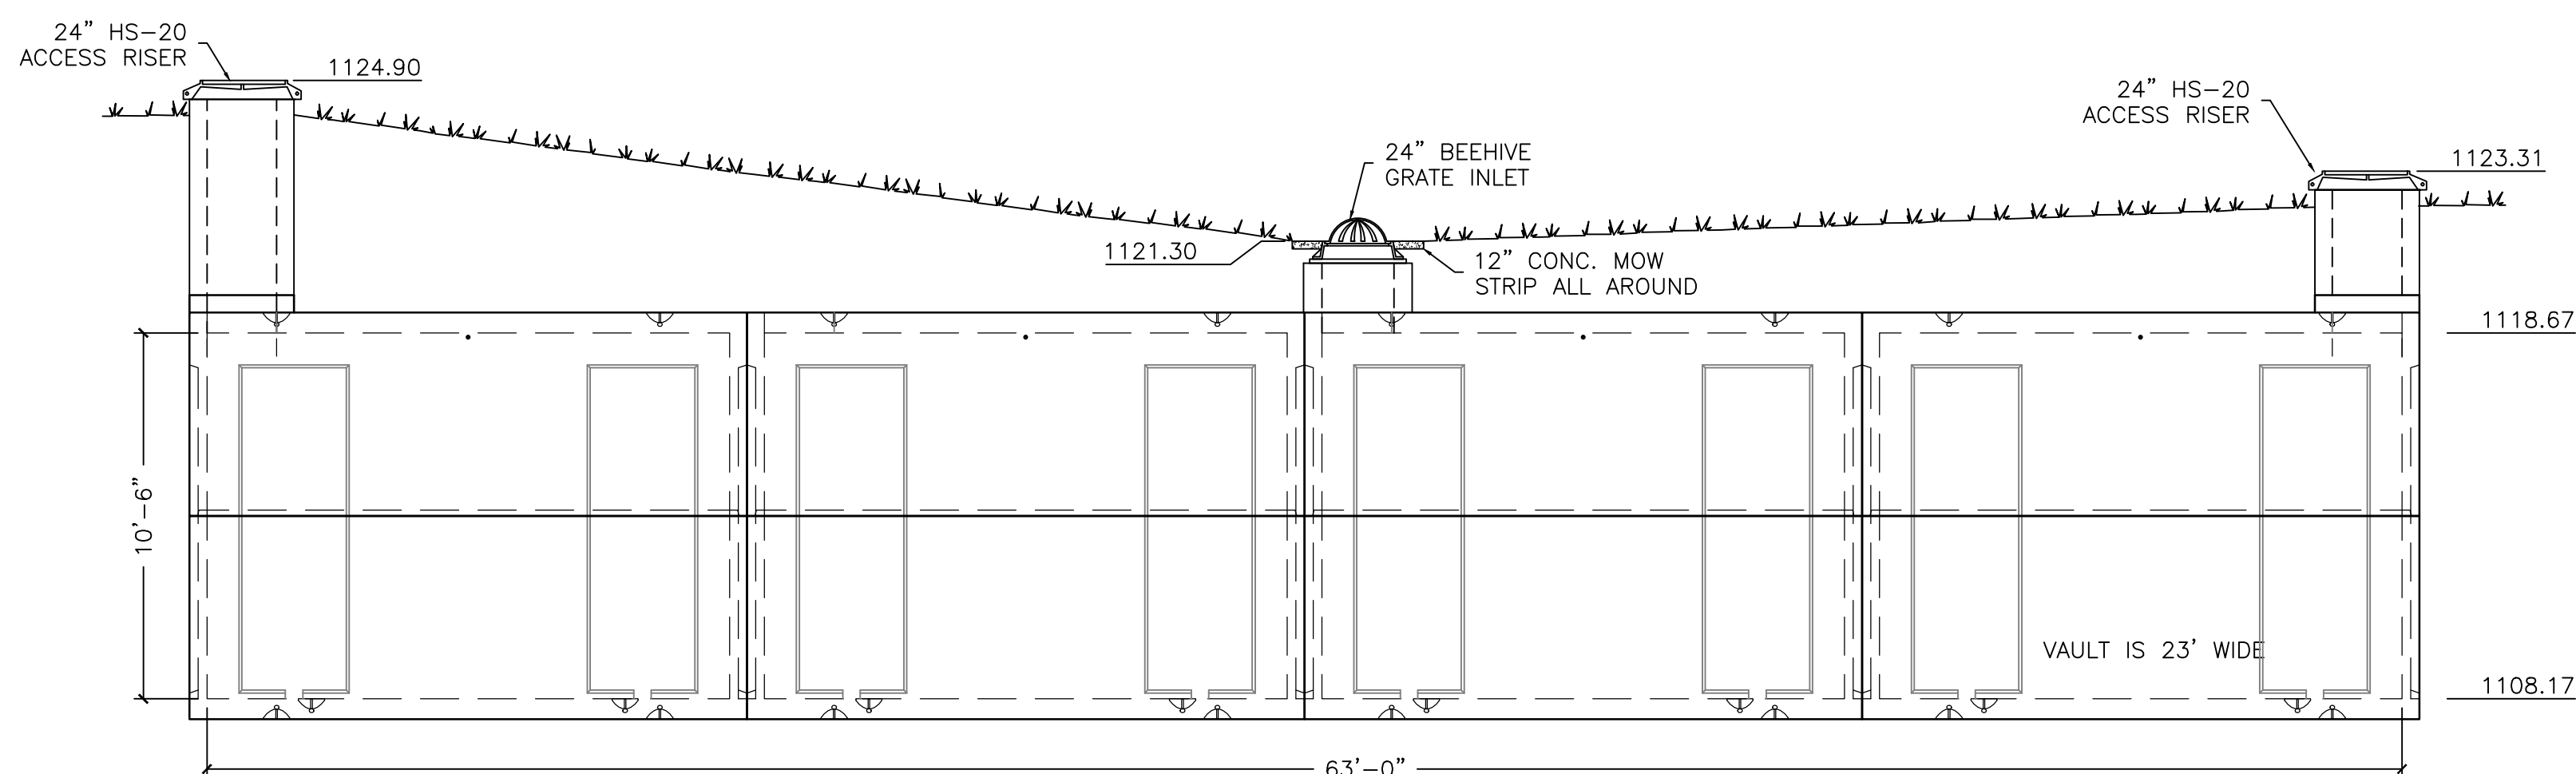


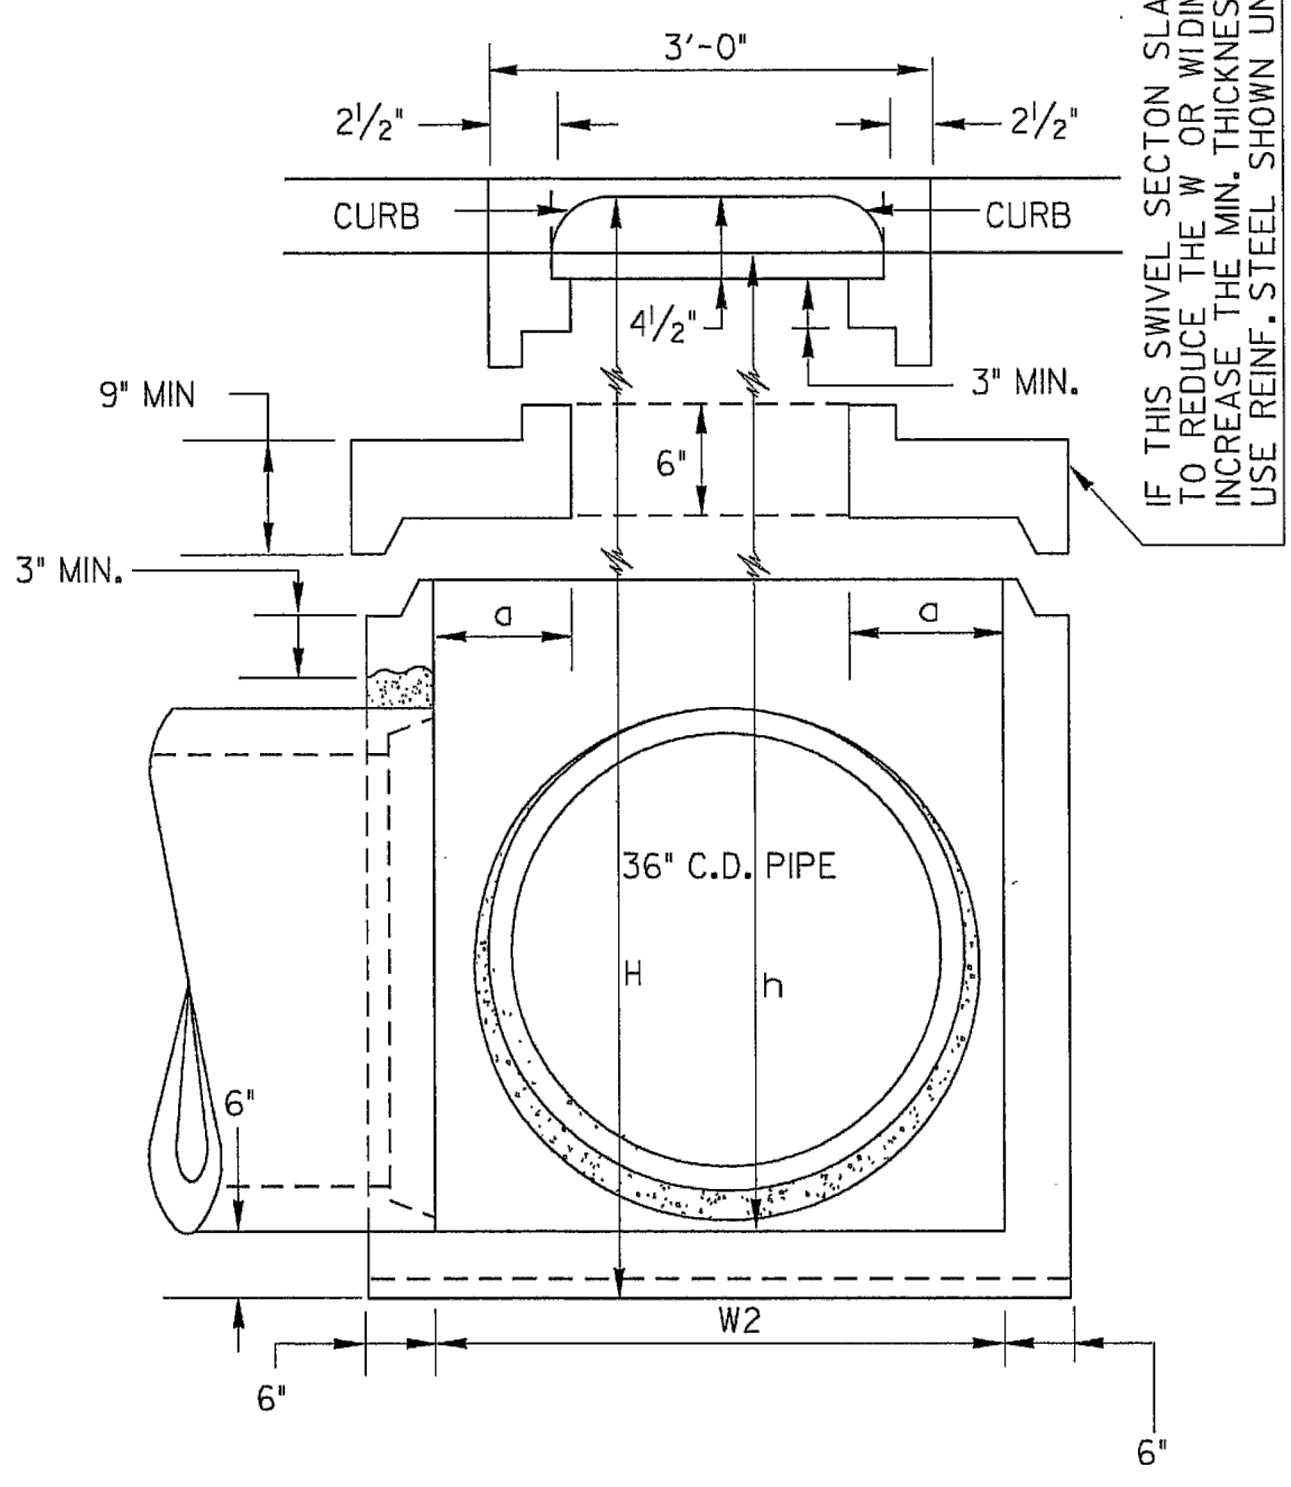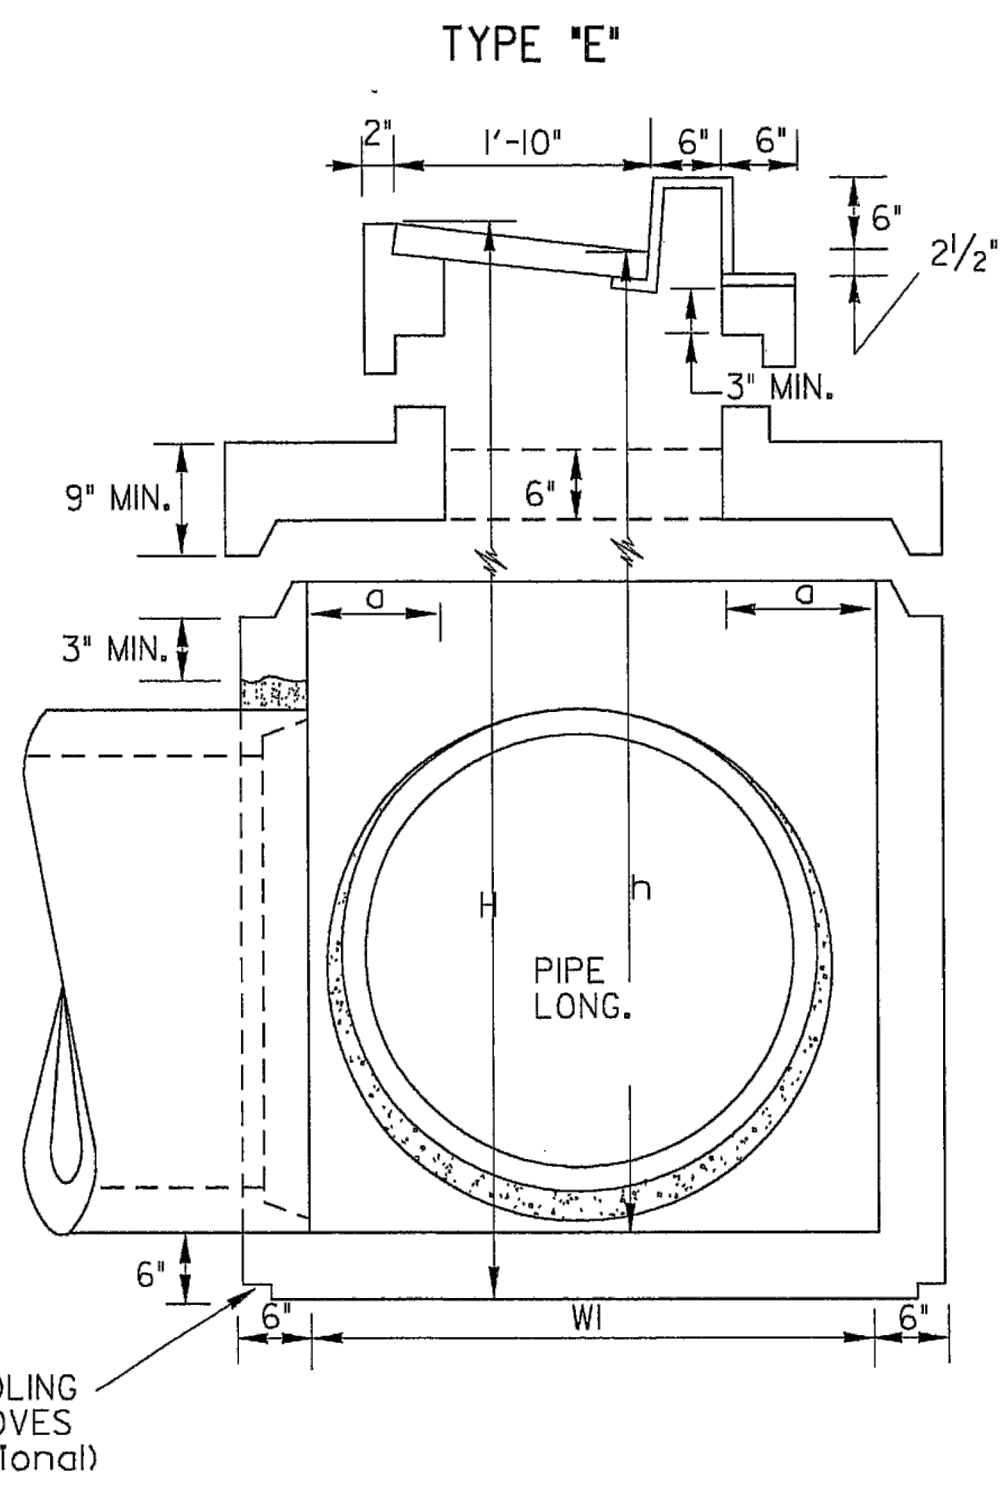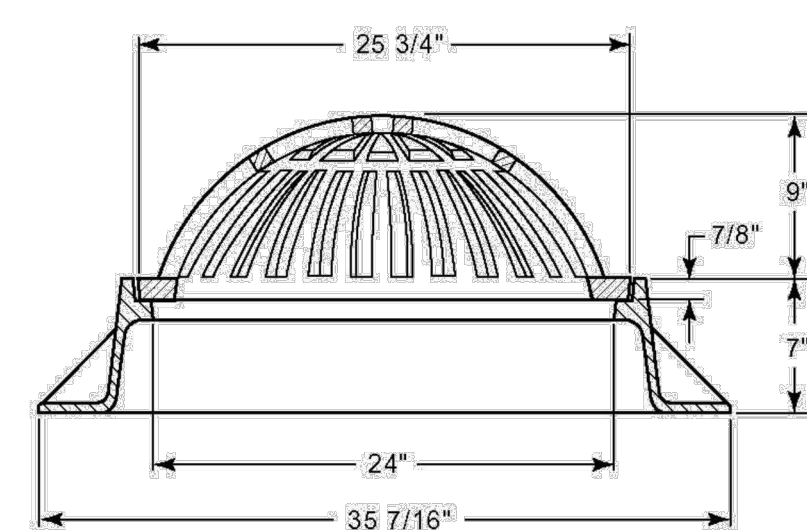SPECIAL NOTE:
BARS OF GRATE WILL BE PERPENDICULAR
TO DIRECTION OF TRAFFIC FLOW.

6 NICHE WALL DRAINAGE SYSTEM
N.T.S.

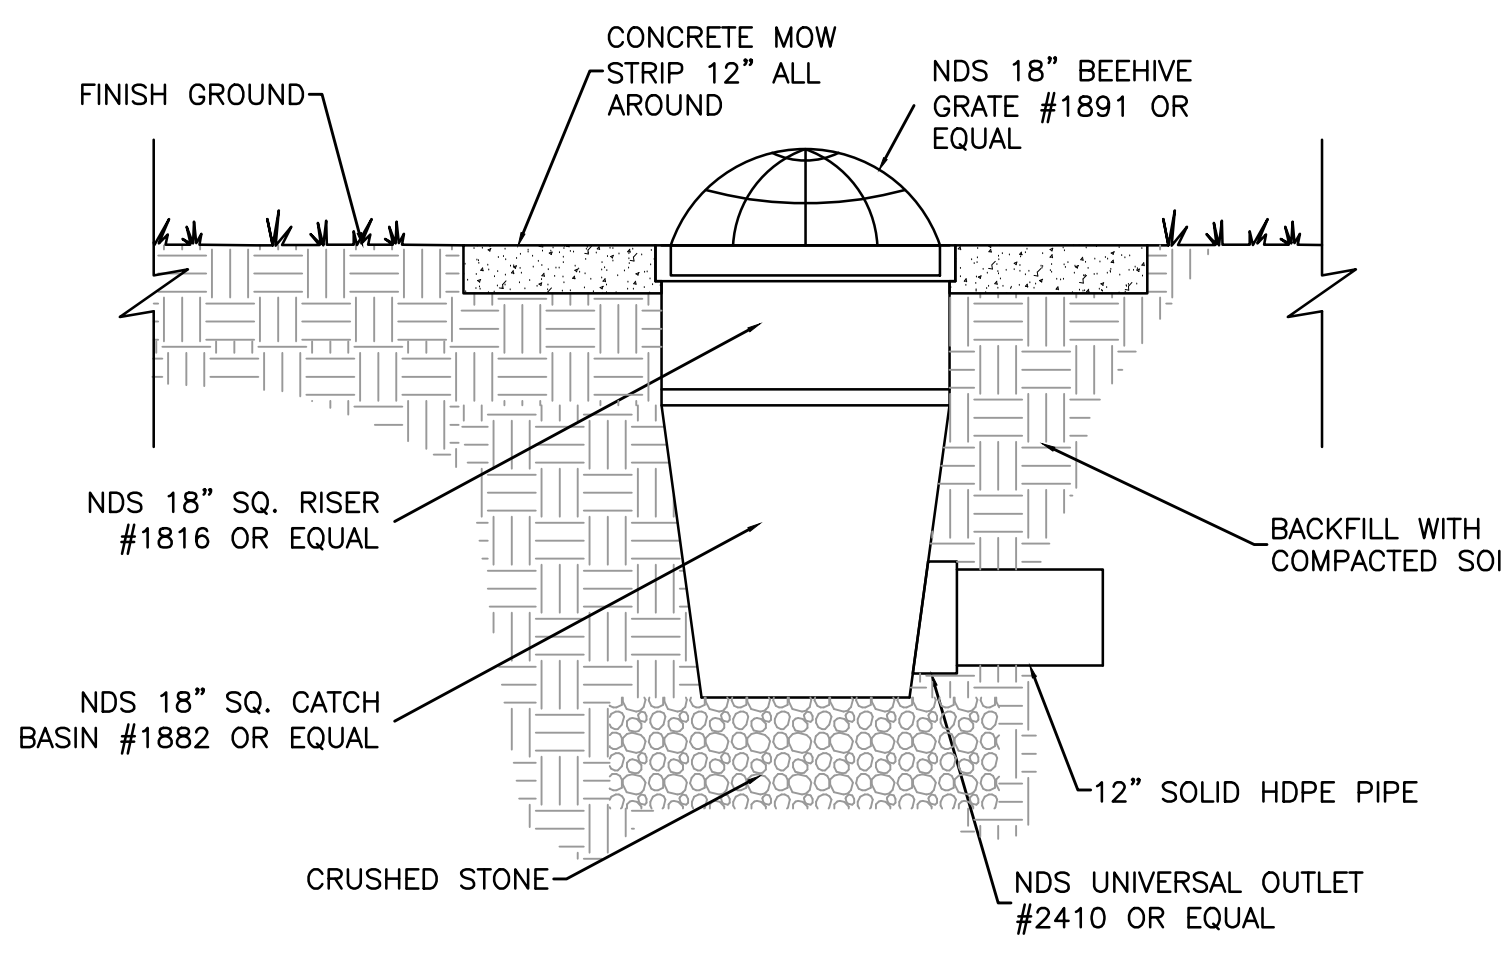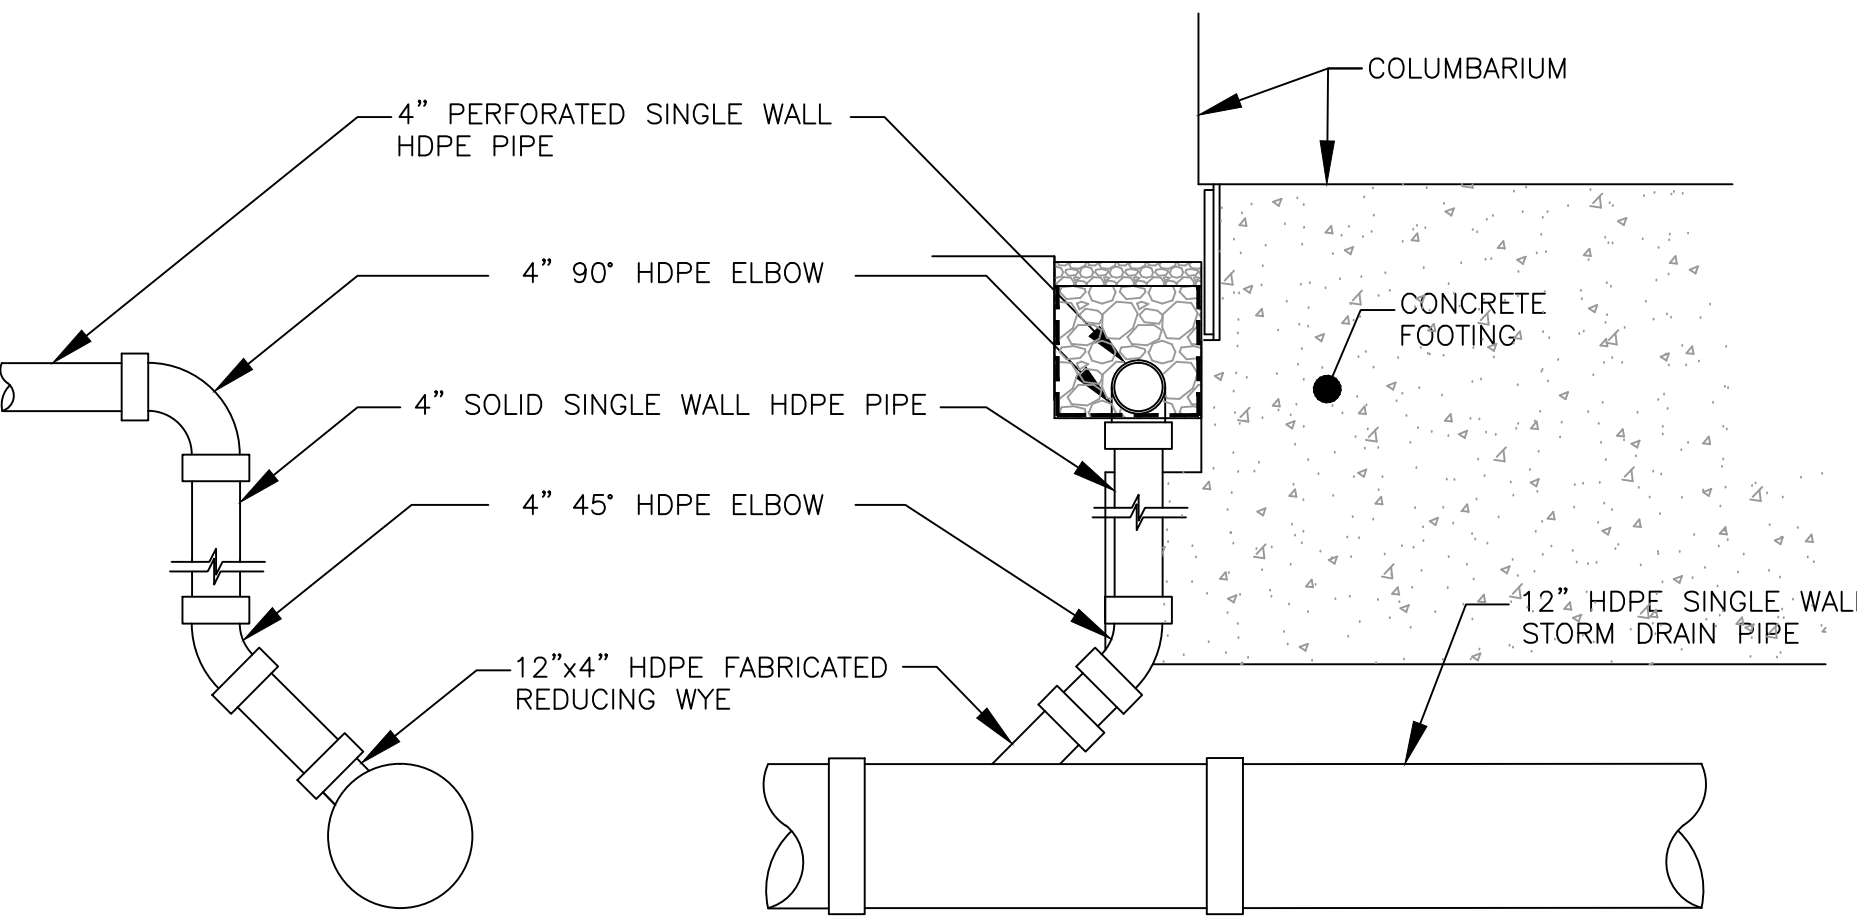

3 YARD INLET DETAIL
N.T.S.



4 STORMWATER VAULT TYPICAL ELEVATION
N.T.S.

		<div><div><div>amec foster wheeler</div></div><div>AMEC FOSTER WHEELER ENVIRONMENT & INFRASTRUCTURE 1075 BIG SHANTY ROAD NW, SUITE 100 KENNESAW, GA. 30144 (770) 421-3400 AMEC PROJECT: 6166-15-0011</div></div>		<div><div>MEP ENGINEER:</div><div></div></div>		<div><div></div></div>		<div><div><div>IRRIGATION DESIGNER:</div><div><div>Irrigation Consultant Services</div></div><div>2231 Weatherstone Circle Conyers, GA 30094 (770) 929-0884, fax (770) 760-8025</div></div></div>		<div><div><div>NATIONAL CEMETERY ADMINISTRATION</div></div></div>		<div><div><div>Drawing Title</div><div>DETAILS 5</div><div>Approved: Director, Technical Support Service</div><div>Approved: Chief, Architectual & Engineering Division</div></div></div>		<div><div><div>Project Title</div><div>4000 NICHE COLUMBARIUM GEORGIA NATIONAL CEMETERY</div><div>Building Number</div><div>Checked</div><div>Drawn</div><div>Location</div><div>1080 VETERANS CEMETERY RD, CANTON, GA 30114</div></div></div>		<div><div><div>Date</div><div>23 OCTOBER 2015</div><div>Project No.</div><div>922CM3005</div><div>DRAWING NO.</div><div>C-505</div><div>Sheet 20 Of 31</div></div></div>	
Revisions		Date															

Ds1 DISTURBED AREA STABILIZATION (WITH MULCH ONLY)

MULCHING APPLICATION REQUIREMENTS

MATERIAL	RATE	DEPTH
STRAW OR HAY	2 1/2 TON/ACRE	6" TO 10"
GEOTEXTILES, JUTE MATTING, NETTING, ETC.	SEE MANUFACTURERS RECOMMENDATIONS	---

Ds3 DISTURBED AREA STABILIZATION (WITH PERMANENT VEGETATION)

TABLE 1
SOME PERMANENT PLANT SPECIES, SEEDING RATES, AND PLANTING DATES

SPECIES	RATES PER ACRE	RATES PER 1,000 SQ. FT.	PLANTING DATES BY REGION			REMARKS
			M-L	P	C	
BAHIA, PENSACOLA ALONE OR WITH TEMPORARY COVER WITH OTHER PERENNIALS	60 LBS. 30 LBS.	1.4 LBS. 0.7 LBS.	-	4/1-5/31	3/1-5/31	LOW GROWING SOD PRODUCING; WILL SPREAD INTO BERMUDA LAWNS.
BAHIA, WILMINGTON ALONE OR WITH TEMPORARY COVER WITH OTHER PERENNIALS	60 LBS. 30 LBS.	1.4 LBS. 0.7 LB.	3/15-5/31	3/1-5/31	-	SAME AS ABOVE.
BERMUDA, COMMON (HULLED SEED) ALONE WITH OTHER PERENNIALS	10 LBS. 6 LBS.	0.2 LB. 0.1 LB.	-	4/1-5/31	3/15-5/31	QUICK COVER; LOW GROWING; SOD FORMING; NEEDS FULL SUN.
BERMUDA, COMMON (UNHULLED SEED) WITH TEMPORARY COVER WITH OTHER PERENNIALS	10 LBS. 6 LBS.	0.2 LB. 0.1 LB.	-	10/15-2/28	11/1-1/31	PLANT WITH WINTER ANNUALS. PLANT WITH TALL FESCUE.
BERMUDA, SPRIGS COMMON LAWN AND FORAGE HYBRIDS	40 CU. FT. SOD PLUGS 3"x3"	0.9 CU. FT.	4/15-6/15	4/1-6/15	4/1-5/31	1 CU. FT. = 650 SPRIGS; 1 BU. = 1.25 CU. FT. OR 800 SPRIGS
CROWN VETCH WITH WINTER ANNUALS OR COOL SEASON GRASSES	15 LBS.	0.3 LB.	9/1-10/15	9/1-10/15	-	MIX WITH 30 LBS. TALL FESCUE OR 15 LBS. RYE; INOCULATE SEED; PLANT ONLY NORTH OF ATLANTA.
FESCUE, TALL ALONE WITH OTHER PERENNIALS	50 LBS. 30 LBS.	1.1 LBS. 0.7 LB.	3/1-4/1 OR 8/15-9/30	8/15-10/15 OR 2/15-4/15	-	MIX WITH PERENNIAL LESPEDEZAS OR CROWN VETCH; NOT FOR DROUGHTY SOILS OR HEAVY USE AREAS.
LESPEDEZA, SERICEA SCARIFIED	60 LBS.	1.4 LBS.	4/1-5/31	3/15-5/31	3/1-5/15	WIDELY ADAPTED AND LOW MAINTENANCE; TAKES 2-3 YEARS TO ESTABLISH; SEED WITH EL INOCULANT; MIX WITH WEEPING LOVEGRASS, COMMON BERMUDA, BAHIA OR TALL FESCUE.
UNSCARIFIED SEED-BEARING HAY	75 LBS. 3 TONS.	1.7 LBS. 138 LBS.	9/1-2/28 10/1-2/1	9/1-2/28 10/1-2/28	9/1-2/28 9/15-1/15	MIX WITH TALL FESCUE OR WINTER ANNUALS. CUT WHEN SEED IS MATURE BUT BEFORE IT SHATTERS. ADD TALL FESCUE OR WINTER ANNUALS.
LESPEDEZA, AMBRO VIRGATA OR APPALOW SCARIFIED UNSCARIFIED	60 LBS. 75 LBS.	1.4 LBS. 1.7 LBS.	4/1-5/31 9/1-2/28	3/15-5/31 9/1-2/28	3/1-5/15 9/1-2/28	SPREADING GROWTH WITH HEIGHT OF 18"-24"; GOOD IN URBAN AREA; SLOW TO DEVELOP GOOD STANDS; MIX WITH WEEPING LOVEGRASS, COMMON BERMUDA, BAHIA TALL FESCUE OR WINTER ANNUALS; DO NOT MIX WITH SERICEA LESPEDEZA; INOCULATE SEED WITH EL INOCULANT.
LESPEDEZA, SHRUB (LESPEDEZA BICOLOR OR LESPEDEZA THUMBERGII) PLANTS	3"x3" SPACING		11/1-3/31	11/1-3/15	11/15-2/28	PLANT IN SMALL CLUMPS FOR WILDLIFE FOOD AND COVER.
LOVEGRASS, WEEPING ALONE WITH OTHER PERENNIALS	4 LBS. 2 LBS.	0.1 LB. 0.05 LB.	4/1-5/31	3/15-5/31	3/1-5/31	QUICK COVER; DROUGHT TOLERANT; GROWS WELL WITH SERICEA LESPEDEZA ON ROAD-BANKS AND OTHER STEEP SLOPES; SHORT LIVED.
MAIDENCANE SPRIGS	2"x3" SPACING		2/1-3/31	2/1-3/31	2/1-3/31	FOR VERY WET SITES SUCH AS RIVERBANKS AND SHORELINES. DIG SPRIGS LOCALLY.
PANICGRASS, ATLANTIC COASTAL	20 LBS.	0.5 LB.	-	3/1-4/30	3/1-4/30	GROWS WELL ON COASTAL SAND DUNES; MIX WITH SERICEA LESPEDEZA BUT NOT ON SAND DUNES.
REED CANARY GRASS ALONE WITH OTHER PERENNIALS	50 LBS. 30 LBS.	1.1 LBS. 0.7 LB.	8/15-10/15	9/1-10/15	-	GROW SIMILAR TO TALL FESCUE; FOR WET SITES.
SUNFLOWER, AZTEC MAXMILLIAN	10 LBS.	0.2 LB.	4/15-5/31	4/15-5/31	4/1-5/31	MIX WITH WEEPING LOVE-GRASS OR OTHER LOW GROWING GRASSES OR LEGUMES.
SWITCHGRASS	20 LBS.	0.4 LB.	4/1-5/31	4/1-5/31	4/1-5/31	FOR STREAMBANK PLANTINGS, DRAINAGE DITCHES, AND WET AREAS.

Ds2 DISTURBED AREA STABILIZATION (WITH TEMPORARY SEEDING)

TABLE 1

SUGGESTED SEEDBED DEPTHS	
SLOPE	SEEDBED DEPTH
3:1 OR FLATTER	LESS THAN 4" DEPTH
2:1 TO 3:1	1" TO 4" DEPTH
2:1 OR STEEPER	DEPRESSIONS EVERY 6" TO 8" HAND-DUG, IF NECESSARY

RE-SEED AREAS WHERE AN ADEQUATE STAND OF TEMPORARY VEGETATION FAILS TO EMERGE OR WHERE A POOR STAND EXISTS.

TABLE 2
SOME TEMPORARY PLANT SPECIES, SEEDING RATES AND PLANTING DATES

SPECIES	RATES PER 1,000 SQ. FT.	RATES PER ACRE	PLANTING DATES BY REGION		
			M-L	P	C
RYE (GRAIN)	3.9 LBS.	3 BU	8/15-11/19	9/15-12/1 3/1-4/1	10/1-11/1
RYEGRASS	0.9 LB.	40 LBS.	8/15-11/15	9/1-12/15	9/15-1/1
RYE AND ANNUAL LESPEDEZA	0.6 LB. 0.6 LB.	0.5 BU 24 LBS	3/1-4/1	3/1-4/1	2/1-3/1
WEEPING LOVEGRASS	0.1 LB.	4 LBS.	4/1-6/1	4/1-6/1	3/1-6/1
SUDANGRASS	1.0 LB.	60 LBS.	5/1-8/1	5/1-8/1	4/1-8/1
BROWNTOP MILLET	1.1 LBS.	50 LBS.	4/15-6/15	4/15-7/1	4/15-7/1
WHEAT	4.1 LBS.	3 BU	9/15-12/1	10/1-12/15	10/15-1/1

1. UNUSUAL SITE CONDITIONS MAY REQUIRE HEAVIER SEEDING RATES.
2. SEEDING DATES MAY NEED TO BE ALTERED TO FIT TEMPERATURE VARIATIONS AND LOCAL CONDITIONS.

TABLE 3
FERTILIZER REQUIREMENTS FOR TEMPORARY VEGETATION

TYPE OF SPECIES	PLANTING YEAR	FERTILIZER (N-P-K)	RATE (LBS./ACRE)	N TOP DRESSING RATE (LBS./ACRE)
COOL SEASON GRASSES	FIRST SECOND MAINTENANCE	6-12-12 6-12-12 10-10-10	1500 1000 400	50-100 --- 30
COOL SEASON GRASSES AND LEGUMES	FIRST SECOND MAINTENANCE	6-12-12 0-10-10 0-10-10	1500 1000 400	0-50 --- ---
TEMPORARY COVER CROPS SEEDED ALONE	FIRST	10-10-10	500	30
WARM SEASON GRASSES	FIRST SECOND MAINTENANCE	6-12-12 6-12-12 10-10-10	1500 800 400	50-100 50-100 30

TABLE 2

SUGGESTED SEEDBED DEPTHS	
SLOPE	SEEDBED DEPTH
3:1 OR FLATTER	1" TO 4" DEPTH
2:1 TO 3:1	4" DEPTH
2:1 OR STEEPER	DEPRESSIONS EVERY 6" TO 8" HAND-DUG, IF NECESSARY

TABLE 3
FERTILIZER REQUIREMENTS FOR PERMANENT VEGETATION

TYPES OF SPECIES	PLANTING YEAR	FERTILIZER (N-P-K)	RATE (LBS./ACRE)	N TOP DRESSING RATE (LBS./ACRE)
COOL SEASON GRASSES	FIRST SECOND MAINTENANCE	6-12-12 6-12-12 10-10-10	1500 1000 400	50-100 --- 30
COOL SEASON GRASSES AND LEGUMES	FIRST SECOND MAINTENANCE	6-12-12 0-10-10 0-10-10	1500 1000 400	0-50 --- ---
WARM SEASON GRASSES	FIRST SECOND MAINTENANCE	6-12-12 6-12-12 10-10-10	1500 800 400	50-100 50-100 30
WARM SEASON GRASSES AND LEGUMES	FIRST SECOND MAINTENANCE	6-12-12 0-10-10 0-10-10	1500 1000 400	50 --- ---

1. RATES ARE FOR BROADCASTED SEED. IF A SEED DRILL IS USED, REDUCE THE RATES BY ONE-HALF.
2. PLS IS AN ABBREVIATION OF PURE LIVE SEED.
3. CONTRACTOR SHALL USE M-L REGION FOR DETERMINATION OF SEED TYPES AND PLANTING DATES.

BID DOCUMENTS

Revisions	Date	PRIME:	MEP ENGINEER:		IRRIGATION DESIGNER:  2231 Weatherstone Circle Conyers, GA 30094 (770) 929-0884, fax (770) 760-8025	 NATIONAL CEMETERY ADMINISTRATION	Drawing Title	Project Title	Date
		EROSION & SEDIMENT CONTROL DETAILS	4000 NICHE COLUMBARIUM GEORGIA NATIONAL CEMETERY				23 OCTOBER 2015		
		Approved: Director, Technical Support Service	Building Number				Checked	Drawn	Project No. 922CM3005
		Approved: Chief, Architectual & Engineering Division	Location 1080 VETERANS CEMETERY RD, CANTON, GA 30114				DRAWING NO. C-507 Sheet 22 of 31		

- NOTES:
1. AVOID LOCATING ON STEEP SLOPES OR AT CURVES ON PUBLIC ROADS.
2. REMOVE ALL VEGETATION AND OTHER UNSUITABLE MATERIAL FROM THE FOUNDATION AREA, GRADE, AND CROWN FOR POSITIVE DRAINAGE.
3. AGGREGATE SIZE SHALL BE IN ACCORDANCE WITH NATIONAL STONE ASSOCIATION R-2 (1.5"-3.5" STONE).
4. GRAVEL PAD SHALL HAVE A MINIMUM THICKNESS OF 6".
5. PAD WIDTH SHALL BE EQUAL FULL WIDTH AT ALL POINTS OF VEHICULAR EGRESS, BUT NO LESS THAN 20'.
6. A DIVERSION SHOULD BE CONSTRUCTED WHERE GRADE TOWARD PAVED AREA IS GREATER THAN 2%.
7. INSTALL PIPE UNDER THE ENTRANCE IF NEEDED TO MAINTAIN DRAINAGE DITCHES.
8. WHEN WASHING IS REQUIRED, IT SHOULD BE DONE ON AN AREA STABILIZED WITH CRUSHED STONE THAT DRAINS INTO AN APPROVED SEDIMENT TRAP OR SEDIMENT BASIN (DIVERT ALL SURFACE RUNOFF AND DRAINAGE FROM THE ENTRANCE TO A SEDIMENT CONTROL DEVICE).
9. WHEN WASHCK, AND/OR WASH TRUCKS MAY BE REQUIRED DEPENDING ON SCALE AND CIRCUMSTANCE. IF NECESSARY, WASHCK DRAINAGE MAY CONSIST OF A MATERIAL SUITABLE FOR TRUCK TRAFFIC THAT REMOVE MUD AND DIRT.
10. MAINTAIN AREA IN A WAY THAT PREVENTS TRIPPING AND/OR FLOW OF MUD ONTO PUBLIC RIGHTS-OF-WAYS. THIS MAY REQUIRE TOP DRESSING, REPAIR AND/OR CLEANOUT OF ANY MEASURES USED TO TRAP SEDIMENT.

FIGURE 6-17.2

NOTES:

1. USE STEEL OR WOOD POSTS OR AS SPECIFIED BY THE EROSION, SEDIMENTATION, AND POLLUTION CONTROL PLAN.
2. HEIGHT (*) IS TO BE SHOWN ON THE EROSION, SEDIMENTATION, AND POLLUTION CONTROL PLAN.

NOTES:

1. THE FABRIC AND WIRE SHOULD BE SECURELY FASTENED TO POSTS AND FABRIC ENDS MUST BE OVERLAPPED A MINIMUM OF 18" OR WRAPPED TOGETHER AROUND A POST TO PROVIDE A CONTINUOUS FABRIC BARRIER AROUND THE INLET.

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NOTES:

1. INSTALL FILTER AFTER ANY ASPHALT PAVEMENT INSTALLATION.
2. WRAP 8" CONCRETE BLOCKS IN FILTER FABRIC AND SPAN ACROSS CATCH BASIN INLET.
3. FACE OPENINGS IN BLOCKS OUTWARD.
4. LEAVE A GAP OF APPROXIMATELY 4 INCHES BETWEEN THE CURB AND THE FILTERS TO ALLOW FOR OVERFLOW TO PREVENT HAZARDOUS PONDING.
5. INSTALL OUTLET PROTECTION BELOW STORM DRAIN OUTLETS.

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<div>Revisions</div> <div>Date</div>	<div><div></div><div>PRIME:</div><div>AMEC FOSTER WHEELER ENVIRONMENT & INFRASTRUCTURE 1075 BIG SHANTY ROAD NW, SUITE 100 KENNESAW, GA. 30144 (770) 421-3400 AMEC PROJECT: 6166-15-0011</div></div>	<div>MEP ENGINEER:</div>	<div></div>	<div>IRRIGATION DESIGNER:</div> <div><div>Irrigation Consultant Services</div><div>2231 Weatherstone Circle Conyers, GA 30094 (770) 929-0884, fax (770) 760-8025</div></div>	<div><div>NATIONAL CEMETERY ADMINISTRATION</div></div>	<div>Drawing Title</div> <div>EROSION & SEDIMENT CONTROL DETAILS</div> <div>Approved: Director, Technical Support Service</div> <div>Approved: Chief, Architectual & Engineering Division</div>	<div>Project Title</div> <div>4000 NICHE COLUMBARIUM GEORGIA NATIONAL CEMETERY</div> <div>Building Number</div> <div>Checked</div> <div>Drawn</div> <div>Location</div> <div>1080 VETERANS CEMETERY RD, CANTON, GA 30114</div>	<div>Date</div> <div>23 OCTOBER 2015</div> <div>Project No.</div> <div>922CM3005</div> <div>DRAWING NO.</div> <div>C-508</div> <div>Sheet</div> <div>23</div> <div>Of</div> <div>31</div>
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EROSION, SEDIMENTATION, AND POLLUTION CONTROL PLAN
(ESPC Plan)

THIS PLAN WAS PREPARED AS REQUIRED BY NPDES GENERAL PERMIT NO. GAR 100001. THESE PLAN SHEETS AND ALL REQUIREMENTS OF THE GENERAL PERMIT AS WELL AS LOCAL, STATE, AND FEDERAL REGULATIONS OR LAWS APPLY REGARDLESS OF SPECIFIC INCLUSION IN THIS PLAN.

OWNER/DEVELOPER: DEPARTMENT OF VETERANS AFFAIRS
GEORGIA NATIONAL CEMETERY
1080 VETERANS CEMETERY ROAD
CANTON, GEORGIA 30114

SITE DESCRIPTION

OWNER/DEVELOPER AS PRIMARY PERMITEE WILL OVERSEE SITE CONSTRUCTION LOCATED WITHIN THE PROPERTY SITUATED IN LAND LOTS 55 AND 56 OF THE 22nd DISTRICT OF CHEROKEE COUNTY, GEORGIA. THE CONSTRUCTION SITE AREA IS LOCATED WITHIN THE GEORGIA NATIONAL CEMETERY, CANTON, GEORGIA. THE ENTIRE SITE AREA IS APPROXIMATELY 775 ACRES AND THE DISTURBED AREA: 1.36 ACRES.

THE PROPOSED USE FOR THIS DEVELOPMENT IS FOR A 4000-NICHE COLUMBARIUM, DRIVEWAYS, ASSOCIATED LANDSCAPE AND STORMWATER MANAGEMENT STRUCTURES.

CONSTRUCTION WILL BEGIN WITH PLACEMENT OF PERIMETER SILT PROTECTION BARRIERS, AND CONSTRUCTION ENTRANCES. AFTER THE INITIAL EROSION CONTROL PLAN, CONTRACTOR SHALL INSTALLMENT AND TEMPORARY SEDIMENT TRAP ARE CONSTRUCTED AS SHOWN ON THE INITIAL PHASE EROSION CONTROL PLAN.

GENERAL NOTES

1. NO CONSTRUCTION ACTIVITIES SHALL BE CONDUCTED WITHIN THE 25-FOOT OR 50-FOOT UNDISTURBED STREAM BUFFER AS MEASURED HORIZONTALLY FROM THE POINT OF WRESTED VEGETATION ALONG THE BANKS OF ALL STATE WATERS WITHOUT FIRST ACQUIRING THE NECESSARY VARIANCES AND PERMITS.
2. ANY AMENDMENT/REVISION TO THE EROSION, SEDIMENTATION AND POLLUTION CONTROL PLAN WHICH HAS A SIGNIFICANT EFFECT ON BMP'S WITH A HYDRAULIC COMPONENT MUST BE CERTIFIED BY THE DESIGN PROFESSIONAL.
3. AFTER CONSTRUCTION, EROSION AND SEDIMENTATION SHALL BE MANAGED BY INSTALLATION OF PERMANENT VEGETATION, ROADS, PARKING LOTS, ASPHALT PAVING AND OTHER PERMANENT SITE FEATURES.
4. MINIMIZING WIND EROSION AND CONTROLLING DUST SHALL BE ACCOMPLISHED BY ONE OR MORE OF THE FOLLOWING METHODS:
 - A. COVERING 30% OR MORE OF THE SOIL SURFACE WITH NON-ERODIBLE MATERIAL.
 - B. ROUGHENING THE SOIL TO PRODUCE RIDGES PERPENDICULAR TO THE PREVAILING WIND.
 - C. FREQUENT WATERING OF EXCAVATION AND FILL AREAS.
 - D. PROVIDING GRAVEL OR PAVING AT EXIT DRIVES.
5. TEMPORARY SEDIMENT TRAP SHALL BE CONSTRUCTED TO ACCOMMODATE 67 CUBIC YARDS OF STORAGE PER ACRE DRAINED.
6. PRIOR TO THE LAND DISTURBING CONSTRUCTION, THE CONTRACTOR SHALL SCHEDULE A PRE-CONSTRUCTION MEETING WITH THE AREA SITE DEVELOPMENT INSPECTOR.
7. THE CONTRACTOR SHALL OBSERVE THE PROJECT SEQUENCE SHOWN ON THE PLAN. THE CONTRACTOR SHALL MAINTAIN CAREFUL SCHEDULING AND PERFORMANCE TO INSURE THAT LAND STRIPPED OF ITS NATURAL COVER IS EXPOSED ONLY IN SMALL QUANTITIES.
8. THE OWNER AGREES TO PROVIDE AND MAINTAIN OFF-STREET PARKING ON THE SUBJECT PROPERTY DURING THE ENTIRE CONSTRUCTION PERIOD.
9. NO STAGING AREAS, MATERIAL STORAGE, CONCRETE WASH OUT AREAS, OR DEBRIS BURN AND BURIAL HOLES SHALL BE LOCATED WITHIN 500 FEET OF DESIGNATED TREE PROTECTION AREAS.
10. A COPY OF THE APPROVED LAND DISTURBANCE PLAN, APPROVED EROSION, SEDIMENTATION AND POLLUTION PLAN, AND NPDES GENERAL PERMIT NO. GAR 100001 SHALL BE PRESENT ON THE SITE AT ALL TIMES.
11. WASTE MATERIALS SHALL NOT BE DISCHARGED TO WATERS OF THE STATE, EXCEPT AS AUTHORIZED BY A SECTION 404 PERMIT.
12. THE DESIGN PROFESSIONAL MAY PERFORM PERIODIC AUDITS OF THE CONTRACTOR'S EROSION CONTROL RECORDS. HOWEVER, REGARDLESS OF WHETHER THESE AUDITS ARE PERFORMED, THE CONTRACTOR SHALL REMAIN RESPONSIBLE FOR THE PROPER MAINTENANCE OF THESE RECORDS AND REPORTING OF RESULTS AS REQUIRED BY THE NPDES PERMIT.
13. THE ESCAPE OF SEDIMENT FROM THE SITE SHALL BE PREVENTED BY THE INSTALLATION OF EROSION AND SEDIMENT CONTROL MEASURES AND PRACTICES PRIOR TO, OR CONCURRENT WITH, LAND-DISTURBING ACTIVITIES.
14. EROSION CONTROL MEASURES WILL BE MAINTAINED AT ALL TIMES. IF FULL IMPLEMENTATION OF THE APPROVED PLAN DOES NOT PROVIDE FOR EFFECTIVE EROSION CONTROL, ADDITIONAL EROSION AND SEDIMENT CONTROL MEASURES SHALL BE IMPLEMENTED TO CONTROL OR TREAT THE SEDIMENT SOURCE.
15. ANY DISTURBED AREA LEFT EXPOSED FOR A PERIOD GREATER THAN 14 DAYS SHALL BE STABILIZED WITH MULCH OR TEMPORARY SEEDING.

INITIAL PHASE EROSION CONTROL NOTES:

PRIOR TO COMMENCING LAND DISTURBANCE ACTIVITY, THE LIMITS OF LAND DISTURBANCE SHALL BE CLEARLY AND ACCURATELY DEMARKED WITH STAKES, RIBBONS, OR OTHER APPROPRIATE MEANS. THE LOCATION AND EXTENT OF ALL AUTHORIZED LAND DISTURBANCE ACTIVITY SHALL BE DEMARCATED FOR THE DURATION OF THE CONSTRUCTION ACTIVITY. NO LAND DISTURBANCE SHALL OCCUR OUTSIDE THE APPROVED LIMITS INDICATED ON THE APPROVED PLAN.

PRIOR TO ANY OTHER CONSTRUCTION, A STABILIZED CONSTRUCTION EXIT SHALL BE CONSTRUCTED AT EACH POINT OF ENTRY TO OR EXIT FROM THE SITE OR ONTO ANY PUBLIC ROADWAY.

THE FOLLOWING INITIAL EROSION CONTROL MEASURES SHALL BE IMPLEMENTED PRIOR TO ANY OTHER CONSTRUCTION ACTIVITY.

1. THE CONSTRUCTION EXIT, CONSISTING OF A MINIMUM PAD SIZE OF 20 FEET BY 50 FEET WITH A MINIMUM OF 6" THICK STONE, SHALL BE PLACED AS SHOWN ON THE PLAN. THE STONE SIZE SHALL CONSIST OF COURSE AGGREGATE BETWEEN 1-1/2" AND 3-1/2" IN DIAMETER AND OVERLAP ON A GEOTEXTILE UNDERLIER. THE GEOTEXTILE UNDERLIER SHALL MEET THE REQUIREMENTS OF ASHTO M288, SEPARATION REQUIREMENTS.
2. IMMEDIATELY AFTER THE ESTABLISHMENT OF CONSTRUCTION EXITS, ALL PERIMETER EROSION CONTROL AND STORM WATER MANAGEMENT DEVICES SHALL BE INSTALLED AS SHOWN ON THE INITIAL PHASE EROSION CONTROL PLAN. CONTRACTOR SHALL CONSTRUCT A TEMPORARY SEDIMENT TRAP AS SHOWN ON THE INITIAL PHASE EROSION CONTROL PLAN TO CONTROL EROSION AND STORM WATER RUNOFF.
3. "SENSITIVE" SILT FENCE SHALL BE INSTALLED AT THE PERIMETER OF THE DISTURBED AREA AS SHOWN ON THE PLAN. THE SILT FENCE SHALL BE PLACED IN ACCORDANCE WITH THE MANUAL FOR EROSION CONTROL IN GEORGIA, TABLE 6-20.2, CRITERIA FOR SILT FENCE PLACEMENT. THE SILT FENCE SHALL BE KEPT ERECT AT ALL TIMES AND REPAIRED WHEN REQUESTED BY THE SITE INSPECTOR OR THE DESIGN PROFESSIONAL. RECORD, SILT SHALL BE REMOVED WHEN ACCUMULATION REACHES 1/2 HEIGHT OF THE BARRIER. THE PERIMETER SILT FENCE SHALL BE INSPECTED DAILY FOR ANY FAILURES. ANY FAILURES OF SAID FENCING SHALL BE REPAIRED IMMEDIATELY.
4. TREE PROTECTION FENCING SHALL BE INSTALLED PRIOR TO THE START OF ANY LAND DISTURBANCE ACTIVITY AND MAINTAINED UNTIL FINAL LANDSCAPING IS INSTALLED. THE TREE PROTECTION FENCING SHALL BE INSPECTED DAILY. ANY FAILURE OF SAID FENCING SHALL BE REPAIRED IMMEDIATELY.

THE PRIMARY PERMITEE MUST RETAIN THE DESIGN PROFESSIONAL WHO PREPARED THE PLANS, EXCEPT WHEN THE PRIMARY PERMITEE HAS REQUESTED IN WRITING AND EPD HAS AGREED TO AN ALTERNATIVE DESIGN PROFESSIONAL, TO INSPECT THE INSTALLATION OF THE INITIAL SEDIMENT STORAGE REQUIREMENTS AND PERIMETER CONTROL BMPs WHICH THE DESIGN PROFESSIONAL DESIGNED WITHIN SEVEN (7) DAYS AFTER INSTALLATION. THE DESIGN PROFESSIONAL SHALL DETERMINE IF THESE BMPs HAVE BEEN INSTALLED AND ARE BEING MAINTAINED AS DESIGNED. THE DESIGN PROFESSIONAL SHALL REPORT THE RESULTS OF THE INSPECTION TO THE PRIMARY PERMITEE WITHIN SEVEN (7) DAYS AND THE PERMITEE MUST CORRECT ALL DEFICIENCIES WITHIN TWO (2) BUSINESS DAYS OF RECEIPT OF THE INSPECTION REPORT FROM THE DESIGN PROFESSIONAL UNLESS WEATHER RELATED SITE CONDITIONS ARE SUCH THAT ADDITIONAL TIME IS REQUIRED.

AFTER APPROVAL OF THE INITIAL EROSION CONTROL INSTALLATION THE CONTRACTOR MAY PROCEED WITH CLEARING AND GRUBBING ACTIVITIES.

THE CONTRACTOR CAN UTILIZE CLEARING TREES AS BARRIER BRUSH SEDIMENT CONTROL IN AREAS SHOWN ON THE PLAN WHERE INITIAL GRADING ACTIVITIES WILL NOT OCCUR.

TOPSOIL SHALL BE STRIPPED FROM ALL CUT AND FILL AREAS AND STOCKPILED FOR LATER REUSE ON FINAL GRADE SOIL/SLOPE SURFACES.

NO BURN OR BURY PIT SHALL BE PERMITTED ON THE CONSTRUCTION SITE WITHOUT WRITTEN PERMISSION BY THE OWNER AND/OR THE DESIGN PROFESSIONAL.

ADDITIONAL SILT BARRIERS MUST BE PLACED AS SHOWN ON THE PLAN AS ACCESS IS OBTAINED DURING CLEARING. NO GRADING SHALL TAKE PLACE UNTIL SILT BARRIER INSTALLATION AND TEMPORARY SEDIMENT TRAP ARE CONSTRUCTED AS SHOWN ON THE INITIAL PHASE EROSION CONTROL PLAN.

ALL SILT FENCE SHALL MEET THE REQUIREMENTS OF SECTION 171 OF THE "DEPARTMENT OF TRANSPORTATION, STATE OF GEORGIA. STANDARD SPECIFICATIONS, CONSTRUCTION OF TRANSPORTATION SYSTEMS", (GDOT STANDARD SPECIFICATIONS), LATEST EDITION.

ALL ITEMS IN THESE NOTES SHALL MEET THE REQUIREMENTS AS SET FORTH IN SECTIONS 161, 162, 163, AND 164 OF THE GDOT STANDARD SPECIFICATIONS UNLESS OTHERWISE SPECIFIED IN THE PROJECT DOCUMENTS.

TEMPORARY SEEDING AND/OR MULCH SHALL BE APPLIED TO ALL EXPOSED AREAS WITHIN 14 DAYS OF LAND DISTURBANCE.

ALL DISTURBED AREAS LEFT MULCHED AFTER 30 DAYS SHALL BE STABILIZED WITH TEMPORARY VEGETATION.

SEDIMENT AND EROSION CONTROL MEASURES SHALL BE CHECKED AFTER EACH RAIN EVENT. EACH DEVICE SHALL BE MAINTAINED OR REPLACED IF SEDIMENT ACCUMULATION HAS REACHED ONE HALF THE CAPACITY OF THE DEVICE. ADDITIONAL DEVICES SHALL BE INSTALLED IF NEW CHANNELS HAVE DEVELOPED.

THE CONSTRUCTION EXIT SHALL BE MAINTAINED IN A CONDITION WHICH WILL PREVENT TRACKING OR FLOWING OF MUD ONTO PUBLIC RIGHTS-OF-WAY. THIS MAY REQUIRE PERIODIC TOP DRESSING WITH A 1" TO 3" LAYER OF STONE, AS CONDITIONS DEMAND. ALL MATERIALS SPILLED, DROPPED, WASHED, OR TRACKED FROM VEHICLES ONTO PUBLIC ROADWAYS OR INTO STORM DRAINS SHALL BE REMOVED IMMEDIATELY.

CONTRACTOR SHALL INSPECT CONTROL MEASURES AT THE END OF EACH WORKING DAY TO ENSURE MEASURES ARE FUNCTIONING PROPERLY.

EROSION CONTROL MEASURES SHALL BE MAINTAINED AT ALL TIMES. IF FULL IMPLEMENTATION OF THE APPROVED PLAN DOES NOT PROVIDE FOR EFFECTIVE EROSION CONTROL AS A PART OF THE SCOPE OF THE PROJECT, ADDITIONAL EROSION AND SEDIMENT CONTROL MEASURES SHALL BE IMPLEMENTED TO CONTROL OR TREAT THE SEDIMENT SOURCE.

FAILURE TO INSTALL, OPERATE, OR MAINTAIN ALL EROSION CONTROL MEASURES WILL RESULT IN ALL CONSTRUCTION BEING STOPPED ON THE JOB UNTIL SUCH MEASURES ARE CORRECTED BACK TO THE APPROVED EROSION CONTROL PLAN.

THE SITE CONTRACTOR SHALL BE RESPONSIBLE FOR MAINTENANCE OF ALL EROSION CONTROL MEASURES INCLUDING REPLACING OR REPAIRING ANY DAMAGED DEVICES DUE TO ANY CONSTRUCTION ACTIVITY BY OTHERS.

INTERMEDIATE PHASE EROSION CONTROL NOTES:

THE FOLLOWING EROSION CONTROL MEASURES SHALL BE IMPLEMENTED DURING THE GRADING PHASE OF CONSTRUCTION.

DURING CONSTRUCTION, THE CONTRACTOR SHALL MAINTAIN CAREFUL SCHEDULING AND PERFORMANCE TO ENSURE THAT LAND STRIPPED OF ITS NATURAL GROUND COVER IS EXPOSED ONLY IN SMALL QUANTITIES AND LIMITED DURATIONS, BEFORE PERMANENT EROSION PROTECTION IS ESTABLISHED.

SEDIMENT SHALL NOT BE WASHED INTO INLETS. IT SHALL BE REMOVED FROM THE SEDIMENT TRAPS AND DISPOSED OF AND STABILIZED SO THAT IT WILL NOT ENTER THE INLET AGAIN.

EROSION CONTROL DEVICES SHALL BE INSTALLED IMMEDIATELY AFTER GROUND DISTURBANCE OCCURS. THE LOCATION OF SOME OF THE EROSION CONTROL DEVICES MAY HAVE TO BE ALTERED FROM THAT SHOWN ON THE APPROVED PLAN IF DRAINAGE PATTERNS DURING CONSTRUCTION ARE DIFFERENT FROM THE PROPOSED DRAINAGE PATTERNS. AS A PART OF THIS PROJECT, IT IS THE CONTRACTOR'S RESPONSIBILITY TO ACCOMPLISH EROSION CONTROL FOR ALL DRAINAGE PATTERNS CREATED AT VARIOUS STAGES DURING CONSTRUCTION, ANY DIFFICULTY IN CONTROLLING EROSION DURING ANY PHASE OF CONSTRUCTION SHALL IMMEDIATELY BE REPORTED TO THE DESIGN PROFESSIONAL WHO PREPARED THIS PLAN WHO WILL ASSIST THE CONTRACTOR TO ADDRESS THE IDENTIFIED DIFFICULTIES.

THE CONTRACTOR SHALL FURNISH AND MAINTAIN ALL NECESSARY BARRICADES WHILE ROADWAY FRONTAGE IMPROVEMENTS ARE BEING MADE.

"SENSITIVE" TYPE SILT FENCE SHALL BE INSTALLED AT THE TOE OF ALL FILL SLOPES 10 FEET OR GREATER IN HEIGHT. THE SILT FENCE SHALL BE PLACED IN ACCORDANCE WITH THE MANUAL FOR EROSION CONTROL IN GEORGIA, TABLE 6-20.2, CRITERIA FOR SILT FENCE PLACEMENT. THE SILT FENCE SHALL BE MAINTAINED UNTIL PERMANENT GROUND COVER IS ESTABLISHED ON THE SLOPE. SILT SHALL BE REMOVED WHEN ACCUMULATION REACHES 1/2 HEIGHT OF THE BARRIER.

THE CONTRACTOR SHALL BE RESPONSIBLE FOR ESTABLISHING BARRIERS AT THE TOE OF THE SLOPES UNDER CONSTRUCTION. THESE BARRIERS SHALL BE AS SHOWN IN THE PLAN. THE BARRIERS MAY BE RELOCATED AND REUSED AFTER PERMANENT SLOPE STABILIZATION BECOMES FULLY ESTABLISHED. AS THEY ARE RELOCATED ANY DEFECTIVE MATERIALS IN THE BARRIER SHALL BE REPLACED. IN ADDITION ALL DEBRIS AND SILT AT THE PREVIOUS LOCATION SHALL BE REMOVED.

CUT AND FILL SLOPES ARE NOT TO EXCEED 2:1. EROSION CONTROL MATTING SHALL BE INSTALLED ON ALL SLOPES THAT EXCEED 2.5(H):1(V) AND ARE TEN FEET OR GREATER IN HEIGHT.

TWO ROWS OF "SENSITIVE" TYPE SILT FENCE SHALL BE PLACED AT THE TOE OF ALL DIRT STOCK PILE AREAS. SEE DETAILS FOR ADDITIONAL INFORMATION.

INLET SEDIMENT PROTECTION MEASURES SHALL BE INSTALLED ON ALL STORM STRUCTURES AS THEY ARE CONSTRUCTED. SEE PLAN VIEW FOR SPECIFIC TYPE AND DETAILS FOR ADDITIONAL INFORMATION ON TYPE OF INLET PROTECTION SPECIFIED.

MULCH OR TEMPORARY SEEDING SHALL BE APPLIED TO ALL EXPOSED AREAS WITHIN 14 DAYS OF LAND DISTURBANCE. THIS SHALL BE PERFORMED EVEN IF ADDITIONAL GRADING IS PLANNED IN THESE AREAS AT A LATER STAGE OF THE PROJECT.

ALL DISTURBED AREAS LEFT MULCHED AFTER 30 DAYS SHALL BE STABILIZED WITH TEMPORARY SEEDING.

CONTRACTOR SHALL MAINTAIN THE SEDIMENT TRAP(S) UNTIL PERMANENT GROUND COVER IS ESTABLISHED. SEDIMENT SHALL BE CLEANED OUT OF THE TRAP(S) WHEN IT REACHES THE ONE THIRD DEPTH OF EACH TRAP. SILT DEPTH GAUGES SHALL BE ESTABLISHED TO PROVIDE A VISUAL INDICATION OR WHEN SILT IS TO BE REMOVED FROM EACH TRAP. SEE SEPARATE DETAILS FOR ADDITIONAL INFORMATION.

SEDIMENT AND EROSION CONTROL MEASURES SHALL BE CHECKED AFTER EACH RAIN EVENT. EACH DEVICE IS TO BE MAINTAINED OR REPLACED IF SEDIMENT ACCUMULATION HAS REACHED ONE HALF THE CAPACITY OF THE DEVICE. ADDITIONAL DEVICES MUST BE INSTALLED IF NEW CHANNELS HAVE DEVELOPED.

THE CONSTRUCTION EXIT SHALL BE MAINTAINED IN A CONDITION WHICH WILL PREVENT TRACKING OR FLOWING OF MUD ONTO PUBLIC RIGHTS-OF-WAY. THIS MAY REQUIRE PERIODIC TOP DRESSING WITH A 1" TO 3" LAYER OF STONE, AS CONDITIONS DEMAND. ALL MATERIALS SPILLED, DROPPED, WASHED, OR TRACKED FROM VEHICLES ONTO PUBLIC ROADWAYS OR INTO STORM DRAINS SHALL BE REMOVED IMMEDIATELY.

CONTRACTOR SHALL INSPECT CONTROL MEASURES AT THE END OF EACH WORKING DAY TO ENSURE MEASURES ARE FUNCTIONING PROPERLY.

FAILURE TO INSTALL, OPERATE, OR MAINTAIN ALL EROSION CONTROL MEASURES WILL RESULT IN ALL CONSTRUCTION BEING STOPPED ON THE JOB UNTIL SUCH MEASURES ARE CORRECTED BACK TO THE APPROVED EROSION CONTROL PLAN.

THE SITE CONTRACTOR SHALL BE RESPONSIBLE FOR MAINTENANCE OF ALL EROSION CONTROL MEASURES INCLUDING REPLACING OR REPAIRING ANY DAMAGED DEVICES DUE TO ANY CONSTRUCTION ACTIVITY BY OTHERS.

FINAL PHASE EROSION CONTROL NOTES:

THE FOLLOWING EROSION CONTROL MEASURES SHALL BE IMPLEMENTED DURING THE FINAL EROSION CONTROL PHASE OF CONSTRUCTION.

SEDIMENT SHALL NOT BE WASHED INTO INLETS. IT SHALL BE REMOVED FROM THE SEDIMENT TRAPS AND DISPOSED OF AND STABILIZED SO THAT IT WILL NOT ENTER THE INLETS AGAIN.

MULCH OR TEMPORARY SEEDING SHALL BE APPLIED TO ALL EXPOSED AREAS WITHIN 14 DAYS OF LAND DISTURBANCE.

ALL DISTURBED AREAS LEFT MULCHED AFTER 30 DAYS SHALL BE STABILIZED WITH TEMPORARY GRASSING.

THE CONTRACTOR SHALL MAINTAIN ALL TEMPORARY SEDIMENT TRAPS AND EROSION CONTROL MEASURES UNTIL PERMANENT GROUND COVER IS ESTABLISHED. SEDIMENT SHALL BE CLEANED OUT OF THE TRAPS WHEN IT REACHES THE CLEANOUT LEVEL AS INDICATED BY THE SILT DEPTH GAUGES.

STOCKPILED TOPSOIL SHALL BE APPLIED AT A MINIMUM THICKNESS OF 3 INCHES TO ALL FINAL GRADE SOIL SURFACES. IF SUFFICIENT TOPSOIL IS NOT AVAILABLE TO COVER ALL FINAL GRADE SURFACES, PREFERENCE SHALL BE GIVEN TO CUT AND FILL SLOPE AREAS.

AFTER CURBING, GRADED AGGREGATE BASE, AND PAVEMENT HAS BEEN INSTALLED, ALL INLET SEDIMENT TRAPS ON CATCH BASINS ALONG WITH ANY CURB INLETS SHALL BE REMOVED AND REPLACED WITH CURB FILTER INLET PROTECTION. SEE DETAILS FOR ADDITIONAL INFORMATION.

PERMANENT VEGETATION SHALL BE ESTABLISHED ON ALL ROADWAY AND PARKING SHOULDERS AS FINAL GRADE IS ACHIEVED BEHIND CURBS.

SEDIMENT AND EROSION CONTROL MEASURES SHALL BE CHECKED AFTER EACH RAIN EVENT. EACH DEVICE IS TO BE MAINTAINED OR REPLACED IF SEDIMENT ACCUMULATION HAS REACHED ONE HALF THE CAPACITY OF THE DEVICE. ADDITIONAL DEVICES SHALL BE INSTALLED IF NEW CHANNELS HAVE DEVELOPED.

THE CONSTRUCTION EXIT SHALL BE MAINTAINED IN A CONDITION WHICH WILL PREVENT TRACKING OR FLOWING OF MUD ONTO PUBLIC RIGHT-OF-WAY UNTIL REPLACED WITH PERMANENT PAVING. THIS MAY REQUIRE PERIODIC TOP DRESSING WITH A 1" TO 3" LAYER OF STONE, AS CONDITIONS DEMAND. ALL MATERIALS SPILLED, DROPPED, WASHED, OR TRACKED FROM VEHICLES ONTO PUBLIC ROADWAYS OR INTO STORM DRAINS MUST BE REMOVED IMMEDIATELY.

CONTRACTOR SHALL INSPECT CONTROL MEASURES AT THE END OF EACH WORKING DAY TO ENSURE MEASURES ARE FUNCTIONING PROPERLY.

EROSION CONTROL MEASURES SHALL BE MAINTAINED AT ALL TIMES. IF FULL IMPLEMENTATION OF THE APPROVED PLAN DOES NOT PROVIDE FOR EFFECTIVE EROSION CONTROL AS A PART OF THE SCOPE OF THIS PROJECT, ADDITIONAL EROSION AND SEDIMENT CONTROL MEASURES SHALL BE IMPLEMENTED TO CONTROL OR TREAT THE SEDIMENT SOURCE AS DIRECTED BY THE ON SITE INSPECTOR OR THE DESIGN PROFESSIONAL.

FAILURE TO INSTALL, OPERATE, OR MAINTAIN ALL EROSION CONTROL MEASURES WILL RESULT IN ALL CONSTRUCTION BEING STOPPED ON THE JOB UNTIL SUCH MEASURES ARE CORRECTED BACK TO THE APPROVED EROSION CONTROL PLAN.

THE SITE CONTRACTOR SHALL BE RESPONSIBLE FOR MAINTENANCE OF ALL EROSION CONTROL MEASURES INCLUDING REPLACING OR REPAIRING ANY DAMAGED DEVICES DUE TO ANY CONSTRUCTION ACTIVITY BY OTHERS.

WHEN THE ENTIRE SITE HAS UNDERGONE FINAL STABILIZATION AND ALL STORMWATER DISCHARGES ASSOCIATED WITH CONSTRUCTION ACTIVITY THAT ARE AUTHORIZED BY THIS PERMIT HAVE CEASED, CONTRACTOR SHALL SUBMIT A NOTICE ON TERMINATION (NOT).

UPON COMPLETION OF THE CONSTRUCTION ACTIVITIES AND FINAL STABILIZATION, THE CONTRACTOR SHALL REMOVE ALL TEMPORARY EROSION BMP'S UPON APPROVAL OF THE NOTICE OF TERMINATION (N.O.T.) AND DISPOSE OF THEM UNLESS NOTED ON PLAN.

CRITICAL WORK ZONE EROSION CONTROL NOTES:

SHADED AREAS SHOWN ON THE INTERMEDIATE PHASE EROSION CONTROL PLAN REPRESENT CRITICAL WORK ZONES. AT THE END OF EACH WORK DAY ALL TEMPORARY SLOPES 3H:1V OR STEEPER AND HIGHER THAN 5 FEET SHALL RECEIVE SURFACE ROUGHENING WHEN INCLEMENT WEATHER IS FORECAST FOR THE PERIOD BEFORE WORK WILL RESUME.

SURVEY INFORMATION

TOPOGRAPHIC INFORMATION BASED ON A SURVEY PERFORMED BY AMEC AND SUPPLEMENTED WITH GIS CONTOURS FROM CHEROKEE COUNTY GIS.

FLOOD INSURANCE RATE MAP, COMMUNITY NUMBER 13057C02270, DATED SEPTEMBER 29, 2006, SHOWS NO PORTION OF THE SITE AND THE SURROUNDING AREA TO BE IN FLOOD ZONE AREA. THE SITE PROJECT LIMITS SHOWN IN THESE PLANS ARE OUTSIDE OF THE FLOOD ZONE.

RUNOFF COEFFICIENT

- WEIGHTED PRE CONSTRUCTION ON CURVE NUMBER: 55
- WEIGHTED POST CONSTRUCTION ON CURVE NUMBER: 71

SEE HYDROLOGY CALCULATIONS REPORT 4000-NICHE COLUMBARIUM GEORGIA NATIONAL CEMETERY PREPARED BY AMEC ENVIRONMENT & INFRASTRUCTURE, INC., DATED MAY 2015 FOR ADDITIONAL INFORMATION.

SOIL TYPES

THE NCORS SOIL TYPES AREA H1E AND TdF

SOIL DISTURBING ACTIVITIES INCLUDE:

- INSTALLING A STABILIZED CONSTRUCTION EXIT, PERIMETER SILT FENCE, SEDIMENT TRAP AND OTHER EROSION AND SEDIMENT CONTROLS
- CLEARING AND GRUBBING
- EXCAVATION FOR UTILITIES AND GRADING
- ROADWAY CONSTRUCTION
- COLUMBARIUM CONSTRUCTION
- SITE STABILIZATION
- PREPARATION FOR FINAL PLANTING AND SEEDING
- COMPLETING OF ON-SITE STABILIZATION

SEQUENCE OF MAJOR ACTIVITIES

SEE CONSTRUCTION SCHEDULE

NAME OF RECEIVING WATERS

A TRIBUTARY OF SHOALS CREEK

EROSION AND SEDIMENT CONTROLS

ALL PERIMETER SILT FENCES AND CONSTRUCTION EXITS SHALL BE IN PLACE PRIOR TO ANY LAND DISTURBING ACTIVITIES.

EXISTING VEGETATION SHALL BE LEFT IN PLACE UNTIL SUCH TIME THAT LAND DISTURBING ACTIVITIES ARE TO TAKE PLACE UPON THAT PORTION OF THE SITE. WHEN CONSTRUCTION ACTIVITIES HAVE CEASED IN AN AREA, THAT AREA SHALL BE STABILIZED WITHIN 14 DAYS. IF THE AREA IS NOT YET TO FINAL GRADE, IT SHALL BE MULCHED. IF THE AREA IS TO FINAL GRADE AND WILL EVENTUALLY CONTAIN SITE IMPROVEMENTS SUCH AS THE STRUCTURES OR SIDEWALKS, IT SHALL BE TEMPORARY SEEDED. AREAS BROUGHT TO FINAL GRADE THAT WILL REMAIN PERVIOUS ARE TO BE PERMANENTLY SEED. ALLOWABLE EXCEPTIONS FROM THE NPDES GENERAL PERMIT, GAR 100001, ARE NOTED BELOW.

WHERE THE INITIATION OF STABILIZATION MEASURES BY THE 14TH DAY AFTER CONSTRUCTION ACTIVITY TEMPORARILY OR PERMANENTLY CEASE IS PRECLUDED BY SNOW COVER OR OTHER ADVERSE WEATHER CONDITIONS, STABILIZATION MEASURES SHALL BE INITIATED AS SOON AS PRACTICABLE.

WHERE CONSTRUCTION ACTIVITY WILL RESUME ON A PORTION OF THE SITE WITHIN 21 DAYS FROM WHEN ACTIVITIES CEASED, (E.G. THE TOTAL TIME PERIOD THAT CONSTRUCTION ACTIVITY IS TEMPORARILY CEASED IS LESS THAN 21 DAYS) THEN STABILIZATION MEASURES DO NOT HAVE TO BE INITIATED ON THAT PORTION OF THE SITE BY THE 14TH DAY AFTER CONSTRUCTION ACTIVITY TEMPORARILY CEASED.

PLEASE REFER TO THE CONSTRUCTION SCHEDULE FOR THE LAND DISTURBANCE CONSTRUCTION SCHEDULE AND TEMPORARY AND PERMANENT GRASSING SCHEDULES.

STORMWATER FROM THIS DEVELOPMENT WILL BE ROUTED VIA SURFACE SHEET FLOW, AND STORMWATER PIPING, TO A PROPOSED STORMWATER DETENTION VAULT. THE STORMWATER DISCHARGE FROM THE VAULT WILL BE DIRECTLY PIPED INTO THE EXISTING STORMWATER CONVEYING SYSTEM THAT DISCHARGES INTO AN EXISTING DETENTION POND PRIOR TO REACHING A TRIBUTARY OF SHOALS CREEK.

OTHER CONTROLS

NO WASTE SHALL BE DISPOSED OF INTO STORMWATER INLETS OR WATERS OF THE STATE

WASTE MATERIALS

ALL HAZARDOUS WASTE MATERIALS SHALL BE COLLECTED AND STORED IN A SECURELY LIDDED METAL DUMPSTER. THE DUMPSTER SHALL MEET ALL SOLID WASTE MANAGEMENT REGULATIONS. ALL TRASH AND CONSTRUCTION DEBRIS FROM THE SITE SHALL BE DEPOSITED IN THE DUMPSTER. THE DUMPSTER SHALL BE EMPTIED A MINIMUM OF ONCE PER WEEK OR MORE OFTEN IF NECESSARY, AND TRASH SHALL BE HAULED AS REQUIRED BY LOCAL REGULATIONS. NO CONSTRUCTION WASTE SHALL BE BURIED ONSITE.

ALL PERSONNEL SHALL BE INSTRUCTED ON PROPER PROCEDURES FOR WASTE DISPOSAL. A NOTICE STATING THESE PRACTICES SHALL BE POSTED AT THE JOBSITE AND THE CONTRACTOR IS RESPONSIBLE FOR SEEING THAT THESE PROCEDURES ARE FOLLOWED.

HAZARDOUS WASTES

ALL HAZARDOUS WASTE MATERIALS SHALL BE DISPOSED OF IN THE MANNER SPECIFIED BY LOCAL, STATE, AND/OR FEDERAL REGULATIONS AND BY THE MANUFACTURER OF SUCH PRODUCTS. THE JOB SITE SUPERINTENDENT, WHO WILL ALSO BE RESPONSIBLE FOR SEEING THAT THESE PRACTICES ARE FOLLOWED, SHALL INSTRUCT SITE PERSONNEL IN THESE PRACTICES. MATERIAL SAFETY DATA SHEETS (MSDS) FOR EACH SUBSTANCE WITH HAZARDOUS PROPERTIES THAT IS USED ON THE JOB SITE SHALL BE OBTAINED AND USED FOR THE PROPER MANAGEMENT OF POTENTIAL WASTES THAT MAY RESULT FROM THESE PRODUCTS. AN MSDS SHALL BE POSTED IN THE IMMEDIATE AREA WHERE SUCH PRODUCT IS STORED AND/OR USED AND ANOTHER COPY OF EACH MSDS SHALL BE MAINTAINED IN THE ESPC PLAN FILE AT THE JOB SITE CONSTRUCTION TRAILER OFFICE. EACH EMPLOYEE WHO MUST HANDLE A SUBSTANCE WITH HAZARDOUS PROPERTIES SHALL BE INSTRUCTED ON THE USE OF MSDS SHEETS AND THE SPECIFIC INFORMATION IN THE APPLICABLE MSDS FOR THE PRODUCT HE/SHE IS USING, PARTICULARLY REGARDING SPILL CONTROL TECHNIQUES.

THE CONTRACTOR SHALL IMPLEMENT THE SPILL PREVENTION CONTROL AND COUNTERMEASURES PLAN WITHIN THE ESPC PLAN AND SHALL TRAIN ALL PERSONNEL IN THE PROPER CLEANUP AND HANDLING OF SPILLED MATERIALS. NO SPILLED HAZARDOUS MATERIALS OR HAZARDOUS WASTES SHALL BE ALLOWED TO COME IN CONTACT WITH STORMWATER DISCHARGES. IF SUCH CONTACT OCCURS, THE STORMWATER DISCHARGE SHALL BE CONTAINED ONSITE UNTIL APPROPRIATE MEASURES IN COMPLIANCE WITH STATE AND FEDERAL REGULATIONS ARE TAKEN TO DISPOSE OF SUCH CONTAMINATED STORMWATER. IT SHALL BE THE RESPONSIBILITY OF THE JOB SITE SUPERINTENDENT TO PROPERLY TRAIN ALL PERSONNEL IN THE USE OF THE SPOC PLAN.

SANITARY WASTES

A MINIMUM OF ONE PORTABLE SANITARY UNIT SHALL BE PROVIDED FOR EVERY TWENTY (20) WORKERS ON THE SITE. ALL SANITARY WASTE SHALL BE COLLECTED FROM THE PORTABLE UNITS A MINIMUM OF ONE TIME PER WEEK BY A LICENSED PORTABLE FACILITY PROVIDER IN COMPLETE COMPLIANCE WITH LOCAL AND STATE REGULATIONS.

ALL SANITARY WASTE UNITS SHALL BE LOCATED IN AN AREA WHERE THE LIKELIHOOD OF THE UNIT CONTRIBUTING TO STORM WATER DISCHARGE IS NEGLIGIBLE. ADDITIONAL CONTAINERS SHALL BE PROVIDED TO STORE WASTE. SUCH AS GRAVEL BAGS OR SPECIALLY DESIGNED PLASTIC SKID CONTAINERS AROUND THE BASE, TO PREVENT WASTES FROM CONTRIBUTING TO STORM WATER DISCHARGES. THE LOCATION OF SANITARY WASTE UNITS MUST BE IDENTIFIED ON THE EROSION CONTROL PLAN INTERMEDIATE PHASE BY THE CONTRACTOR ONCE THE LOCATIONS HAVE BEEN DETERMINED.

OFFSITE VEHICLE TRACKING

A STABILIZED CONSTRUCTION EXIT HAS BEEN PROVIDED TO HELP REDUCE VEHICLE TRACKING OF SEDIMENT. SEE SHEET C-103 AND C-507 FOR CONSTRUCTION EXIT LOCATION AND DETAIL. THE PAVED STREET ADJACENT TO THE SITE EXIT SHALL BE INSPECTED DAILY FOR TRACKING OF MUD, DIRT, OR ROCK. DUMP TRUCKS HAULING MATERIAL FROM THE CONSTRUCTION SITE SHALL HAVE LOADS COVERED WITH A TARPULIN.

INVENTORY FOR POLLUTION PREVENTION PLAN

THE FOLLOWING MATERIALS ARE EXPECTED ONSITE DURING CONSTRUCTION: CONCRETE PRODUCTS, NATURAL STONES, ASPHALT, PETROLEUM BASED FUELS AND LUBRICANTS FOR EQUIPMENT, TAR, LUMBER, FLOOR COVERINGS, ELECTRICAL WIRE AND FIXTURES, PAINTS/STAINS/FINISHING TREATMENTS, PAINTS, PAINT SOLVENTS, ADDITIVES FOR SOIL STABILIZATION, CLEANING SOLVENTS, PESTICIDES, FERTILIZERS, HERBICIDES, CRUSHED STONE, PLASTIC AND METAL PIPES.

SPILL PREVENTION

PRACTICES SUCH AS GOOD HOUSEKEEPING, PROPER HANDLING OF HAZARDOUS PRODUCTS AND PROPER SILT CONTROL PRACTICES SHALL BE FOLLOWED TO REDUCE THE RISK OF SPILLS AND SPILLS FROM DISCHARGING INTO STORM WATER RUNOFF.

GOOD HOUSEKEEPING

QUANTITIES OF PRODUCTS STORED ONSITE SHALL BE LIMITED TO THE AMOUNT NEEDED FOR THE JOB.

1. PRODUCTS AND MATERIALS SHALL BE STORED IN A NEAT, ORDERLY MANNER IN APPROPRIATE CONTAINERS PROTECTED FROM RAINFALL, WHERE POSSIBLE.
2. PRODUCTS SHALL BE KEPT IN THEIR ORIGINAL CONTAINERS WITH MANUFACTURER LABELS LEGIBLE AND VISIBLE.
3. PRODUCT MIXING, DISPOSAL AND DISPOSAL OF PRODUCT CONTAINERS SHALL BE ACCORDING TO THE MANUFACTURER'S RECOMMENDATIONS.
4. THE CONTRACTOR SHALL INSPECT SUCH MATERIALS TO ENSURE PROPER USE, STORAGE AND DISPOSAL.

PRODUCT SPECIFIC PRACTICES

PETROLEUM BASED PRODUCTS – CONTAINERS FOR PRODUCTS SUCH AS FUELS, LUBRICANTS AND TARS SHALL BE INSPECTED DAILY FOR LEAKS AND SPILLS. THIS INCLUDES ON-SITE VEHICLE AND MACHINERY DAILY INSPECTIONS AND REGULAR PREVENTATIVE MAINTENANCE OF SUCH EQUIPMENT. EQUIPMENT MAINTENANCE AREAS SHALL BE LOCATED AWAY FROM STATE WATER, NATURAL DRAINS AND STORM WATER DRAINAGE. IN ADDITION, TEMPORARY FUELING TANKS SHALL HAVE A SECONDARY CONTAINMENT LINER TO PREVENT/MINIMIZE SITE CONTAMINATION.

DISCHARGE OF OILS, FUELS AND DISPOSAL AS REQUIRED BY LOCAL AND STATE REGULATIONS.

PAINTS/FINISHES/SOLVENTS – ALL PRODUCTS SHALL BE STORED IN TIGHTLY SEALED ORIGINAL CONTAINERS WHEN NOT IN USE. EXCESS PRODUCT SHALL NOT BE DISCHARGED TO THE STORM WATER COLLECTION SYSTEM. EXCESS PRODUCT, MATERIALS USED WITH THESE PRODUCTS AND PRODUCT CONTAINERS SHALL BE DISPOSED OF ACCORDING TO MANUFACTURER'S SPECIFICATIONS AND RECOMMENDATIONS.

CONCRETE TRUCK WASHING – BERMED CONTAINMENT AREAS SHALL BE ESTABLISHED FOR CONCRETE TRUCKS TO WASH DOWN TOOLS. CONCRETE MIXER CHUTES, HOPPERS AND THE REAR OF THE VEHICLES, WASH OUT OF THE DRUM AT THE CONSTRUCTION SITE IS PROHIBITED.


FERTILIZER/HERBICIDES – THESE PRODUCTS SHALL BE APPLIED AT RATES THAT DO NOT EXCEED THE MANUFACTURER'S SPECIFICATIONS OR ABOVE THE GUIDELINES SET FORTH IN THE CROP ESTABLISHMENT OR IN THE GSWC MANUAL FOR EROSION AND SEDIMENT CONTROL IN GEORGIA. ANY STORAGE OF THESE MATERIALS SHALL BE UNDER ROOF IN SEALED CONTAINERS.

BUILDING MATERIALS – NO BUILDING OR CONSTRUCTION MATERIALS SHALL BE BURIED OR DISPOSED OF ONSITE. ALL SUCH MATERIAL SHALL BE DISPOSED OF IN PROPER WASTE DISPOSAL PROCEDURES.





SOIL CLEANUP AND CONTROL PRACTICES

- LOCAL, STATE, AND MANUFACTURER'S RECOMMENDED METHODS FOR SPILL CLEANUP SHALL BE CLEARLY POSTED AND PROCEDURES SHALL BE MADE AVAILABLE TO SITE PERSONNEL.
- MATERIAL AND EQUIPMENT NECESSARY FOR SPILL CLEANUP SHALL BE KEPT IN THE MATERIAL STORAGE AREAS. TYPICAL MATERIALS AND EQUIPMENT INCLUDES, BUT IS NOT LIMITED TO, BROOMS, DUSTPANS, MOPS, RAGS, GLOVES, COGGLES, CAT LITTER, SAND, SAWDUST, AND PROPERLY LABELED PLASTICS AND METAL WASTE CONTAINERS.
- SPILL PREVENTION PRACTICES AND PROCEDURES SHALL BE REVIEWED AFTER A SPILL AND ADJUSTED AS NECESSARY TO PREVENT FUTURE SPILLS.
- ALL WASTE MATERIALS SHALL BE CLEANED UP IMMEDIATELY UPON DISCOVERY. ALL SPILLS SHALL BE REPORTED AS REQUIRED BY LOCAL, STATE AND FEDERAL REGULATIONS.
- FOR SPILLS THAT IMPACT SURFACE WATER (LEAVE A SHEEN ON SURFACE), THE NATIONAL RESPONSE CENTER (NRC) SHALL BE CONTACTED WITHIN 24 HOURS AT 1-800-424-8802.
- FOR SPILLS OF AN UNKNOWN AMOUNT, THE NATIONAL RESPONSE CENTER (NRC) SHALL BE CONTACTED WITHIN 24 HOURS AT 1-800-424-8802.
- FOR SPILLS GREATER THAN 25 GALLONS AND NO SURFACE WATER IMPACTS, THE GEORGIA EPD SHALL BE CONTACTED WITHIN 24 HOURS.
- FOR SPILLS LESS THAN 25 GALLONS AND NO SURFACE WATER IMPACTS, THE SPILL SHALL BE CLEANED UP AND LOCAL AGENCIES SHALL BE CONTACTED AS REQUIRED.

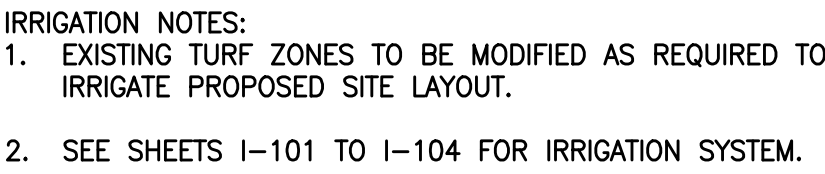
THE CONTRACTOR SHALL NOTIFY THE LICENSED PROFESSIONAL WHO PREPARED THIS PLAN IF MORE THAN 1320 GALLONS OF PETROLEUM IS STORED ONSITE (THIS INCLUDES CAPACITIES OF EQUIPMENT) OR IF ANY EQUIPMENT OR VEHICLE IS LEAKING MORE THAN 600 GALLONS. IF EITHER OF THESE TWO CONDITIONS OCCUR, THE CONTRACTOR SHALL PREPARE A SPILL PREVENTION, CONTROL, AND COUNTERMEASURES PLAN (SPOC) PREPARED BY



LEGEND

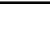
	PERMANENT GRASS
	GLOWING EMBERS
	"RED ROCKET" MAPLE
	"NATCHEZ" GRAPE

1. ALL NURSERY STOCK SHALL MEET SPECIFICATIONS. ROOT BALLS SHALL MEET OR EXCEED SIZE STANDARDS SET FORTH IN "AMERICAN STANDARDS FOR NURSERY STOCK", LATEST EDITION. MAIN LEADERS OF ALL TREES SHALL REMAIN INTACT.
2. MULCH SHALL BE DRY, CLEAN, AND FREE FROM ANY NOXIOUS WEEDS OR DELETERIOUS MATERIAL. MULCH PLANT PITS AND PLANTING BEDS WITH SPECIFIED MULCH TO THE DEPTH INDICATED ON THE DRAWINGS AND DETAILS.
3. REMOVE FROM SITE ANY PLANT MATERIAL WHICH TURNS BROWN OR DEFOLIATES WITHIN FIVE DAYS AFTER PLANTING. REPLACE IMMEDIATELY WITH APPROVED SPECIFIED MATERIAL.
4. MAINTAIN ALL PLANT MATERIAL UNTIL SUBSTANTIAL COMPLETION, UNLESS OTHERWISE SPECIFIED. MAINTENANCE INCLUDES WATERING, WEEDING, MULCHING, STRAIGHTENING, MOVING, FERTILIZING, CLEANUP, AND OTHER TASKS AS NEEDED.
5. CONTRACTOR TO REMOVE COMPACTED SOIL FROM TREE PLANTING AREA A MAXIMUM OF 4 FEET AND MINIMUM OF 3 FEET.
6. OUTER LIMITS OF PLANNING ARE APPROXIMATE. WHEN SODDING IS NOTED ON THE SODS, IT SHALL APPLY TO ALL AREAS DISTURBED BY CONSTRUCTION ACTIVITIES, EVEN IF THESE ACTIVITIES EXTEND BEYOND THE SODDING LIMITS APPROXIMATED.

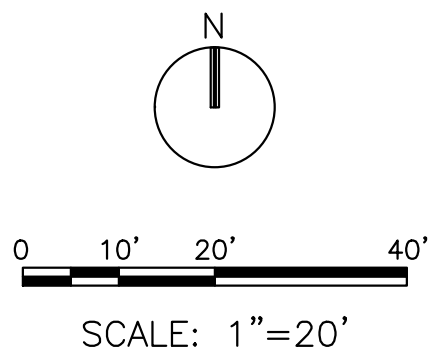

IRRIGATION GENERAL NOTES:

1. CONTRACTOR IS RESPONSIBLE FOR ALL WORK SHOWN UNLESS SPECIFICALLY INDICATED OTHERWISE.
2. CONTRACTOR SHALL VISIT THE SITE PRIOR TO CONSTRUCTION TO DETERMINE THE EXTENT OF THE PROJECT.
3. CONTRACTOR SHALL CONTACT LOCAL UTILITY PROTECTION SERVICE (MISS DIG) PRIOR TO ANY WORK. CONTRACTOR IS RESPONSIBLE FOR FIELD LOCATING AND PROTECTING ALL UTILITIES. CONTACT THE ENGINEER IN THE EVENT THAT THE UTILITIES CONFLICT WITH THE PLAN DRAWINGS.
4. CONTRACTOR TO PLACE LATERAL MIN. 3 FEET INSIDE FENCE. LOCATE HEADS 6 INCHES FROM FENCE.
5. THE IRRIGATION CONTRACTOR SHALL PROVIDE ON-SITE AND HANDS-ON TRAINING FOR THE CEMETERY EMPLOYEES WITH RESPECT TO THE IRRIGATION SYSTEM.
6. THE IRRIGATION CONTRACTOR SHALL PREPARE AND PROVIDE A GPS MAPPED AS-BUILT DRAWING FOR THE INSTALLED SYSTEM IN AUTOCAD 2010 FORMAT. REFER TO SPECIFICATIONS FOR MORE INFORMATION.
7. THE IRRIGATION CONTRACTOR SHALL CONDUCT A PRE-IRRIGATION MEETING PRIOR TO ANY INSTALLATION.
8. THE IRRIGATION CONTRACTOR SHALL PREPARE AND PROVIDE A COLORED 30"x42" LAMINATED ZONE MAP. THE ZONE MAP MUST BE APPROVED BY THE VA PRIOR TO COMPLETION AND INSTALLATION.
9. THE IRRIGATION CONTRACTOR SHALL PROVIDE 10 SPARE 8005-SS SERIES IRRIGATION HEADS, 10 SPARE 8005-SS SAM-PRS SERIES IRRIGATION HEADS, 10 SPARE 1806-SAM-PRS SPRAY HEADS AND 10 SPARE 1812-SAM-PRS SRPAY HEADS.
10. THE IRRIGATION CONTRACTOR SHALL MAINTAIN A WORKING DRAWING OF THE IRRIGATION SYSTEM ON SITE AT ALL TIMES DURING CONSTRUCTION.
11. THE IRRIGATION CONTRACTOR SHALL COORDINATE THE INSTALLATION OF THE IRRIGATION SYSTEM WITH THE LANDSCAPE CONTRACTOR TO INSURE PROPER INSTALLATION OF BOTH THE IRRIGATION SYSTEM AND THE LANDSCAPE MATERIAL.
12. THE IRRIGATION SYSTEM PLAN IS ILLUSTRATED IN SCHEMATIC FORM. THE IRRIGATION CONTRACTOR MAY BE REQUIRED TO MAKE MINOR ADJUSTMENTS IN THE FIELD. THESE MINOR ADJUSTMENTS SHALL BE MADE AT NO ADDITIONAL COST TO THE OWNER BUT SHALL BE MADE ONLY AFTER NOTIFICATION IS MADE TO THE OWNER OR HIS REPRESENTATIVE.
13. THE CONTRACTOR SHALL FAMILIARIZE HIMSELF WITH THE SITE SO THAT HE IS AWARE OF ANY SPECIAL CONDITIONS WHICH EXIST THAT MAY AFFECT HIS BID PROPOSAL AND SHALL THEREAFTER BE RESPONSIBLE FOR ALL COST INCURRED BY HIMSELF IN RELATION TO THE INSTALLATION.
14. ALL SPRINKLERS WILL BE MOUNTED ON UNITIZED SWING JOINTS.
15. ALL PIPING AND WIRING UNDER HARDTOPS WILL BE IN SCH 40 PVC PIPE SLEEVE.
16. IRRIGATION CONTRACTOR MUST STAKE ALL PROPOSED TRENCHLINES IN GRAVESITE AREAS FOR REVIEW AND APPROVAL BY OWNER'S REPRESENTATIVE BEFORE ANY TRENCHING ACTIVITIES OCCUR.
17. IRRIGATION CONTRACTOR WILL BE RESPONSIBLE TO SETUP MANUFACTURER'S TRAINING FOR OPERATION AND MAINTENANCE OF THE COMPLETE IRRIGATION SYSTEM, INCLUDING CENTRAL CONTROL, TO AT LEAST FOUR NCA EMPLOYEES. TRAINING SHALL BE FOR 16 HOURS AND WILL BE DONE IN INCREMENTS NO LONGER THAN 4 HOURS IN DURATION.
18. CONTRACTOR TO UTILIZE A CHECK VALVE DEVICE FOR ALL SPRINKLER HEADS.
19. ALL GROUNDING AND SURGE PROTECTION TO BE INSTALLED AS PER MANUFACTURER'S SPECIFICATIONS/RECOMMENDATIONS AND IN ACCORDANCE WITH ASIC GUIDELINES.
20. FOR ALL THREADED CONNECTIONS, UTILIZE WELD-ON ALL PURPOSE THREAD SEALANT PASTE FOR PVC PIPE (NON-TEFLON).

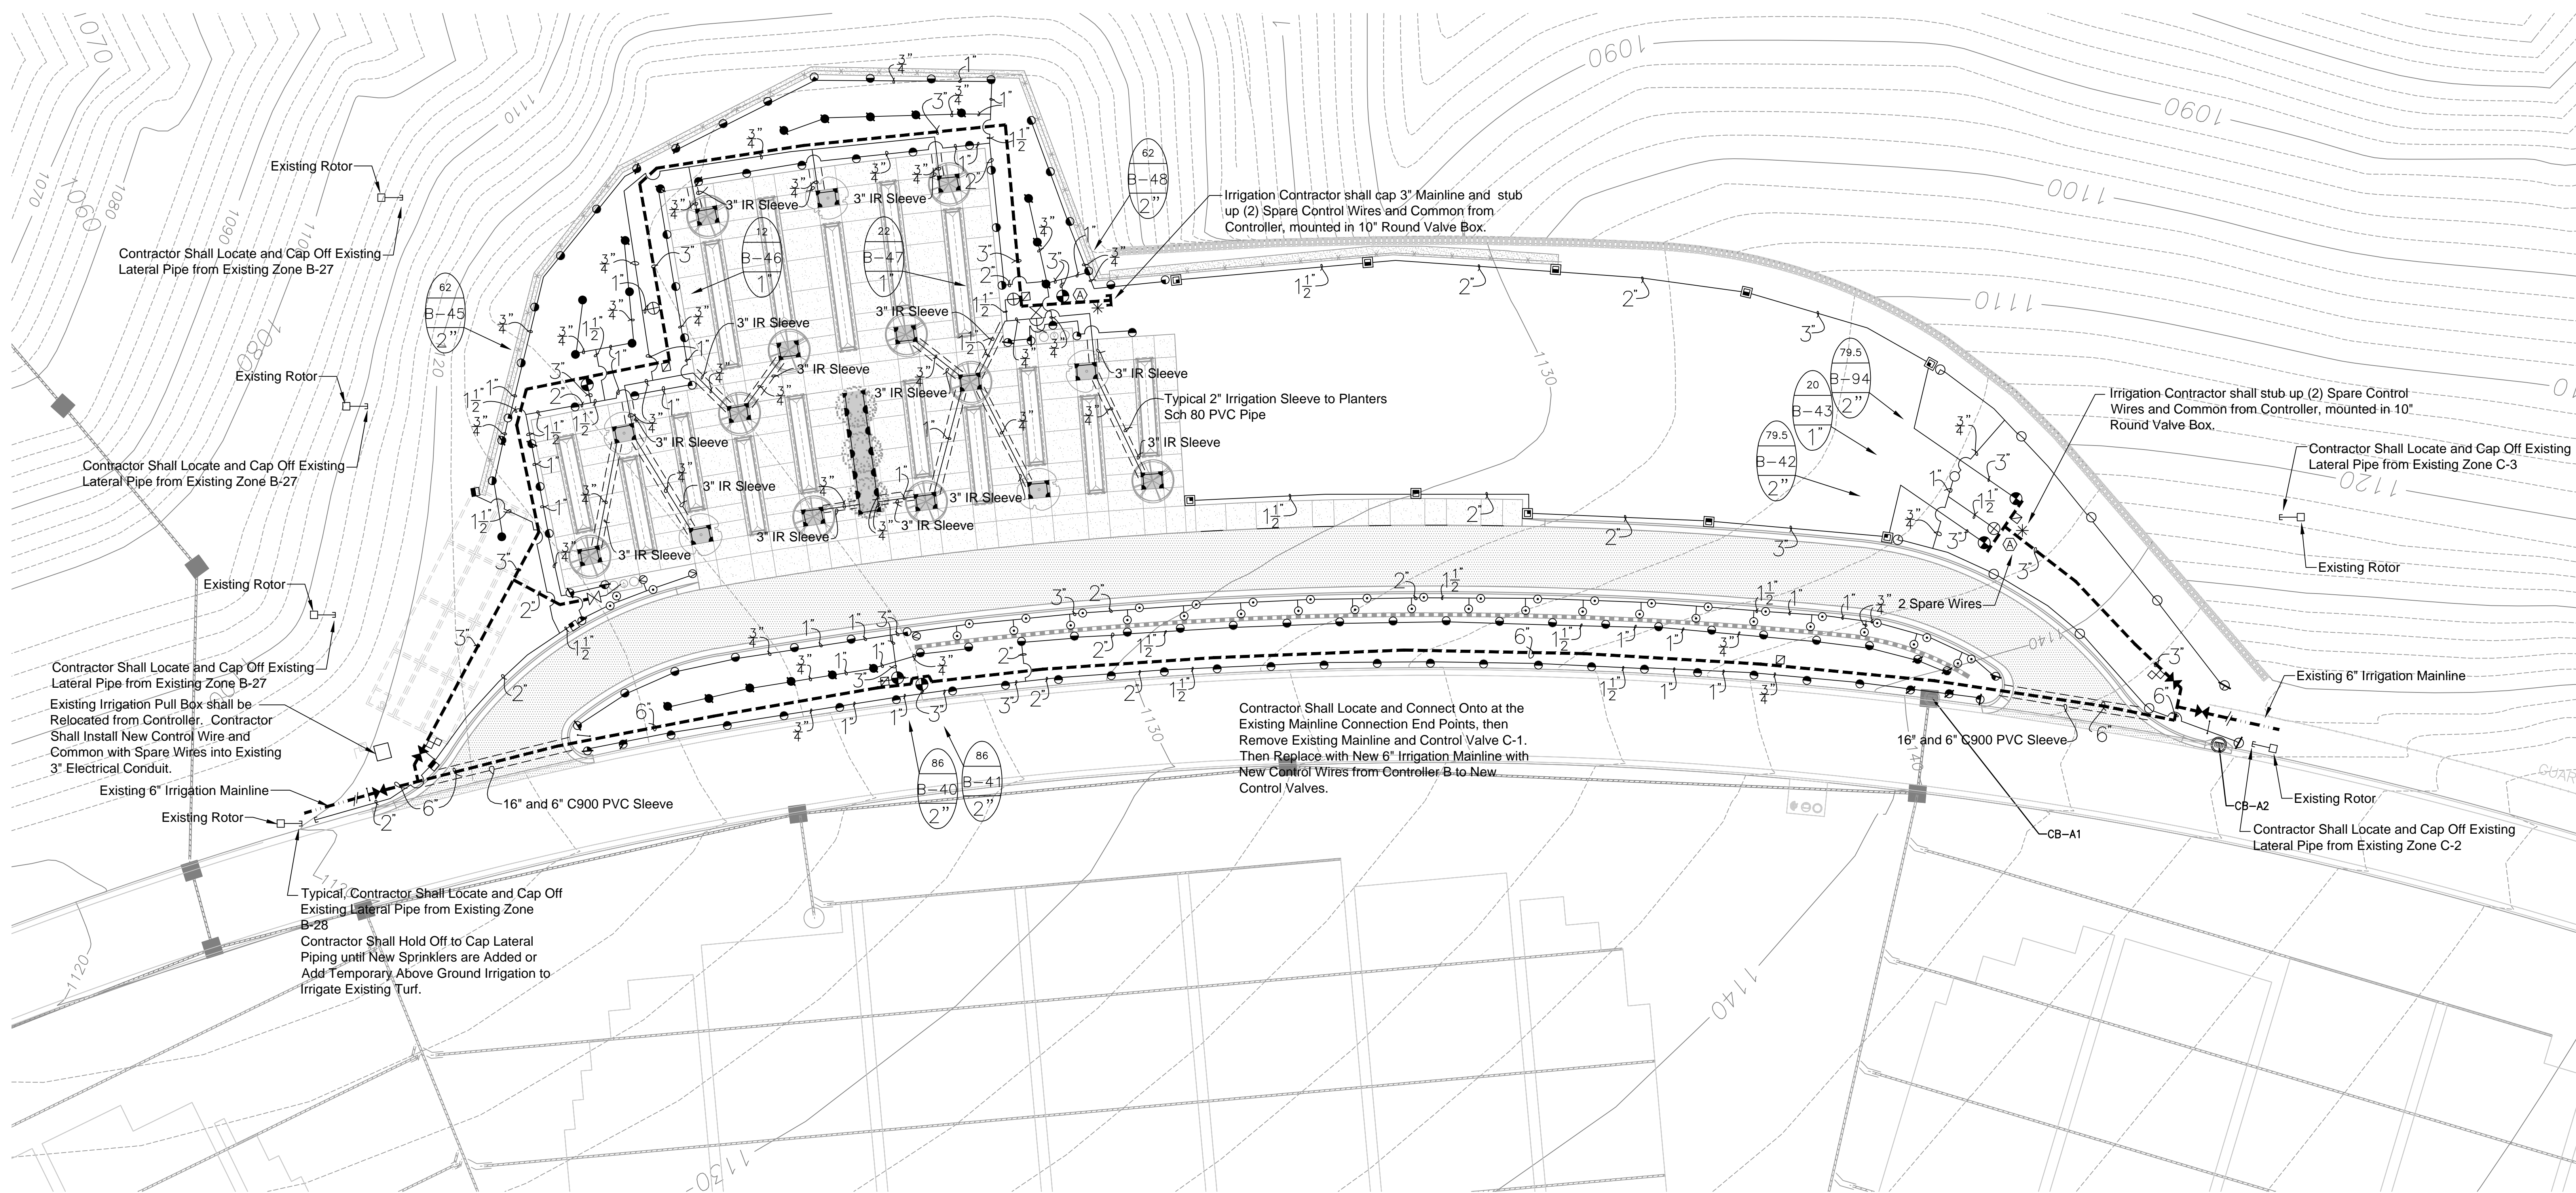


IRRIGATION LEGEND



- SYSTEM NOTES:
*NEW IRRIGATION SYSTEM WILL BE CONNECTED TO EXISTING IRRIGATION SYTSEM. REFER TO PLANS FOR MORE SPECIFICS ON POINTS OF CONNECTION, POINTS TO CONECTION ONTO AND TO CAP OFF EXISTING IRRIGATION, ETC.
*IRRIGATION INSTALLATION CONTRACTOR SHALL BE RESPONSIBLE TO ENSURE THAT NEW IRRIGATION IS FULLY PROGRAMMED INTO EXISTING CONTROLLER/CENTRAL CONTROL SYSTEM.
- 2" MANUAL DRAIN VALVE. BRASS BALL VALVE. DETAIL-J.
- RAIN BIRD 150-EFB-CP-PRS OR 200-EFB-CP-PRS BRASS ELECTRIC REMOTE CONTROL VALVE, 1 1/2" OR 2" SIZE, MOUNTED WITH LEEMCO LV-212 LATERAL ISOLATION TEE AND WITH PRESSURE REGULATION DEVICES. DETAIL-B.
- RAIN BIRD 100-EFB-CP-PRS BRASS ELECTRIC REMOTE CONTROL VALVE, 1" SIZE, MOUNTED WITH LEEMCO LV-212 LATERAL ISOLATION TEE ANDWITH PRESSURE REGULATION DEVICES. DETAIL-B.
- 2" AIR/VACUUM RELIEF VALVE. INSTALLED AT HIGH POINTS OF IRRIGATION MAINLINE LOOP AS NOTED ON IRRIGATION PLANS. DETAIL-L.
- RAIN BIRD 1806-SAM-PRS, 6" POP-UP LAWN SPRAY SPRINKLER, 15' RADIUS, FULL-4.0 GPM, HALF-2.0 GPM, QUARTER-1.0 GPM, 30 PSI. DETAIL-M.
- RAIN BIRD 1806-SAM-PRS, 6" POP-UP LAWN SPRAY SPRINKLER, 12' RADIUS, FULL-3.0 GPM, HALF-1.5 GPM, QUARTER-0.75 GPM, 30 PSI. DETAIL-M.
- RAIN BIRD 1806-SAM-PRS, 6" LAWN SIDE STRIP SPRAY SPRINKLER, 4' X 30' RADIUS, 1.5 GPM, 30 PSI. DETAIL-M.
- RAIN BIRD 1806-SAM-PRS, 6" LAWN END STRIP SPRAY SPRINKLER, 4' X 15' RADIUS, 1.0 GPM, 30 PSI. DETAIL-M.
- RAIN BIRD 1812-SAM-PRS, 12" HI-POP SHRUB SPRAY SPRINKLER, 5' RADIUS, HALF-0.2 GPM, QUARTER-0.1 GPM, 30 PSI. DETAIL-J.
- RAIN BIRD 8005-SS-12, WITH #12 NOZZLE, LARGE TURF CLOSED CASE ROTOR, FULL CIRCLE ARC, 65' RADIUS @ 12.0 GPM, 60 PSI, RUBBER COVER, STAINLESS STEEL RISER, UTILIZE 1" UNITIZED TRIPLE SWING JOINTS, DETAIL-K.
- RAIN BIRD 8005-SS-12, WITH #12 NOZZLE, LARGE TURF CLOSED CASE ROTOR, PART CIRCLE ARC, 65' RADIUS @ 20.0 GPM, 60 PSI, RUBBER COVER, STAINLESS STEEL RISER, UTILIZE 1" UNITIZED TRIPLE TOP SWING JOINTS, DETAIL-K.
- RAIN BIRD 8005-SS-16, WITH #16 NOZZLE, LARGE TURF CLOSED CASE ROTOR, FULL CIRCLE ARC, 65' RADIUS @ 15.9 GPM, 60 PSI, RUBBER COVER, STAINLESS STEEL RISER, UTILIZE 1" UNITIZED TRIPLE TOP SWING JOINTS, DETAIL-K.
- RAIN BIRD 8005-SS-16, WITH #16 NOZZLE, LARGE TURF CLOSED CASE ROTOR, PART CIRCLE ARC, 65' RADIUS @ 15.9 GPM, 60 PSI, RUBBER COVER, STAINLESS STEEL RISER, UTILIZE 1" UNITIZED TRIPLE TOP SWING JOINTS, DETAIL-K.
- RAIN BIRD #5 QUICK COUPLING VALVE 1" SIZE. CONTRACTOR TO SUPPLY TWO QCV KEYS AND MATCHING HOSE SWIVELS. DETAIL-C.
- MAINLINE ISOLATION GATE VALVE, DOMESTIC DUCTILE IRON GASKETED, DETAIL-A.
- MAINLINE PIPE:
1-1/2" AND SMALLER MAINLINE SHALL BE SCH 40 PVC (SOLVENT WELD) UTILIZING SCH 40 PVC SOLVENT WELD FITTINGS. 3" AND LARGER MAINLINE SHALL BE GASKETED CLASS 200 PVC UTILIZING DUCTILE IRON LEEMCO FITTINGS AND LEEMCO RESTRAINTS.
- IRRIGATION SLEEVE: C900 PVC (UNLESS NOTED OTHERWISE), SIZE NOTED ON PLAN. DETAIL-G.
- LATERAL LINE PIPE: SCH 40 PVC (SOLVENT WELD), SIZE NOTED.
- TYPICAL VALVE INDICATOR
- 28.5 GALLONS PER MIN.
10 STATION NUMBER
1 1/2" VALVE SIZE


NOTES:

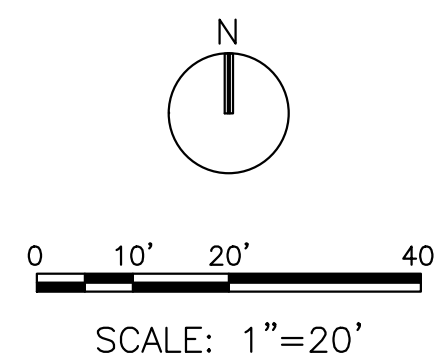1. ALL SPRINKLERS WILL BE MOUNTED ON UNITIZED SWING JOINTS (TRIPLE TOP).
2. CONTRACTOR TO UTILIZE A AUTOMATIC DRAIN CHECK VALVE DEVICE FOR ALL SPRINKLERS.
3. ALL PIPING AND WIRING UNDER HARDTOPS WILL BE IN CLASS SCH 40 PVC PIPE SLEEVE.
4. IRRIGATION CONTRACTOR MUST STAKE ALL PROPOSED TRENCHLINES IN GRAVESITE AREAS FOR REVIEW AND APPROVAL BY OWNER'S REPRESENTATIVE BEFORE ANY TRENCHING ACTIVITIES OCCUR.
5. IRRIGATION CONTRACTOR WILL BE RESPONSIBLE TO SETUP MANUFACTURER'S TRAINING (I.E. RAIN BIRD) FOR OPERATION AND MAINTENANCE OF THE COMPLETE IRRIGATION SYSTEM, INCLUDING CENTRAL CONTROL, TO AT LEAST FOUR NCA EMPLOYEES.
6. IRRIGATION CONTRACTOR WILL BE RESPONSIBLE TO REPLACE AND/OR REPAIR ANY EXISTING IRRIGATION EQUIPMENT DAMAGED DURING NEW CONSTRUCTION.



BID DOCUMENTS

<div>Revisions</div> <div>Date</div>	<div>PRIME:</div> <div><div>AMEC FOSTER WHEELER ENVIRONMENT & INFRASTRUCTURE 1075 BIG SHANTY ROAD NW, SUITE 100 KENNESAW, GA, 30144 (770) 421-3400 AMEC PROJECT: 6166-15-0011</div></div>	<div>MEP ENGINEER:</div> <div></div>	<div>IRRIGATION DESIGNER:</div> <div><div>2231 Weatherstone Circle Conyers, GA 30094 (770) 929-0884, fax (770) 760-8025</div></div>	<div><div>NATIONAL CEMETERY ADMINISTRATION</div></div>	<div>Drawing Title</div> <div>IRRIGATION PLAN</div> <div>Approved: Director, Technical Support Service</div> <div>Approved: Chief, Architectual & Engineering Division</div>	<div>Project Title</div> <div>4000 NICHE COLUMBARIUM GEORGIA NATIONAL CEMETERY</div> <div>Building Number</div> <div>Checked</div> <div>Drawn</div> <div>Location</div> <div>1080 VETERANS CEMETERY RD, CANTON, GA 30114</div>	<div>Date</div> <div>23 OCTOBER 2015</div> <div>Project No.</div> <div>922CM3005</div> <div>DRAWING NO.</div> <div>I-101</div> <div>Sheet 27 Of 31</div>
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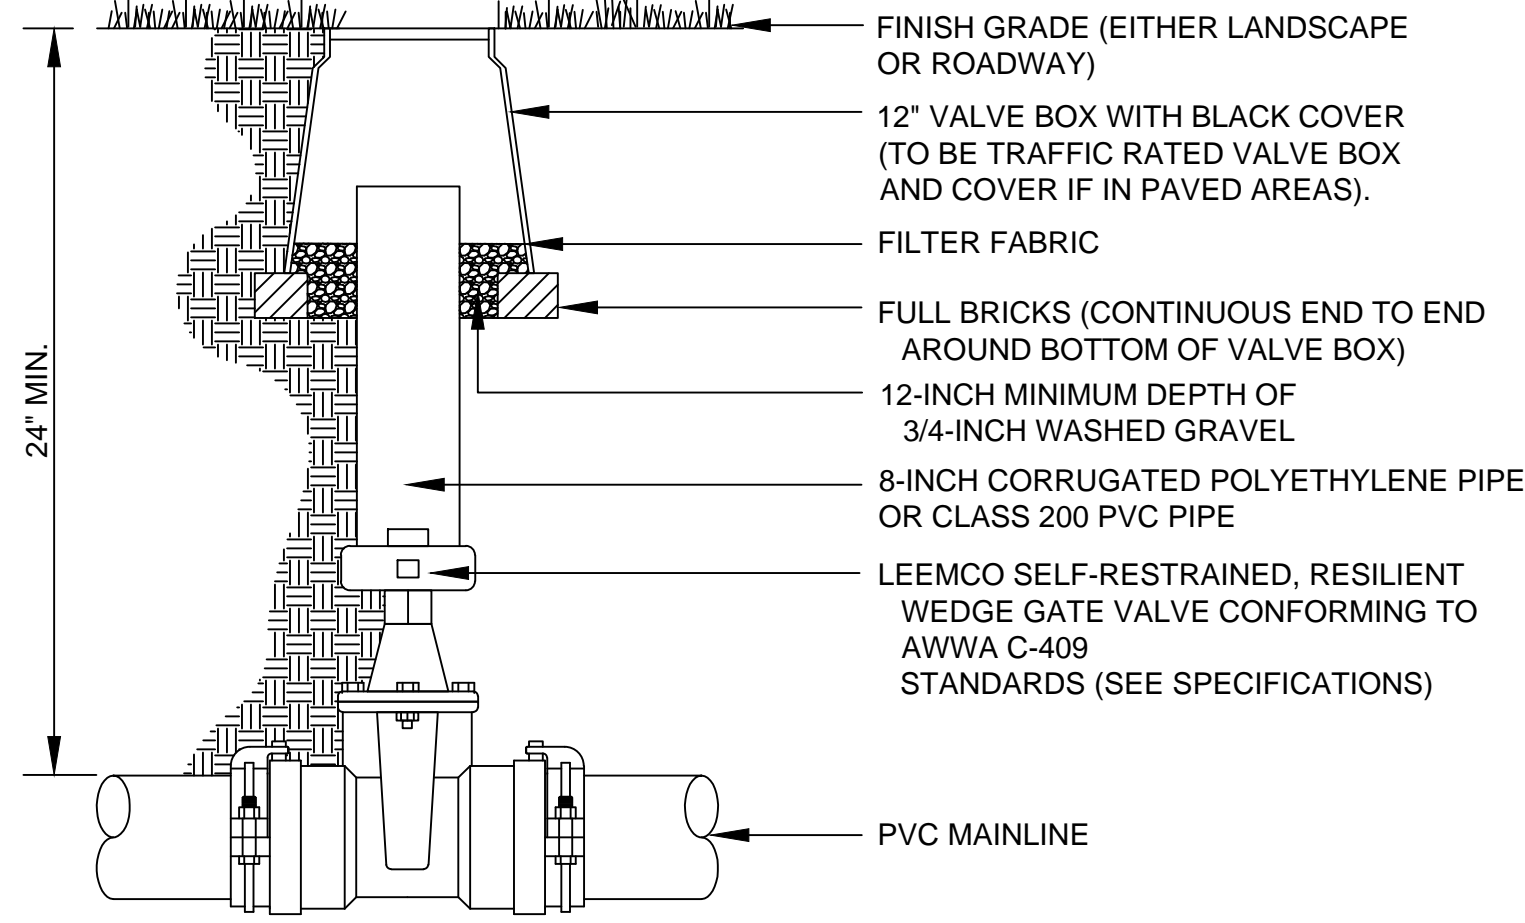


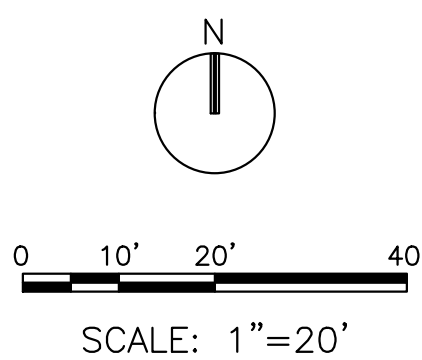Date	
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Sheet 28 of 31

NOTES:

1. RESTRAINTS TO BE UTILIZED ON ALL MAINLINE AS PER MANUFACTURER'S RECOMMENDATIONS FOR PIPE TYPE, PIPE SIZE, AND LOCAL ENVIRONMENTAL CONDITIONS. THRUST BLOCKING WILL NOT BE UTILIZED.
2. UTILIZE RAIN BIRD COMMERCIAL GRADE VALVE BOXES.
3. ALL SWING JOINTS FOR SPINKLER HEADS AND QUICK COUPLER VALVES TO UTILIZED TRIPLE TOP SWING JOINTS.




NOTES:

1. NOMINAL SIZE OF GATE VALVE TO MATCH NOMINAL MAINLINE SIZE.
2. INSTALL A 4-INCH THICK CONCRETE PAD BELOW VALVE WITH NO. 4 REBAR WHEN USING PUSH ON TYPE VALVES.
3. RESILIENT WEDGE GATE VALVE TO UTILIZE MECHANICAL JOINT. THE OPERATOR IS A WRENCH NUT.
4. ANCHOR ISOLATION VALVE TO CONCRETE BY BENDING REBAR OVER EACH END OF VALVE AND EXTENDING A MINIMUM OF 6-INCHES INTO CONCRETE SUPPORT BLOCK.
5. WRAP VALVE ENDS AND BODY IN 3 MIL. PLASTIC PRIOR TO POURING CONCRETE.
6. CONCRETE SUPPORT BLOCK IS TO BE POURED UNDER ISOLATION GATE VALVE. ONLY THE BOTTOM OF THE ISOLATION GATE VALVE TO BE IN CONTACT WITH CONCRETE.
7. INSTALL FILTER FABRIC AROUND EXTERIOR OF VALVE BOX. USE DUCT TAPE TO SECURE FABRIC TO PIPE AND VALVE BOX.
8. LABEL VALVE BOX COVER PER SPECIFICATIONS.
9. ISOLATION VALVES TO BE INSTALLED WITH EXPANSION RESTRAINTS.

A ISOLATION GATE VALVE

NTS

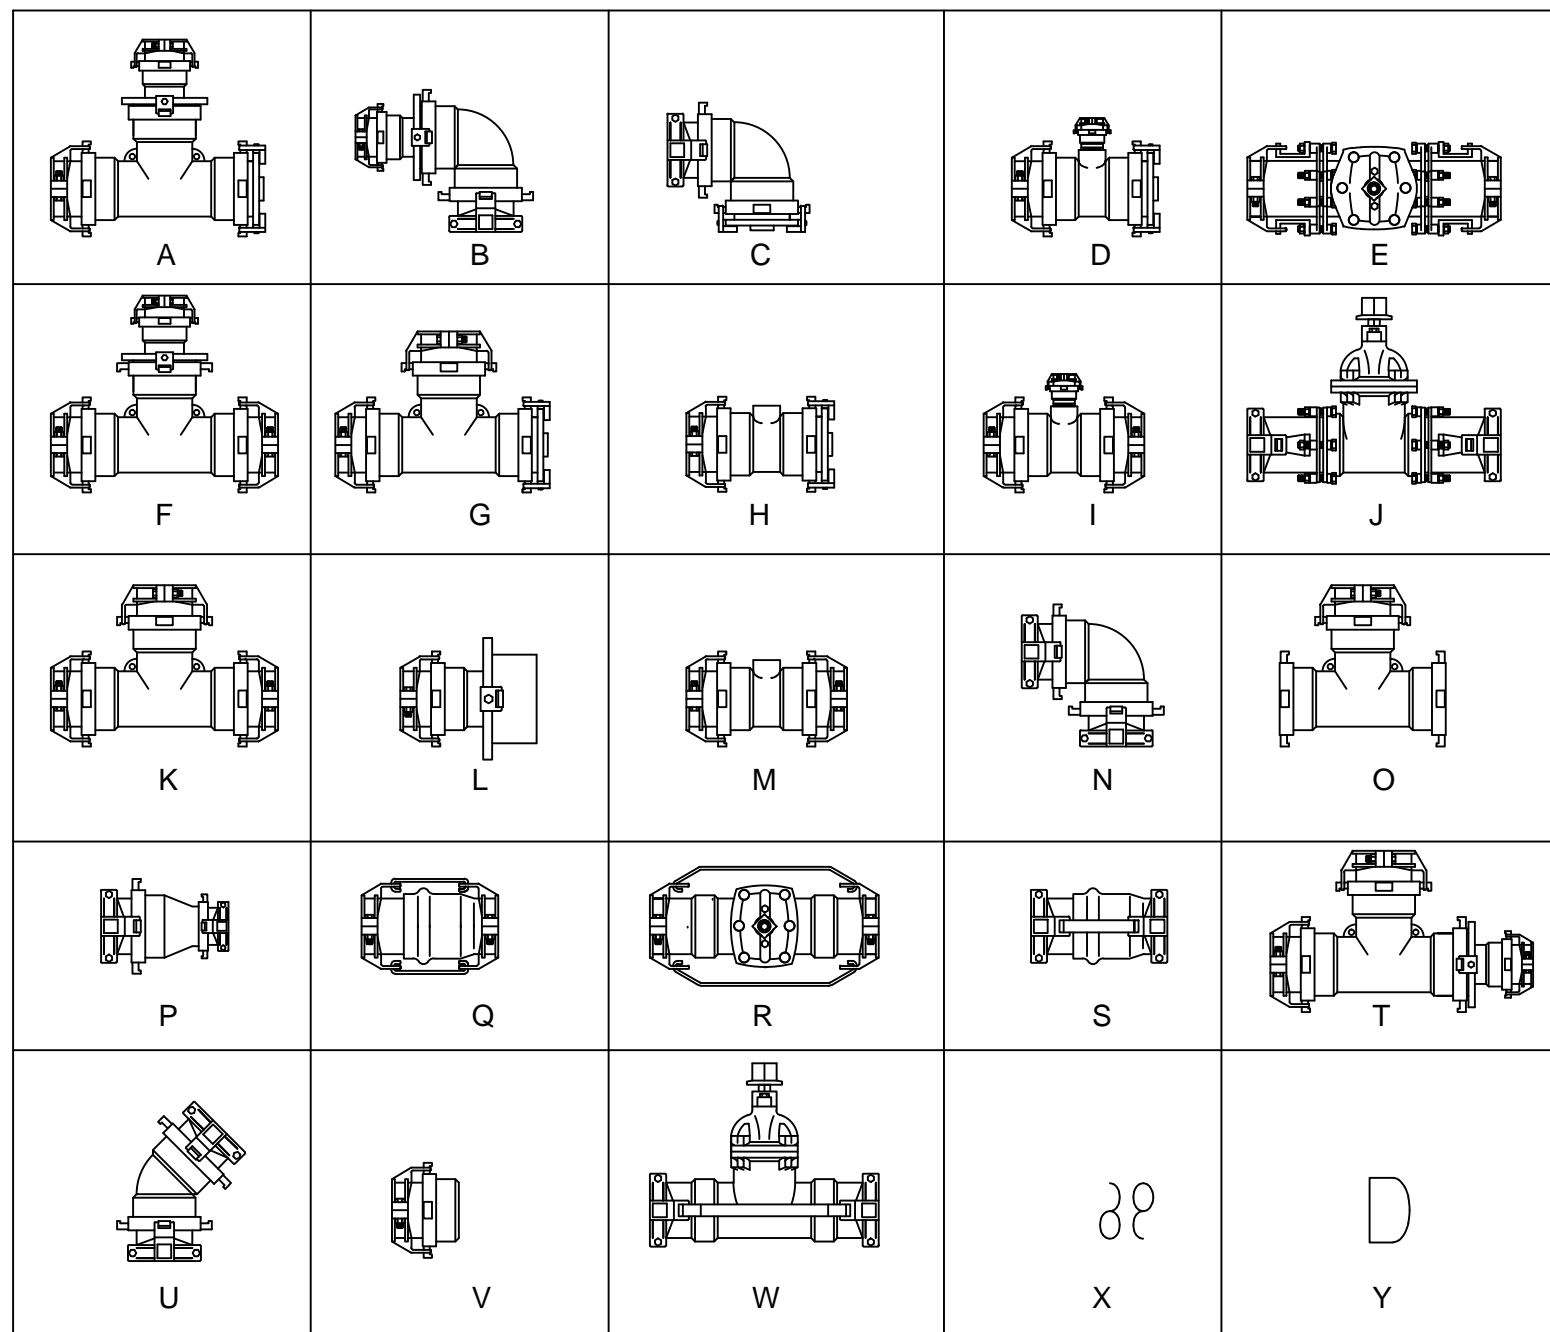

DISTANCE CHART

REFER TO THE FOLLOWING TABLE THAT LISTS THE LENGTH (IN FEET) FOR EACH SIZE/TYPE FITTING WITHIN WHICH ALL JOINTS MUST BE RESTRAINED. ALL FITTINGS AND JOINT RESTRAINTS SHALL BE INSTALLED PER MANUFACTURERS RECOMMENDATIONS & SPECIFICATIONS.

AS AN EXAMPLE, IF YOU ARE INSTALLING A 3" MAINLINE WITH A DIRECTIONAL CHANGE OF 90°, REFER TO CHART UNDER PIPE SIZE TO 3" AND UNDER BENDS SO YOU WILL SEE THE DISTANCE OF 11". IF THERE IS ANY JOINT (VALVE, BELL, ETC.) YOU MUST INSTALL A JOINT RESTRAINT WITHIN 11" OF THE 90° MAINLINE DIRECTIONAL CHANGE.

PIPE SIZE	BENDS				REDUCERS			DEAD END	
	11°	22°	45°	90°	1 STEP	2 STEP	3 STEP	BLIND	SERV. B.
2"	1'	1'	2'	6'	-	-	-	19"	6'
2.5"	1'	2'	4'	9'	-	-	-	23"	10'
3"	2'	3'	6'	11'	8'	10'	-	30"	15'
4"	2'	4'	9'	20'	14'	20'	31'	45"	25'
6"	3'	6'	13'	29'	30'	40'	53'	63"	40'
8"	4'	8'	15'	38'	33'	55'	63'	75"	70'
10"	5'	9'	19'	45'	36'	66'	75'	96"	90'
12"	5'	10'	21'	53'	38'	60'	83'	112"	110'

CONTACT LOCAL LEEMCO REPRESENTATIVE FOR ALL QUESTIONS CONCERNING LEEMCO PRODUCTS. COORDINATE AN INSTALLATION CLINIC WITH LEEMCO PRIOR TO INSTALLING THE MAINLINE.

D JOINT RESTRAINTS

NTS

PRIME:



AMEC FOSTER WHEELER
ENVIRONMENT & INFRASTRUCTURE
1075 BIG SHANTY ROAD NW,
SUITE 100
KENNESAW, GA 30144
(770) 421-3400
AMEC PROJECT: 6166-15-0011

MEP ENGINEER:

IRRIGATION DESIGNER:



Irrigation
Consultant
Services
2231 Weatherstone Circle
Conyers, GA 30094
(770) 929-0884, fax (770) 760-8025



**NATIONAL
CEMETERY
ADMINISTRATION**

Drawing Title

IRRIGATION
DETAILS

Approved: Director, Technical Support Service

Approved: Chief, Architectual & Engineering Division

Project Title

4000 NICHE COLUMBARIUM
GEORGIA NATIONAL CEMETERY

Building Number

Checked

Drawn

Location

1080 VETERANS CEMETERY RD,
CANTON, GA 30114

Date

23 OCTOBER 2015

Project No.

922CM3005

DRAWING NO.

I-103

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IRRIGATION LEGEND

SYSTEM NOTES:

*NEW IRRIGATION SYSTEM WILL BE CONNECTED TO EXISTING IRRIGATION SYTEM. REFER TO PLANS FOR MORE SPECIFICS ON POINTS OF CONNECTION, POINTS TO CONECTION ONTO AND TO CAP OFF EXISTING IRRIGATION, ETC.

*IRRIGATION INSTALLATION CONTRACTOR SHALL BE RESPONSIBLE TO ENSURE THAT NEW IRRIGATION IS FULLY PROGRAMMED INTO EXISTING CONTROLLER/CENTRAL CONTROL SYSTEM.

2" MANUAL DRAIN VALVE. BRASS BALL VALVE. DETAIL-J.

RAIN BIRD 150-EFB-CP-PRS OR 200-EFB-CP-PRS BRASS ELECTRIC REMOTE CONTROL VALVE, 1 1/2" OR 2" SIZE, MOUNTED WITH LEEMCO LV-212 LATERAL ISOLATION TEE AND WITH PRESSURE REGULATION DEVICES. DETAIL-B.

RAIN BIRD 100-EFB-CP-PRS BRASS ELECTRIC REMOTE CONTROL VALVE, 1" SIZE, MOUNTED WITH LEEMCO LV-212 LATERAL ISOLATION TEE AND WITH PRESSURE REGULATION DEVICES. DETAIL-B.

2" AIR/VACUUM RELIEF VALVE. INSTALLED AT HIGH POINTS OF IRRIGATION MAINLINE LOOP AS NOTED ON IRRIGATION PLANS. DETAIL-L.

RAIN BIRD 1806-SAM-PRS, 6" POP-UP LAWN SPRAY SPRINKLER, 15' RADIUS, FULL-4.0 GPM, HALF-2.0 GPM, QUARTER-1.0 GPM, 30 PSI. DETAIL-M.

RAIN BIRD 1806-SAM-PRS, 6" POP-UP LAWN SPRAY SPRINKLER, 12' RADIUS, FULL-3.0 GPM, HALF-1.5 GPM, QUARTER-0.75 GPM, 30 PSI. DETAIL-M.

RAIN BIRD 1806-SAM-PRS, 6" LAWN SIDE STRIP SPRAY SPRINKLER, 4' X 30' RADIUS, 1.5 GPM, 30 PSI. DETAIL-M.

RAIN BIRD 1806-SAM-PRS, 6" LAWN END STRIP SPRAY SPRINKLER, 4' X 15' RADIUS, 1.0 GPM, 30 PSI. DETAIL-M.

RAIN BIRD 1812-SAM-PRS, 12" HI-POP SHRUB SPRAY SPRINKLER, 5' RADIUS, HALF-0.2 GPM, QUARTER-0.1 GPM, 30 PSI. DETAIL-J.

RAIN BIRD 8005-SS-12, WITH #12 NOZZLE, LARGE TURF CLOSED CASE ROTOR, FULL CIRCLE ARC, 59' RADIUS @ 12.0 GPM, 60 PSI, RUBBER COVER, STAINLESS STEEL RISER, UTILIZE 1" UNITIZED TRIPLE SWING JOINTS, DETAIL-K.

RAIN BIRD 8005-SS-12, WITH #12 NOZZLE, LARGE TURF CLOSED CASE ROTOR, PART CIRCLE ARC, 59' RADIUS @ 20.0 GPM, 60 PSI, RUBBER COVER, STAINLESS STEEL RISER, UTILIZE 1" UNITIZED TRIPLE TOP SWING JOINTS, DETAIL-K.

RAIN BIRD 8005-SS-16, WITH #16 NOZZLE, LARGE TURF CLOSED CASE ROTOR, FULL CIRCLE ARC, 65' RADIUS @ 15.9 GPM, 60 PSI, RUBBER COVER, STAINLESS STEEL RISER, UTILIZE 1" UNITIZED TRIPLE TOP SWING JOINTS, DETAIL-K.

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RAIN BIRD #5 QUICK COUPLING VALVE 1" SIZE. CONTRACTOR TO SUPPLY TWO QCV KEYS AND MATCHING HOSE SWIVELS. DETAIL-C.

MAINLINE ISOLATION GATE VALVE, DOMESTIC DUCTILE IRON GASKETED, DETAIL-A.

MAINLINE PIPE:

1-1/2" AND SMALLER MAINLINE SHALL BE SCH 40 PVC (SOLVENT WELD) UTILIZING SCH 40 PVC SOLVENT WELD FITTINGS. 3" AND LARGER MAINLINE SHALL BE GASKETED CLASS 200 PVC UTILIZING DUCTILE IRON LEEMCO FITTINGS AND LEEMCO RESTRAINTS.

IRRIGATION SLEEVE: C900 PVC (UNLESS NOTED OTHERWISE), SIZE NOTED ON PLAN. DETAIL-G.

LATERAL LINE PIPE: SCH 40 PVC (SOLVENT WELD), SIZE NOTED.

TYPICAL VALVE INDICATOR

28.5
10
1 1/2
GALLONS PER MIN.
STATION NUMBER
VALVE SIZE

NOTES:

1. ALL SPRINKLERS WILL BE MOUNTED ON UNITIZED SWING JOINTS (TRIPLE TOP).
2. CONTRACTOR TO UTILIZE A AUTOMATIC DRAIN CHECK VALVE DEVICE FOR ALL SPRINKLERS.
3. ALL PIPING AND WIRING UNDER HARDTOPS WILL BE IN CLASS SCH 40 PVC PIPE SLEEVE.
4. IRRIGATION CONTRACTOR MUST STAKE ALL PROPOSED TRENCHLINES IN GRAVESITE AREAS FOR REVIEW AND APPROVAL BY OWNER'S REPRESENTATIVE BEFORE ANY TRENCHING ACTIVITIES OCCUR.
5. IRRIGATION CONTRACTOR WILL BE RESPONSIBLE TO SETUP MANUFACTURER'S TRAINING (I.E. RAIN BIRD) FOR OPERATION AND MAINTENANCE OF THE COMPLETE IRRIGATION SYSTEM, INCLUDING CENTRAL CONTROL, TO AT LEAST FOUR NCA EMPLOYEES.
6. IRRIGATION CONTRACTOR WILL BE RESPONSIBLE TO REPLACE AND/OR REPAIR ANY EXISTING IRRIGATION EQUIPMENT DAMAGED DURING NEW CONSTRUCTION.

FOR MAINLINE 4" AND LARGER

NOMINAL PIPE SIZE (INCHES)	MINIMUM CASING SLEEVE SIZE (INCHES)
3	12.0
4	14.0
6	16.0
8	20.0
10	24.0

WATER PROOF CONNECTION
3M DBR/Y-6 (600 VOLT)
ID TAG
PRESURE REGULATOR WITH
SOLENOID

FINISH GRADE
REMOTE CONTROL VALVE
BRASS TYPE WITH PRESSURE
REGULATION DEVICE
BRASS BALL VALVE

PLASTIC VALVE BOX
SUPER JUMBO SIZE
(RECTANGULAR - GREEN COLOR)
PVC SCH. 80 NIPPLE
(LENGTH AS REQUIRED)

LEEMCO LV-212 DUCTILE IRON LATERAL
ISOLATION VALVE

FILTER FABRIC
FULL BRICKS (CONTINUOUS END TO
END AROUND BOTTOM OF
VALVE BOX).

PVC MAINLINE

LEEMCO DUCTILE IRON TEE RESTRAINT

PVC SCH. 80 UNION

PVC SCH. 80 CLOSE NIPPLE


PVC SCH. 80 UNION

12-INCH MINIMUM DEPTH OF
3/4-INCH WASHED GRAVEL

PVC SCH. 40 MALE ADAPTER

NOTE:

UTILIZE LEEMCO DUCTILE IRON SADDLE
AND LEEMCO LV212 ANGLE VALVE FOR
REMOTE CONTROL VALVE CONNECTION
ONTO MAINLINE AND ISOLATION, RATHER
THAN PVC CONNECTION/BALL VALVE
SHOWN.

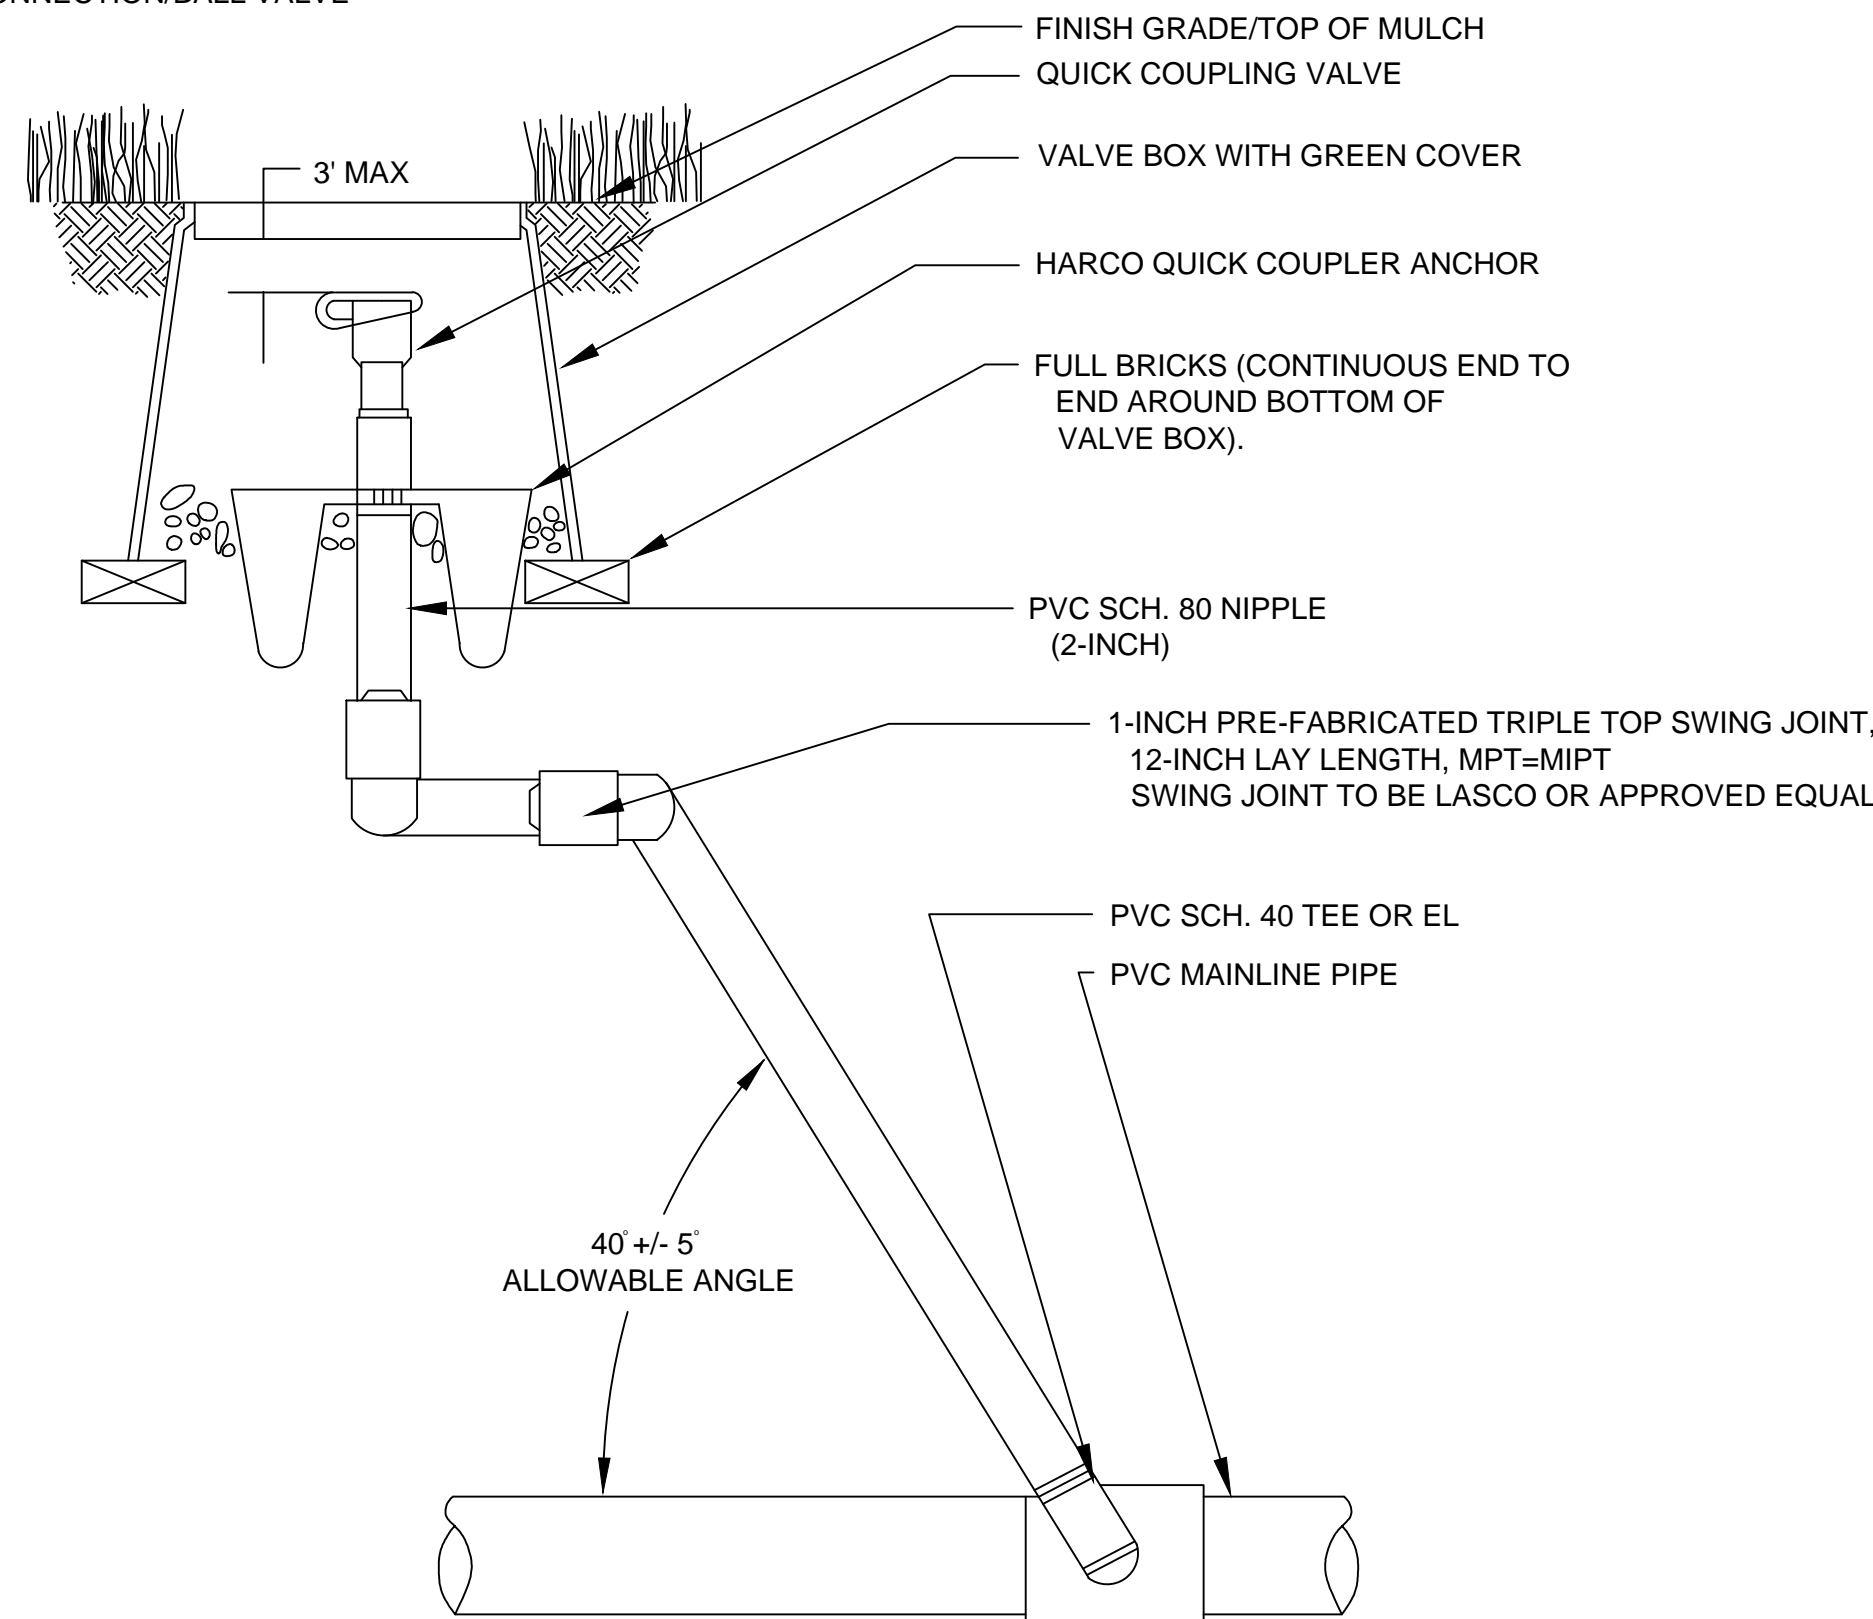


NOTES:

1. FURNISH FITTINGS AND PIPING NOMINALLY SIZED IDENTICAL TO NOMINAL QUICK COUPLING VALVE INLET SIZE.

C QUICK COUPLING VALVE

NTS

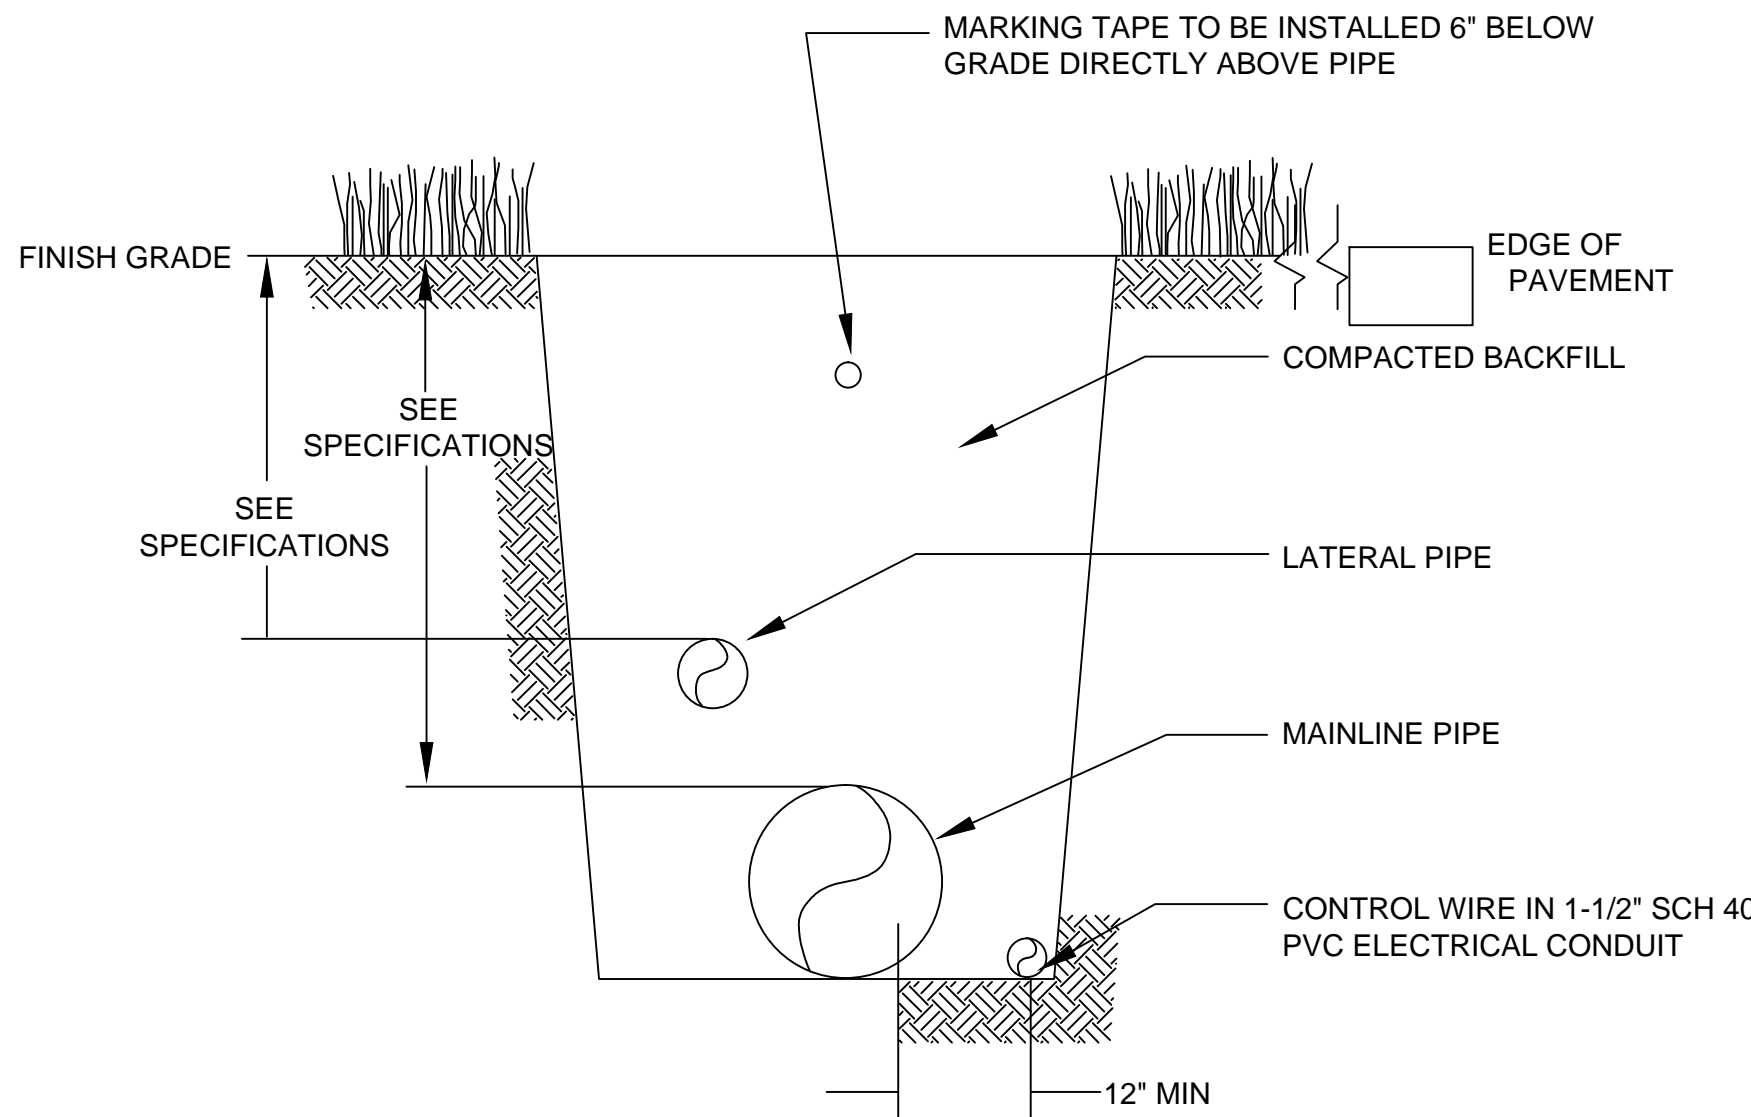


E TRENCHING


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NOTES:

1. INSTALLER OF SLEEVES SHALL BE RESPONSIBLE TO LOCATE SLEEVES IF NOT PROPERLY INSTALLED.
2. ALL IRRIGATION SLEEVES NOT BEING USED DURING EACH PHASE OF CONSTRUCTION SHALL HAVE MARKER PIPES AT EACH END OF SLEEVE LOWERED BELOW GROUND LEVEL WITH 10" ROUND VALVE BOX INSTALLED ABOVE EACH MARKER PIPE.

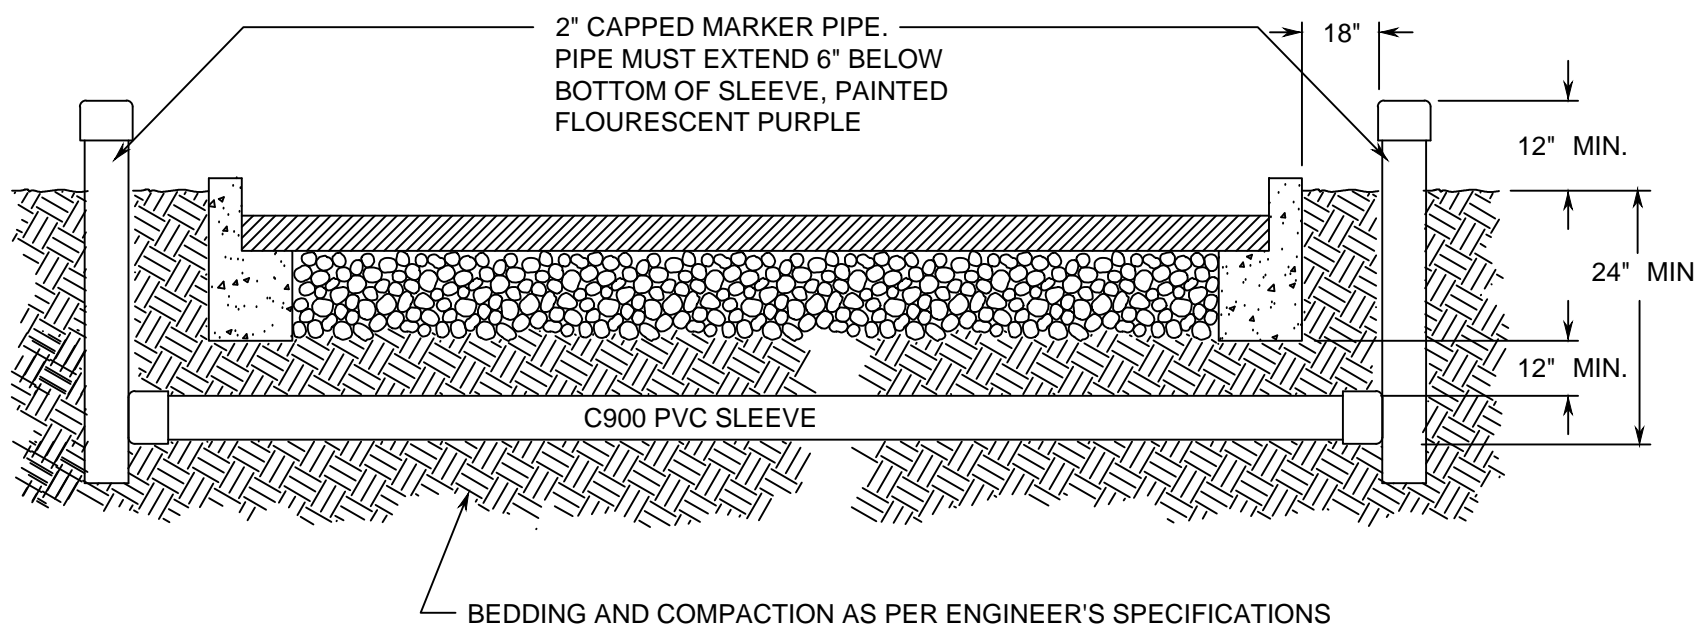


BEDDING AND COMPACTION AS PER ENGINEER'S SPECIFICATIONS

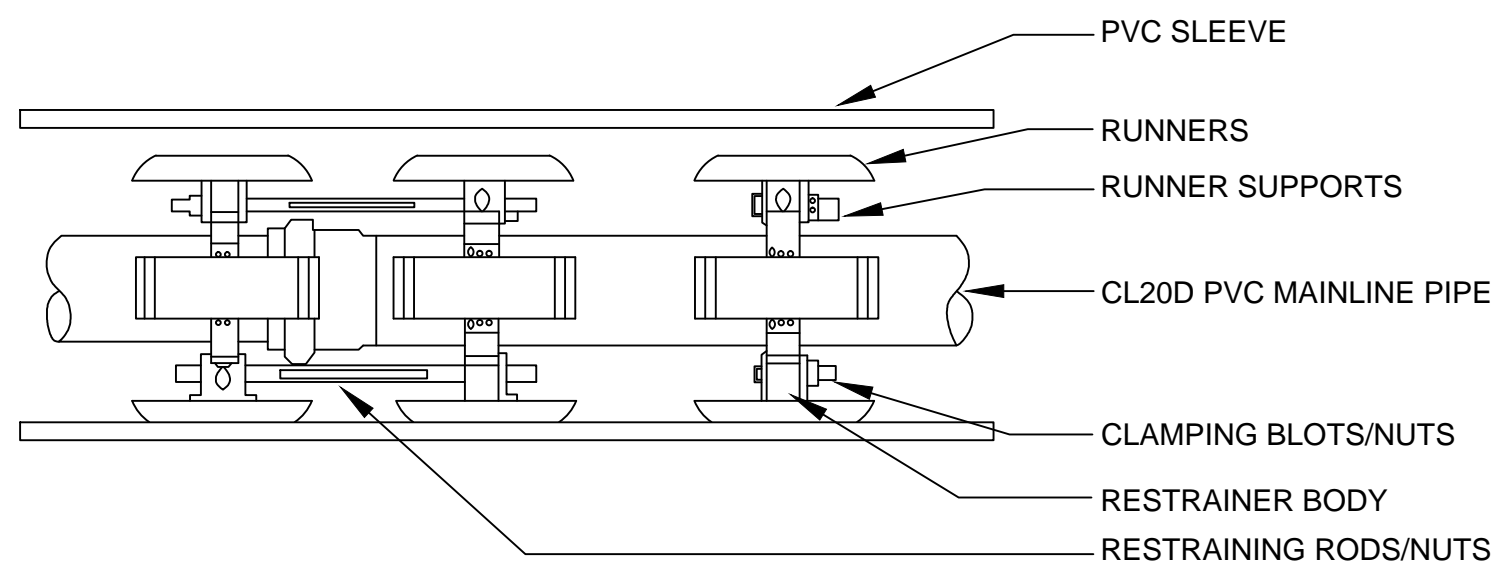

NOTES:


1. PROVIDE RESTRAINED CASING SPACERS AT ALL PIPE BELL JOINTS AND NO MORE THAN 10' APART PER CASING SPACER MANUFACTURER'S RECOMMENDATION.
2. BLOW SAND IN ENDS OF SLEEVE TO SEAL SLEEVE ENDS.

F SLEEVING

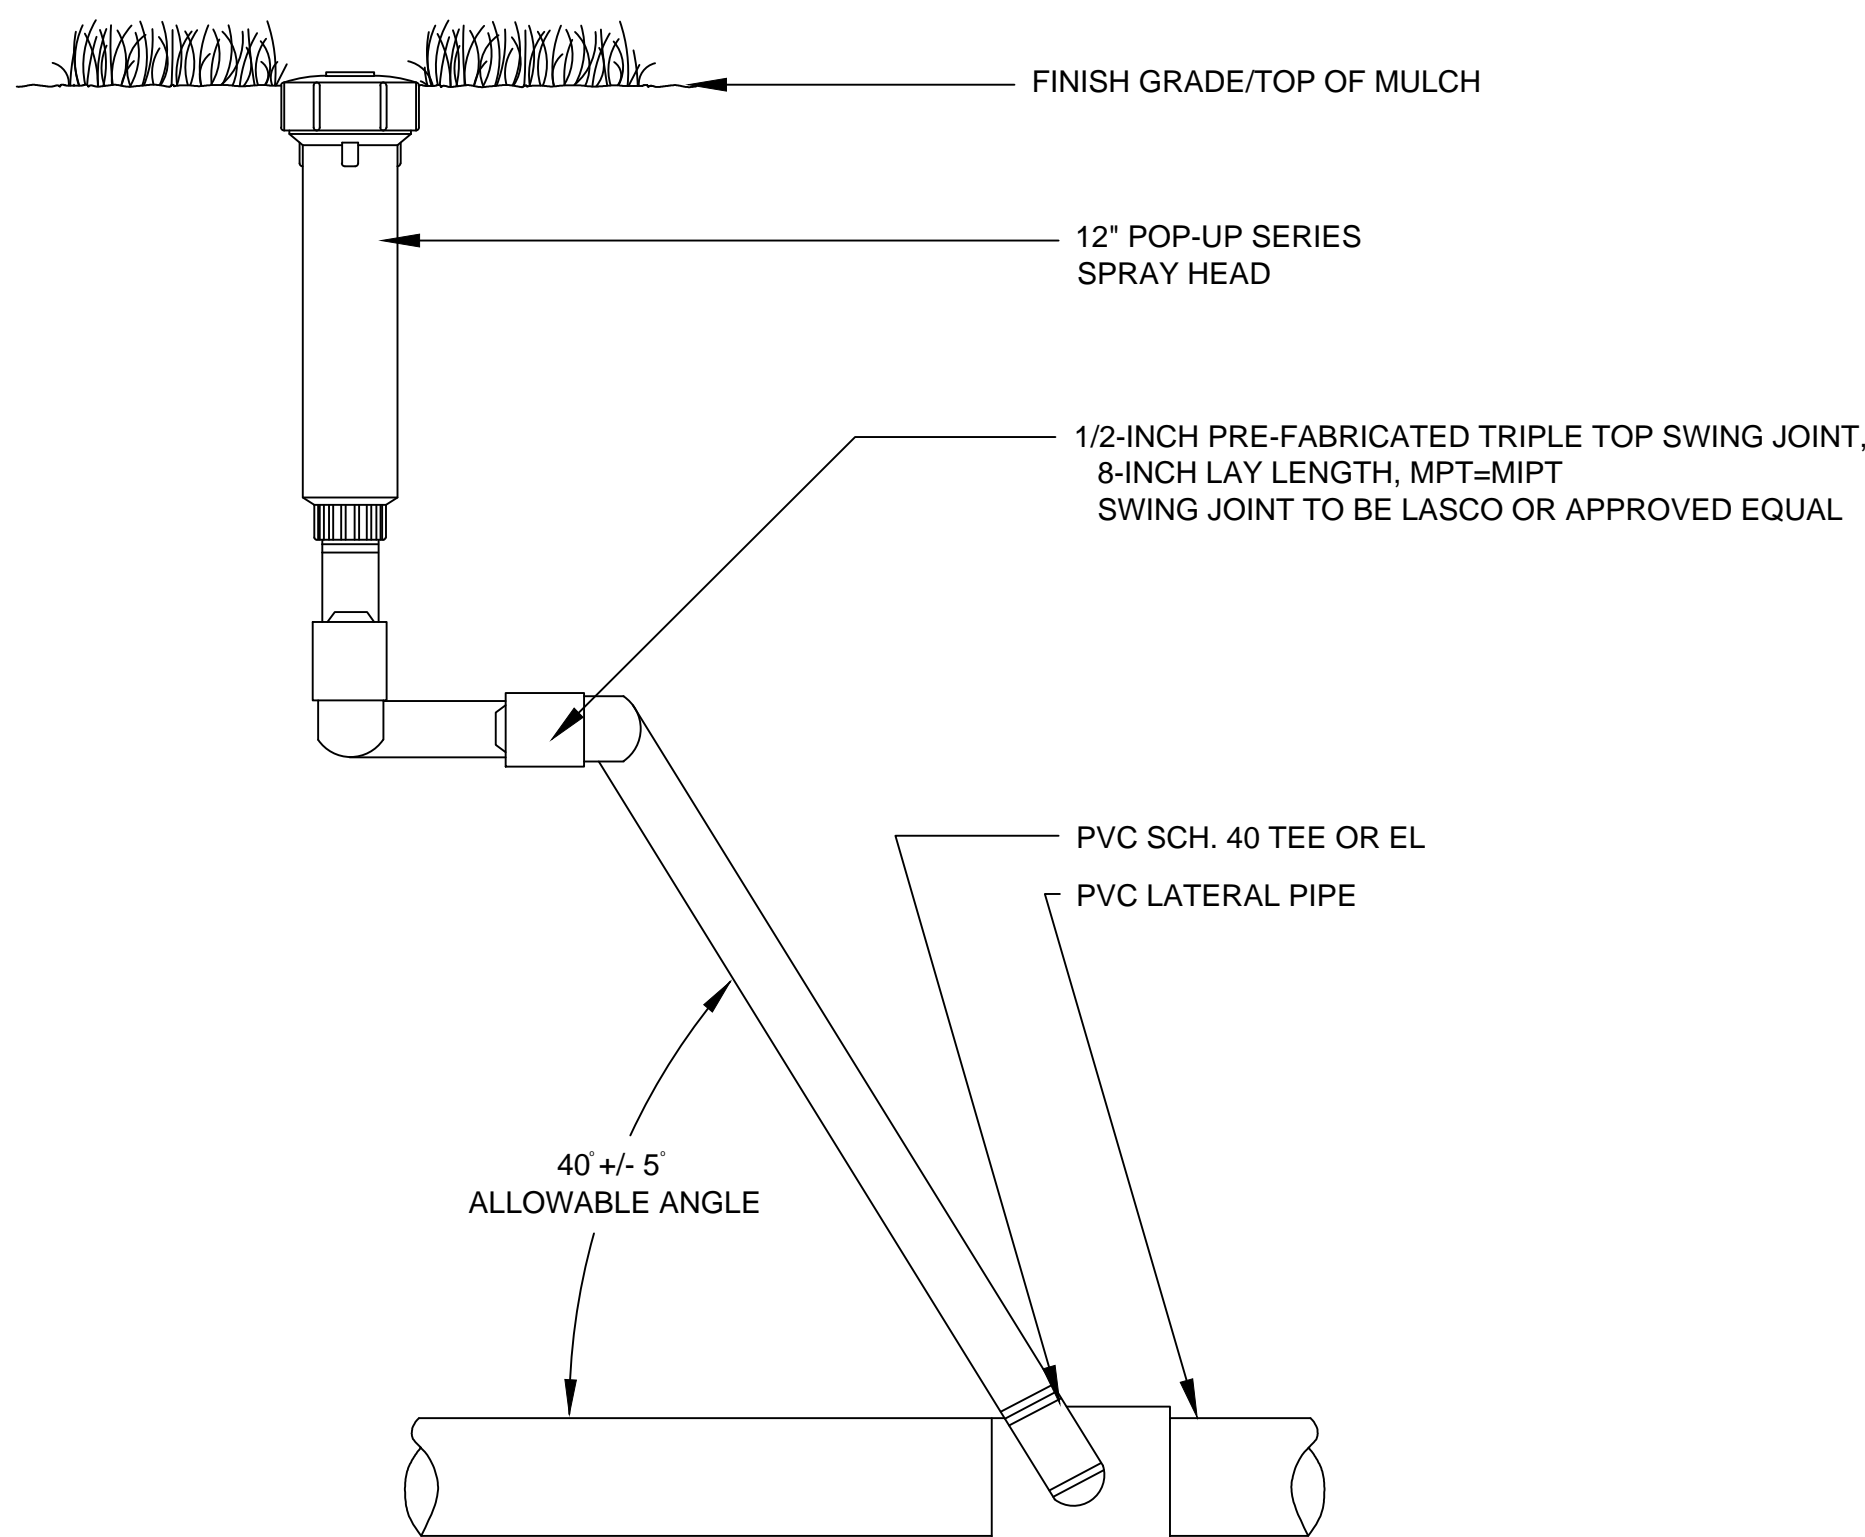


NOTES:
1. INSTALL SWING JOINT LAY ARM BETWEEN 30° AND 45° OF LATERAL PIPE IN ORDER TO ABSORB DOWNWARD IMPACT. IF SWING JOINT CAN NOT BE INSTALLED AT SPECIFIED ANGLE. CONSULT RESIDENT ENGINEER PRIOR TO INSTALLATION OF SWING JOINT.

G SHRUB SPRAY HEAD

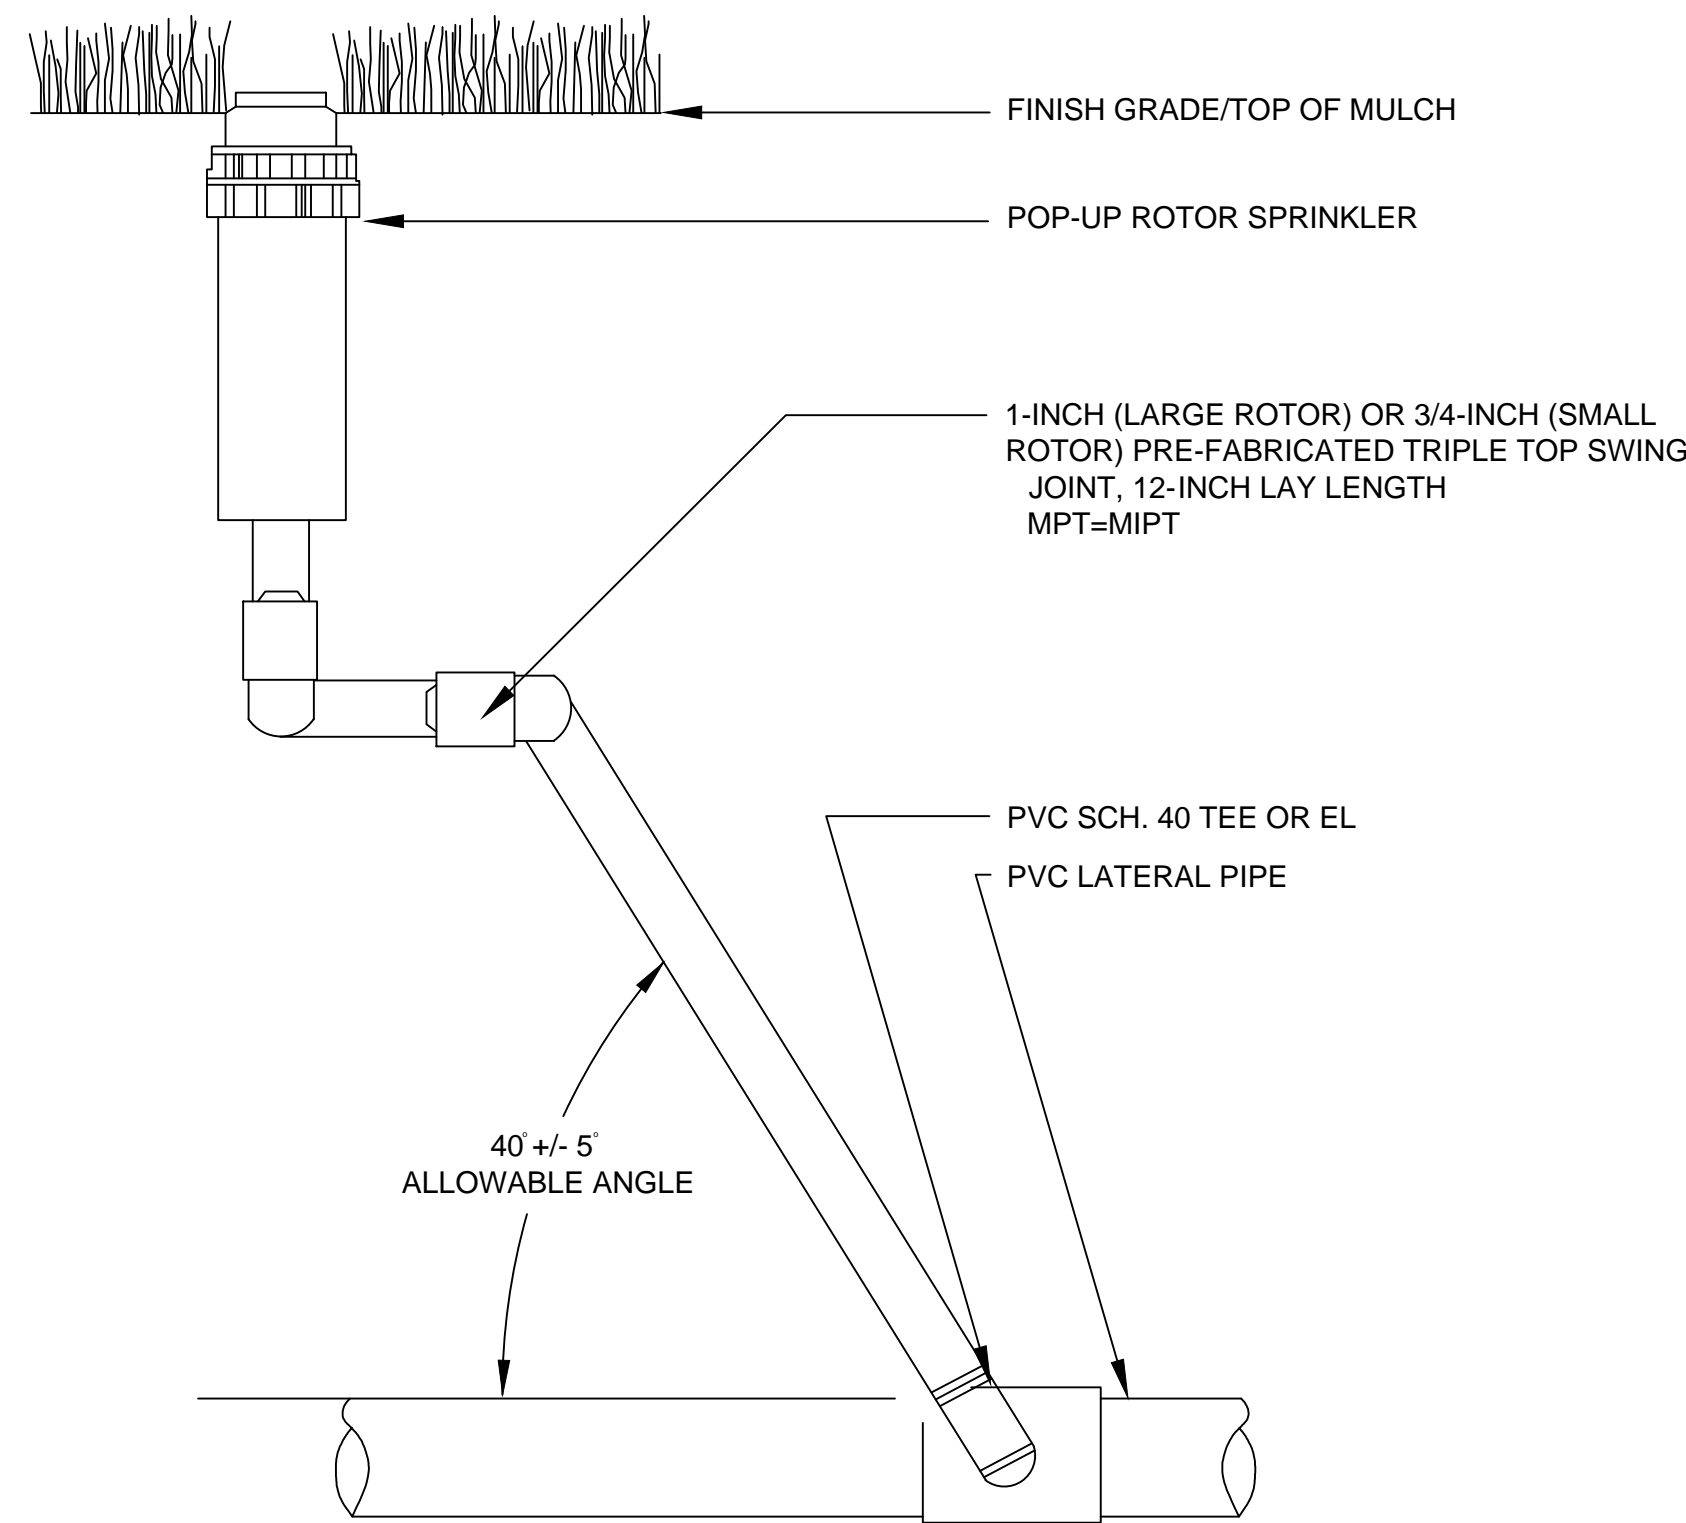


NOTES:
1. INSTALL SWING JOINT LAY ARM BETWEEN 30° AND 45° OF LATERAL PIPE IN ORDER TO ABSORB DOWNWARD IMPACT. IF SWING JOINT CAN NOT BE INSTALLED AT SPECIFIED ANGLE. CONSULT RESIDENT ENGINEER PRIOR TO INSTALLATION OF SWING JOINT.


K TURF ROTOR

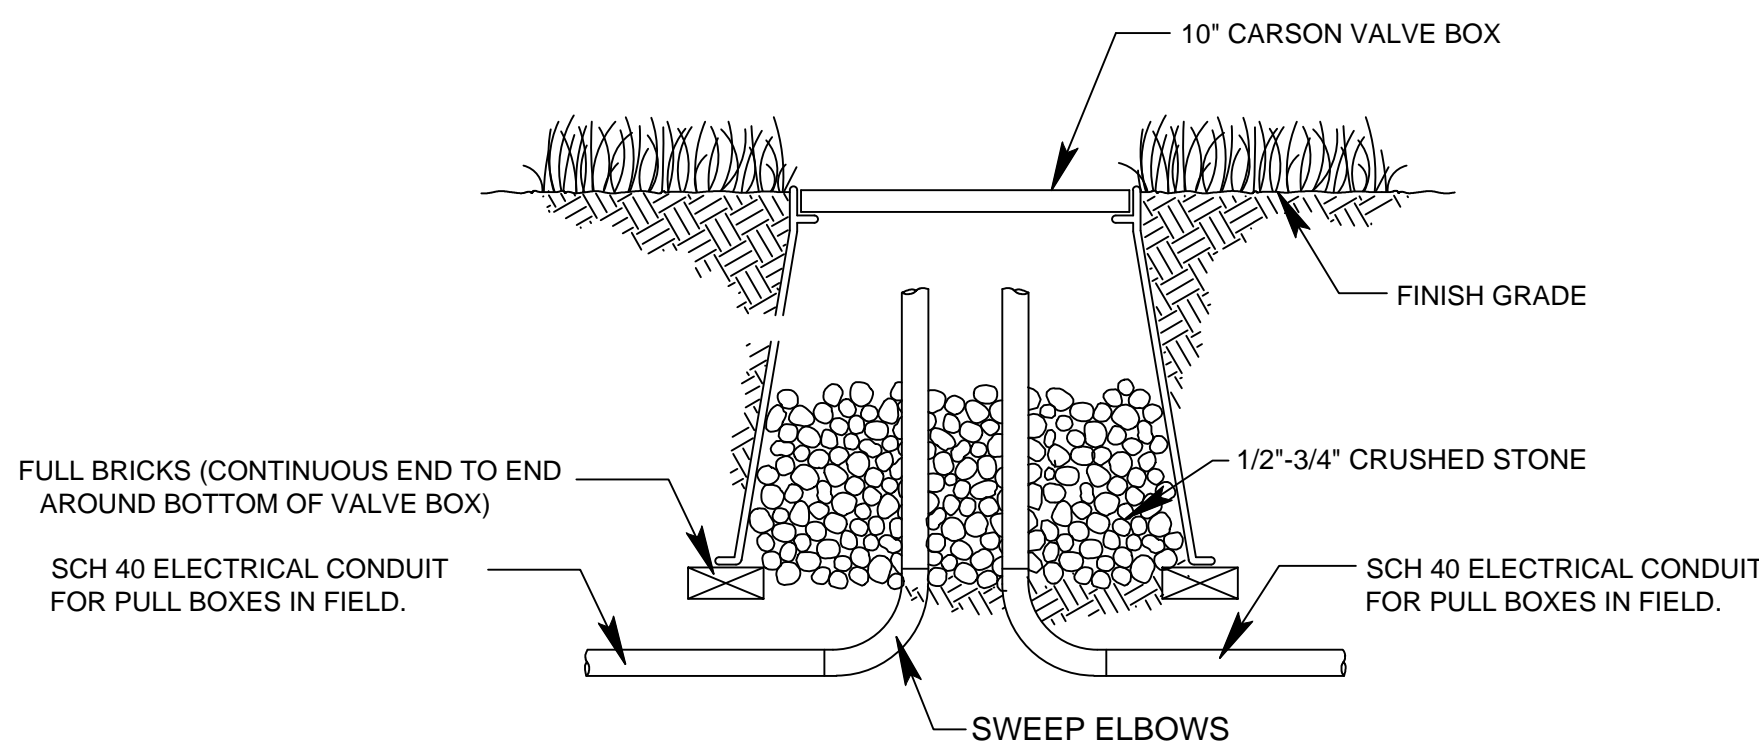


H CONDUIT PULL BOX

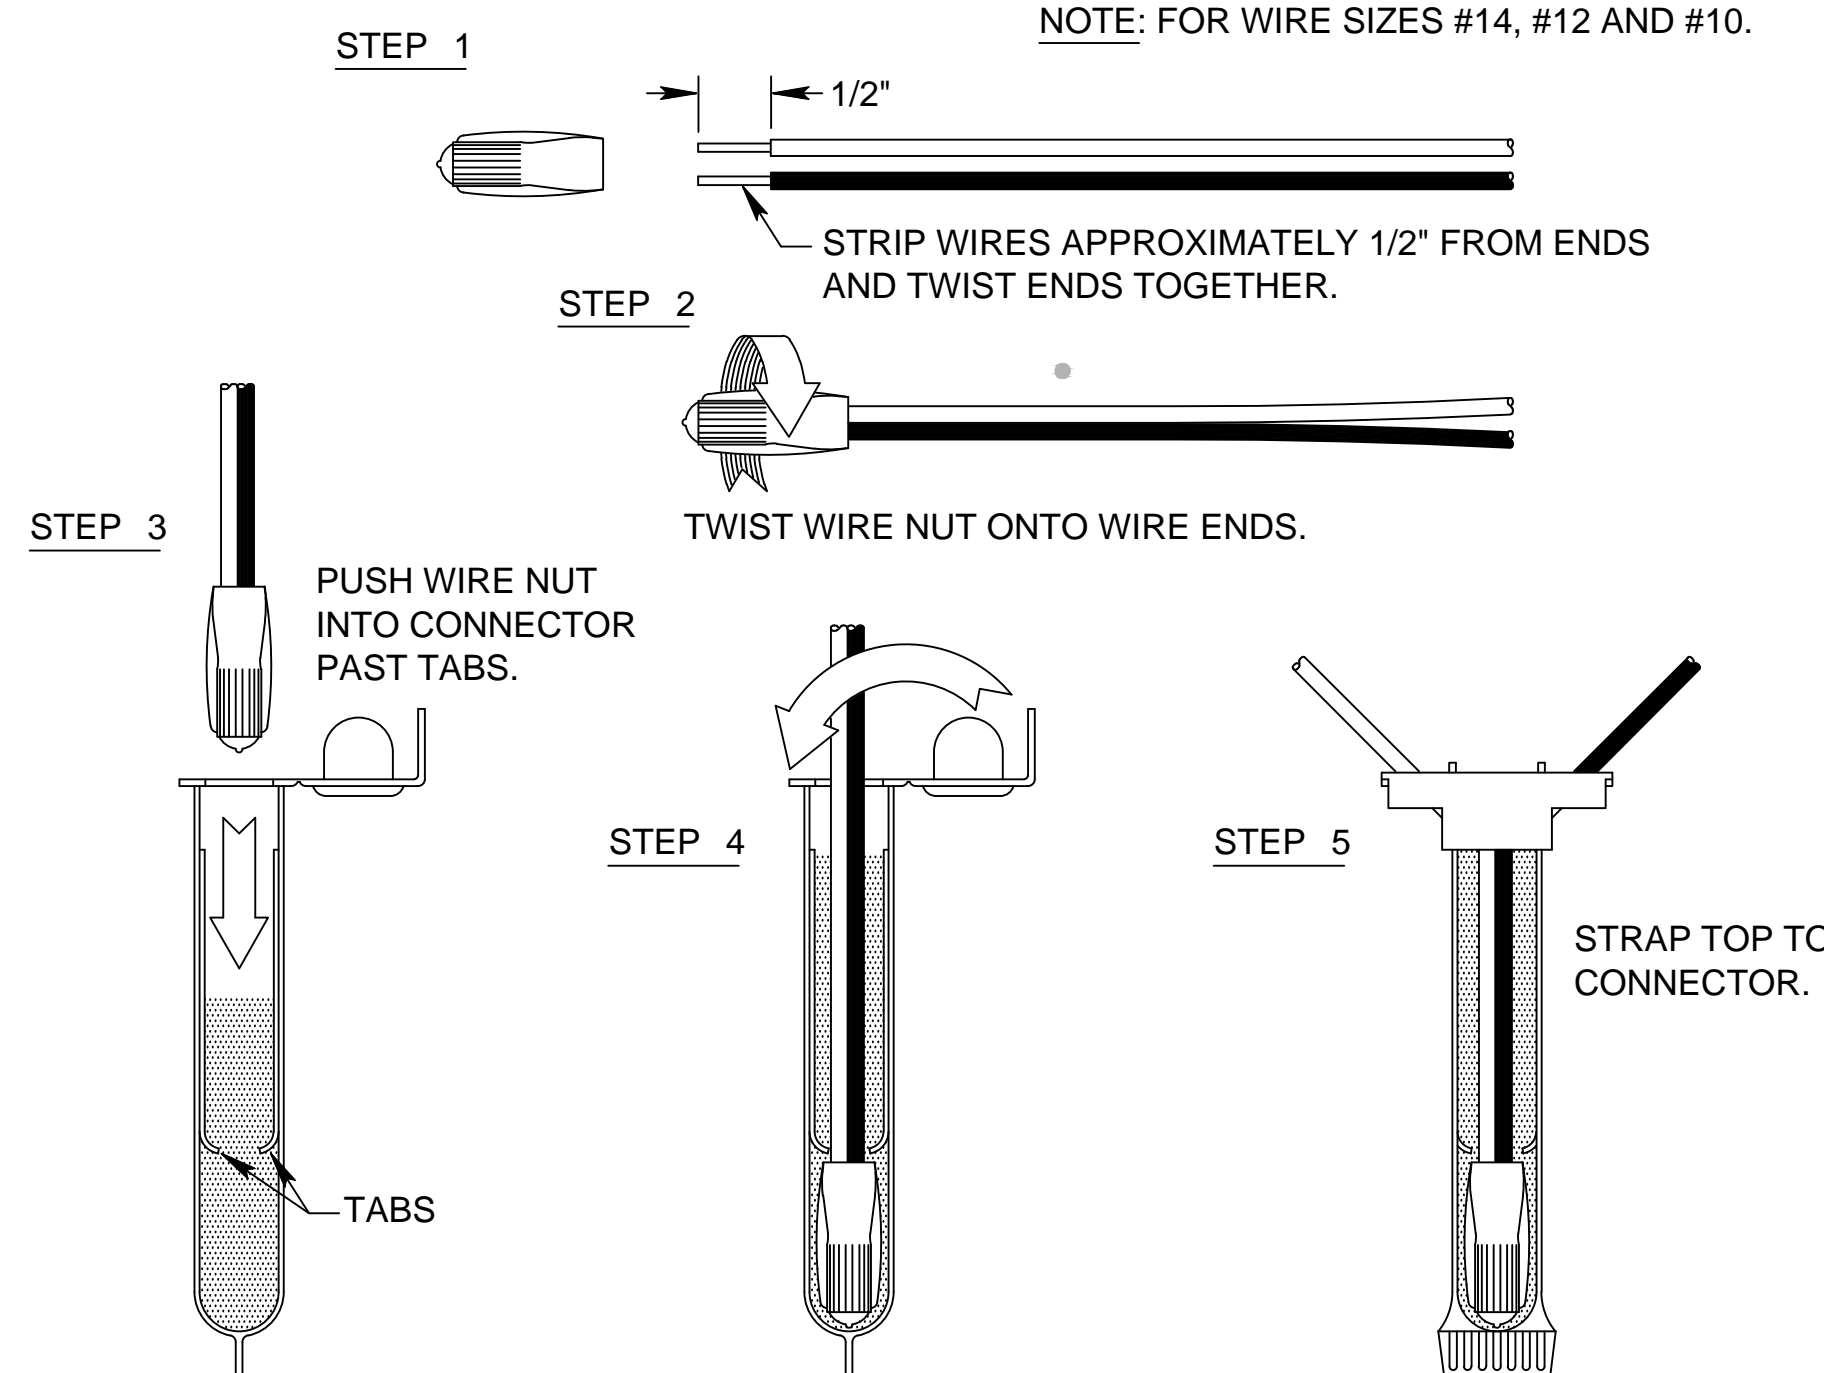

I WIRE SPLICES 3M DBR/Y-6

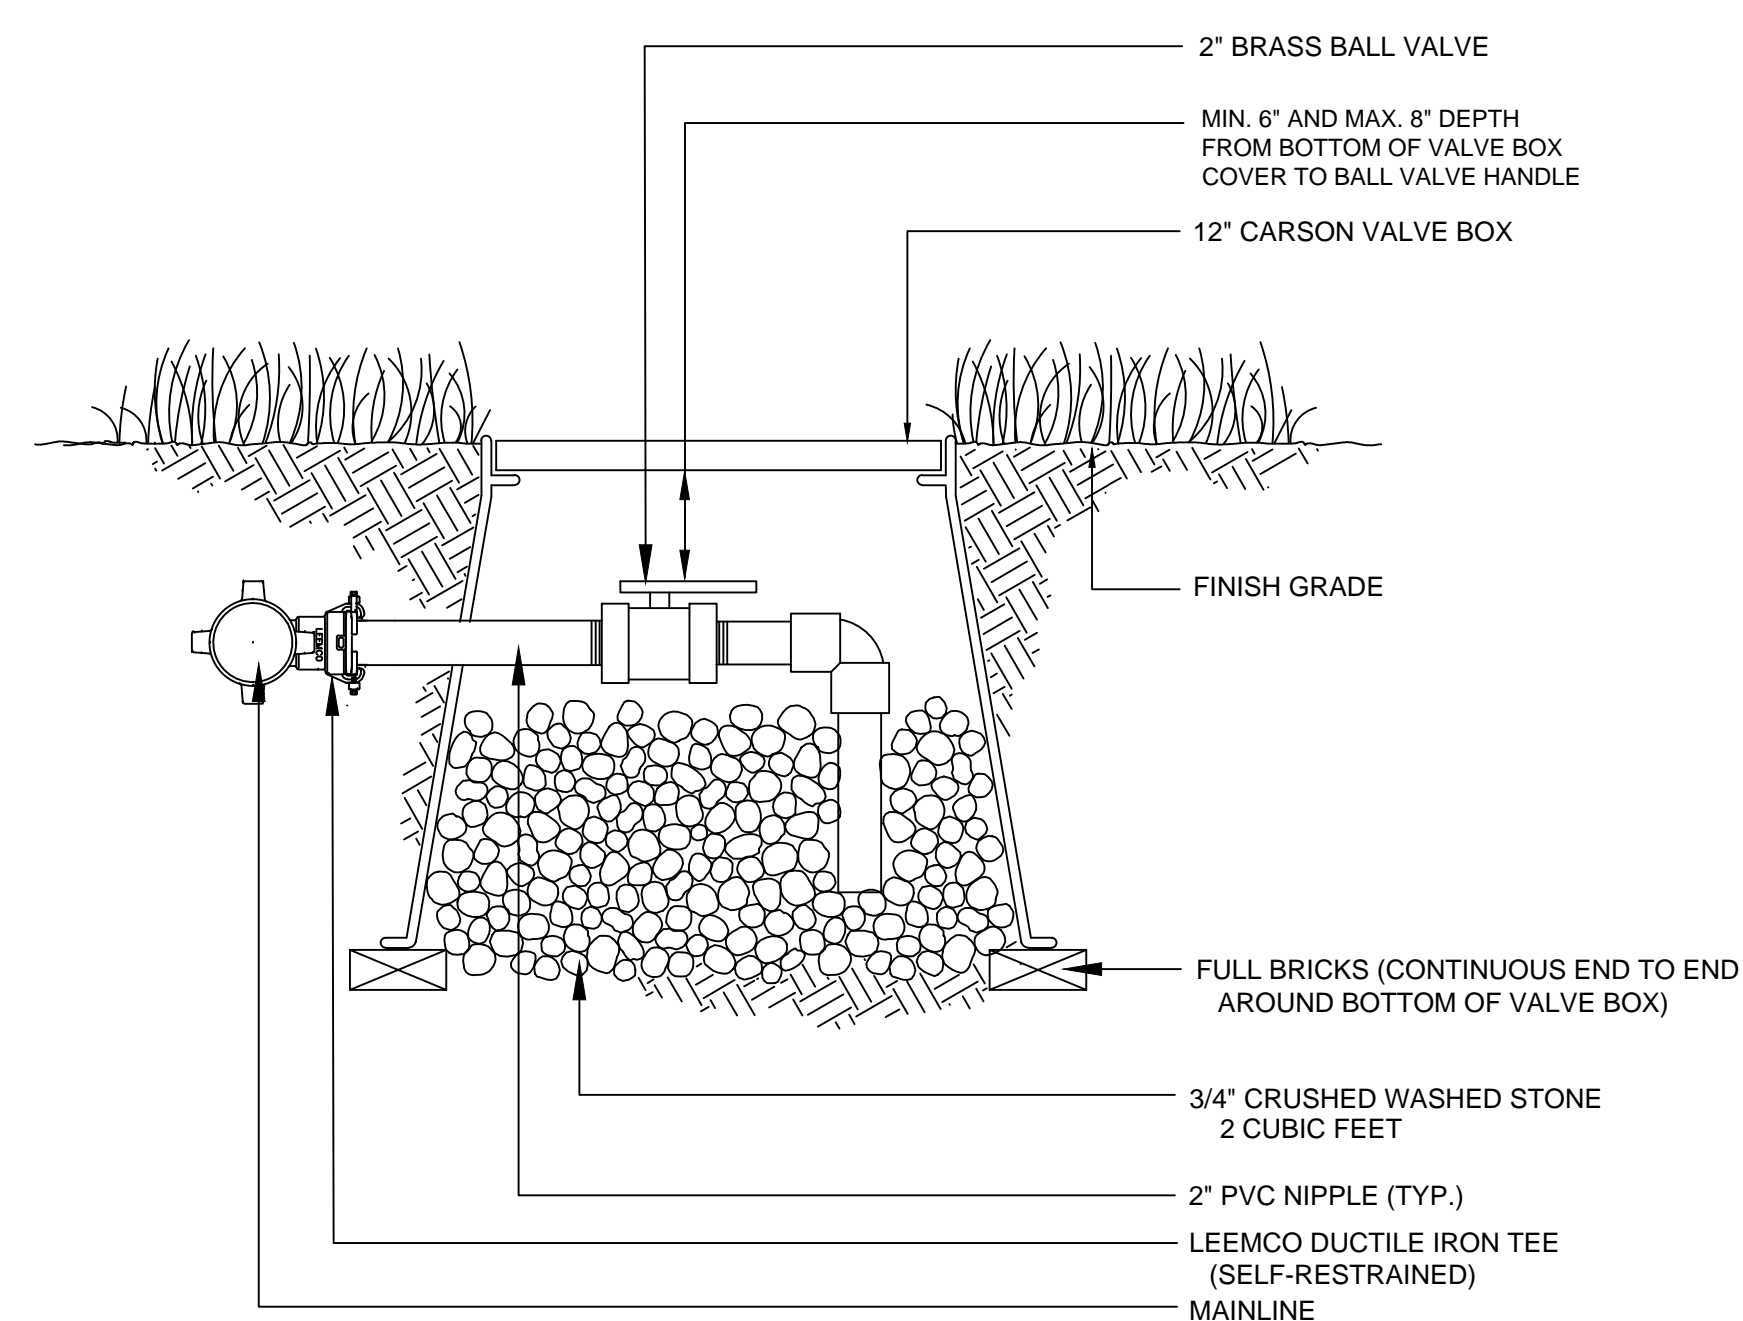


J MANUAL DRAIN VALVE

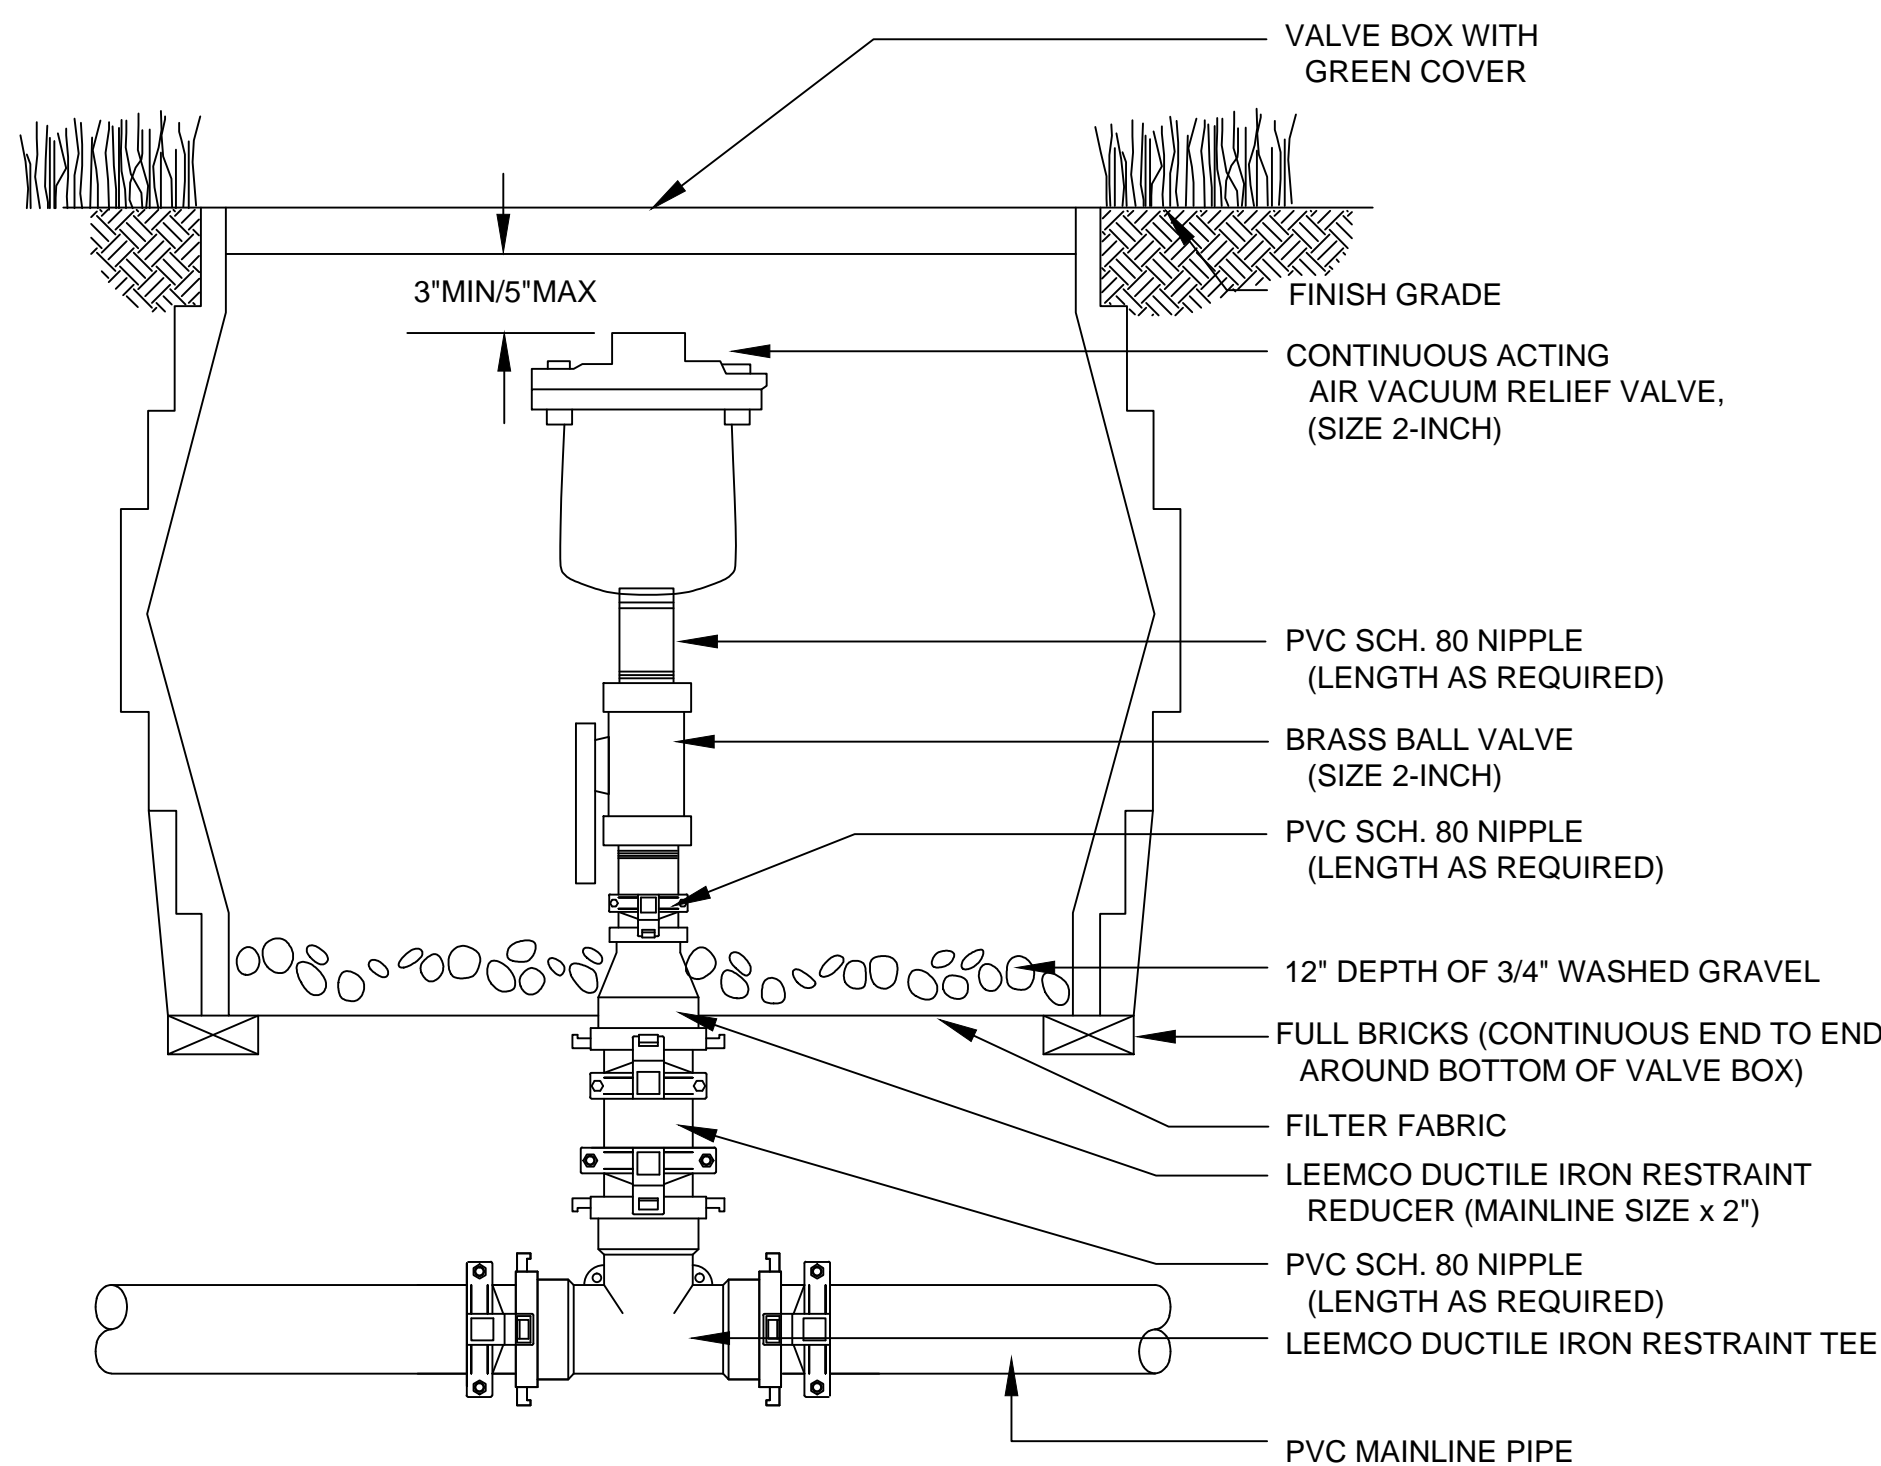

NOTES:
1. INSTALL VALVE BOX SO THERE IS A CLEARANCE OF 2" BETWEEN THE BOTTOM OF THE VALVE BOX AND THE MAINLINE PIPE.
2. INSTALL FILTER FABRIC AROUND EXTERIOR OF VALVE BOX. USE DUCT TAP TO SECURE FABRIC TO PIPE AND VALVE BOX.
3. LABEL VALVE BOX COVER PER SPECIFICATIONS.


L AIR-VACUUM RELIEF VALVE

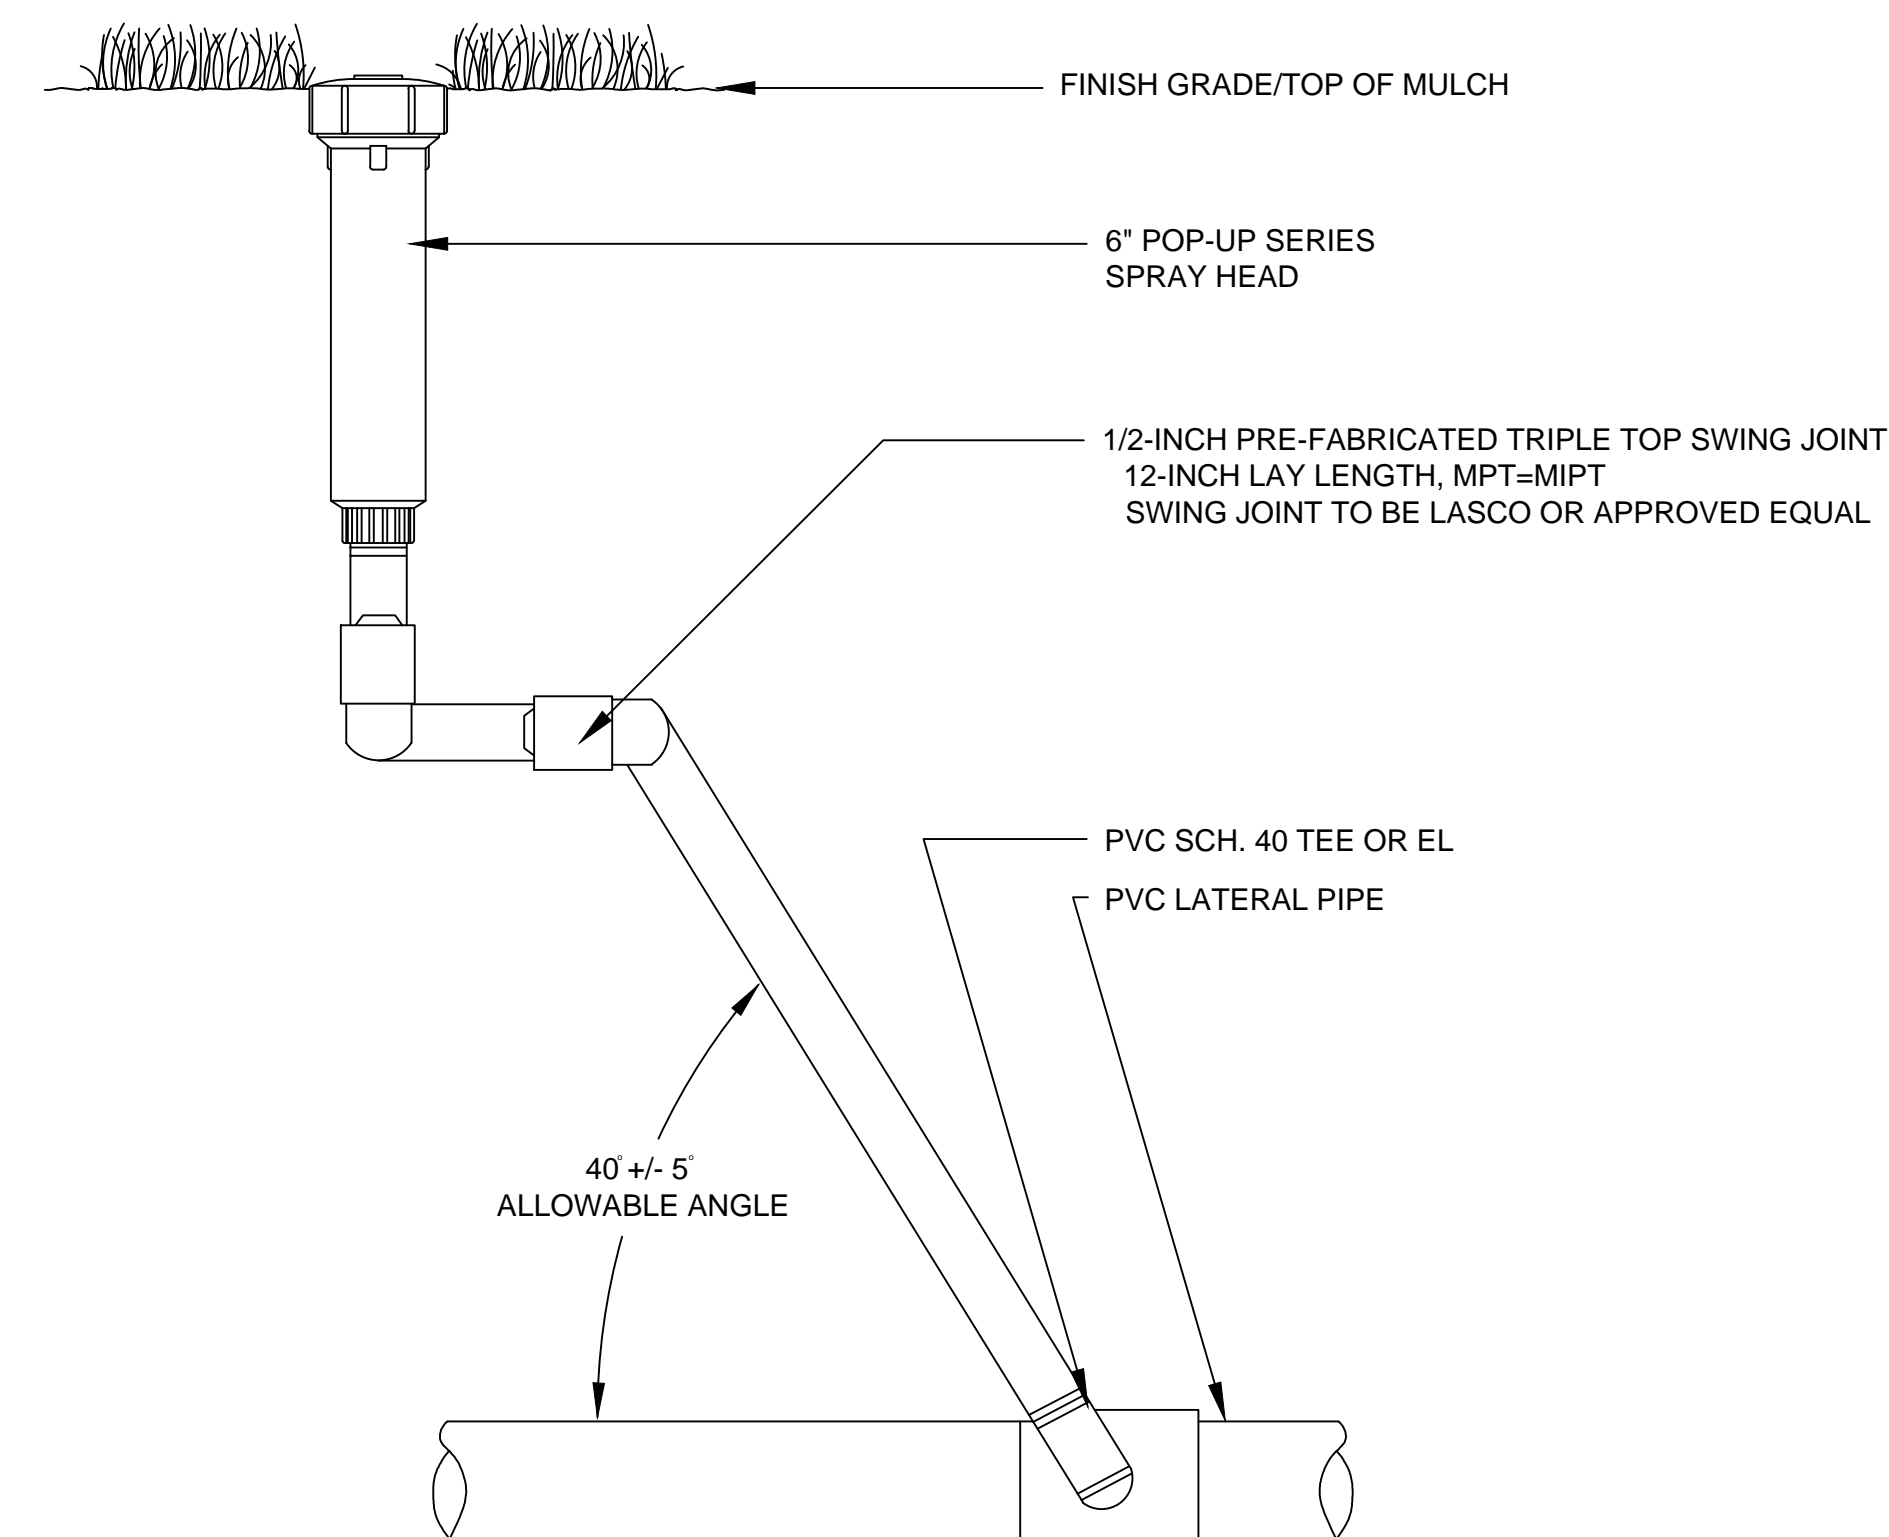


NOTES:
1. INSTALL SWING JOINT LAY ARM BETWEEN 30° AND 45° OF LATERAL PIPE IN ORDER TO ABSORB DOWNWARD IMPACT. IF SWING JOINT CAN NOT BE INSTALLED AT SPECIFIED ANGLE. CONSULT RESIDENT ENGINEER PRIOR TO INSTALLATION OF SWING JOINT.


M LAWN SPRAY HEAD

BID DOCUMENTS


Revisions	Date	<div><div><div>AMEC FOSTER WHEELER ENVIRONMENT & INFRASTRUCTURE 1075 BIG SHANTY ROAD NW, SUITE 100 KENNESAW, GA. 30144 (770) 421-3400 AMEC PROJECT: 6166-15-0011</div></div></div>	<div><div>MEP ENGINEER:</div></div>	<div></div>	<div><div>IRRIGATION DESIGNER:</div><div><div>2231 Weatherstone Circle Conyers, GA 30094 (770) 929-0884, fax (770) 760-8025</div></div></div>	<div><div><div>NATIONAL CEMETERY ADMINISTRATION</div></div></div>	Drawing Title		Project Title		Date	
							IRRIGATION DETAILS		4000 NICHE COLUMBARIUM GEORGIA NATIONAL CEMETERY		23 OCTOBER 2015	
							Approved: Director, Technical Support Service		Building Number	Checked	Drawn	Project No. 922CM3005
							Approved: Chief, Architectual & Engineering Division		Location 1080 VETERANS CEMETERY RD, CANTON, GA 30114		DRAWING NO. I-104 Sheet 30 Of 31	

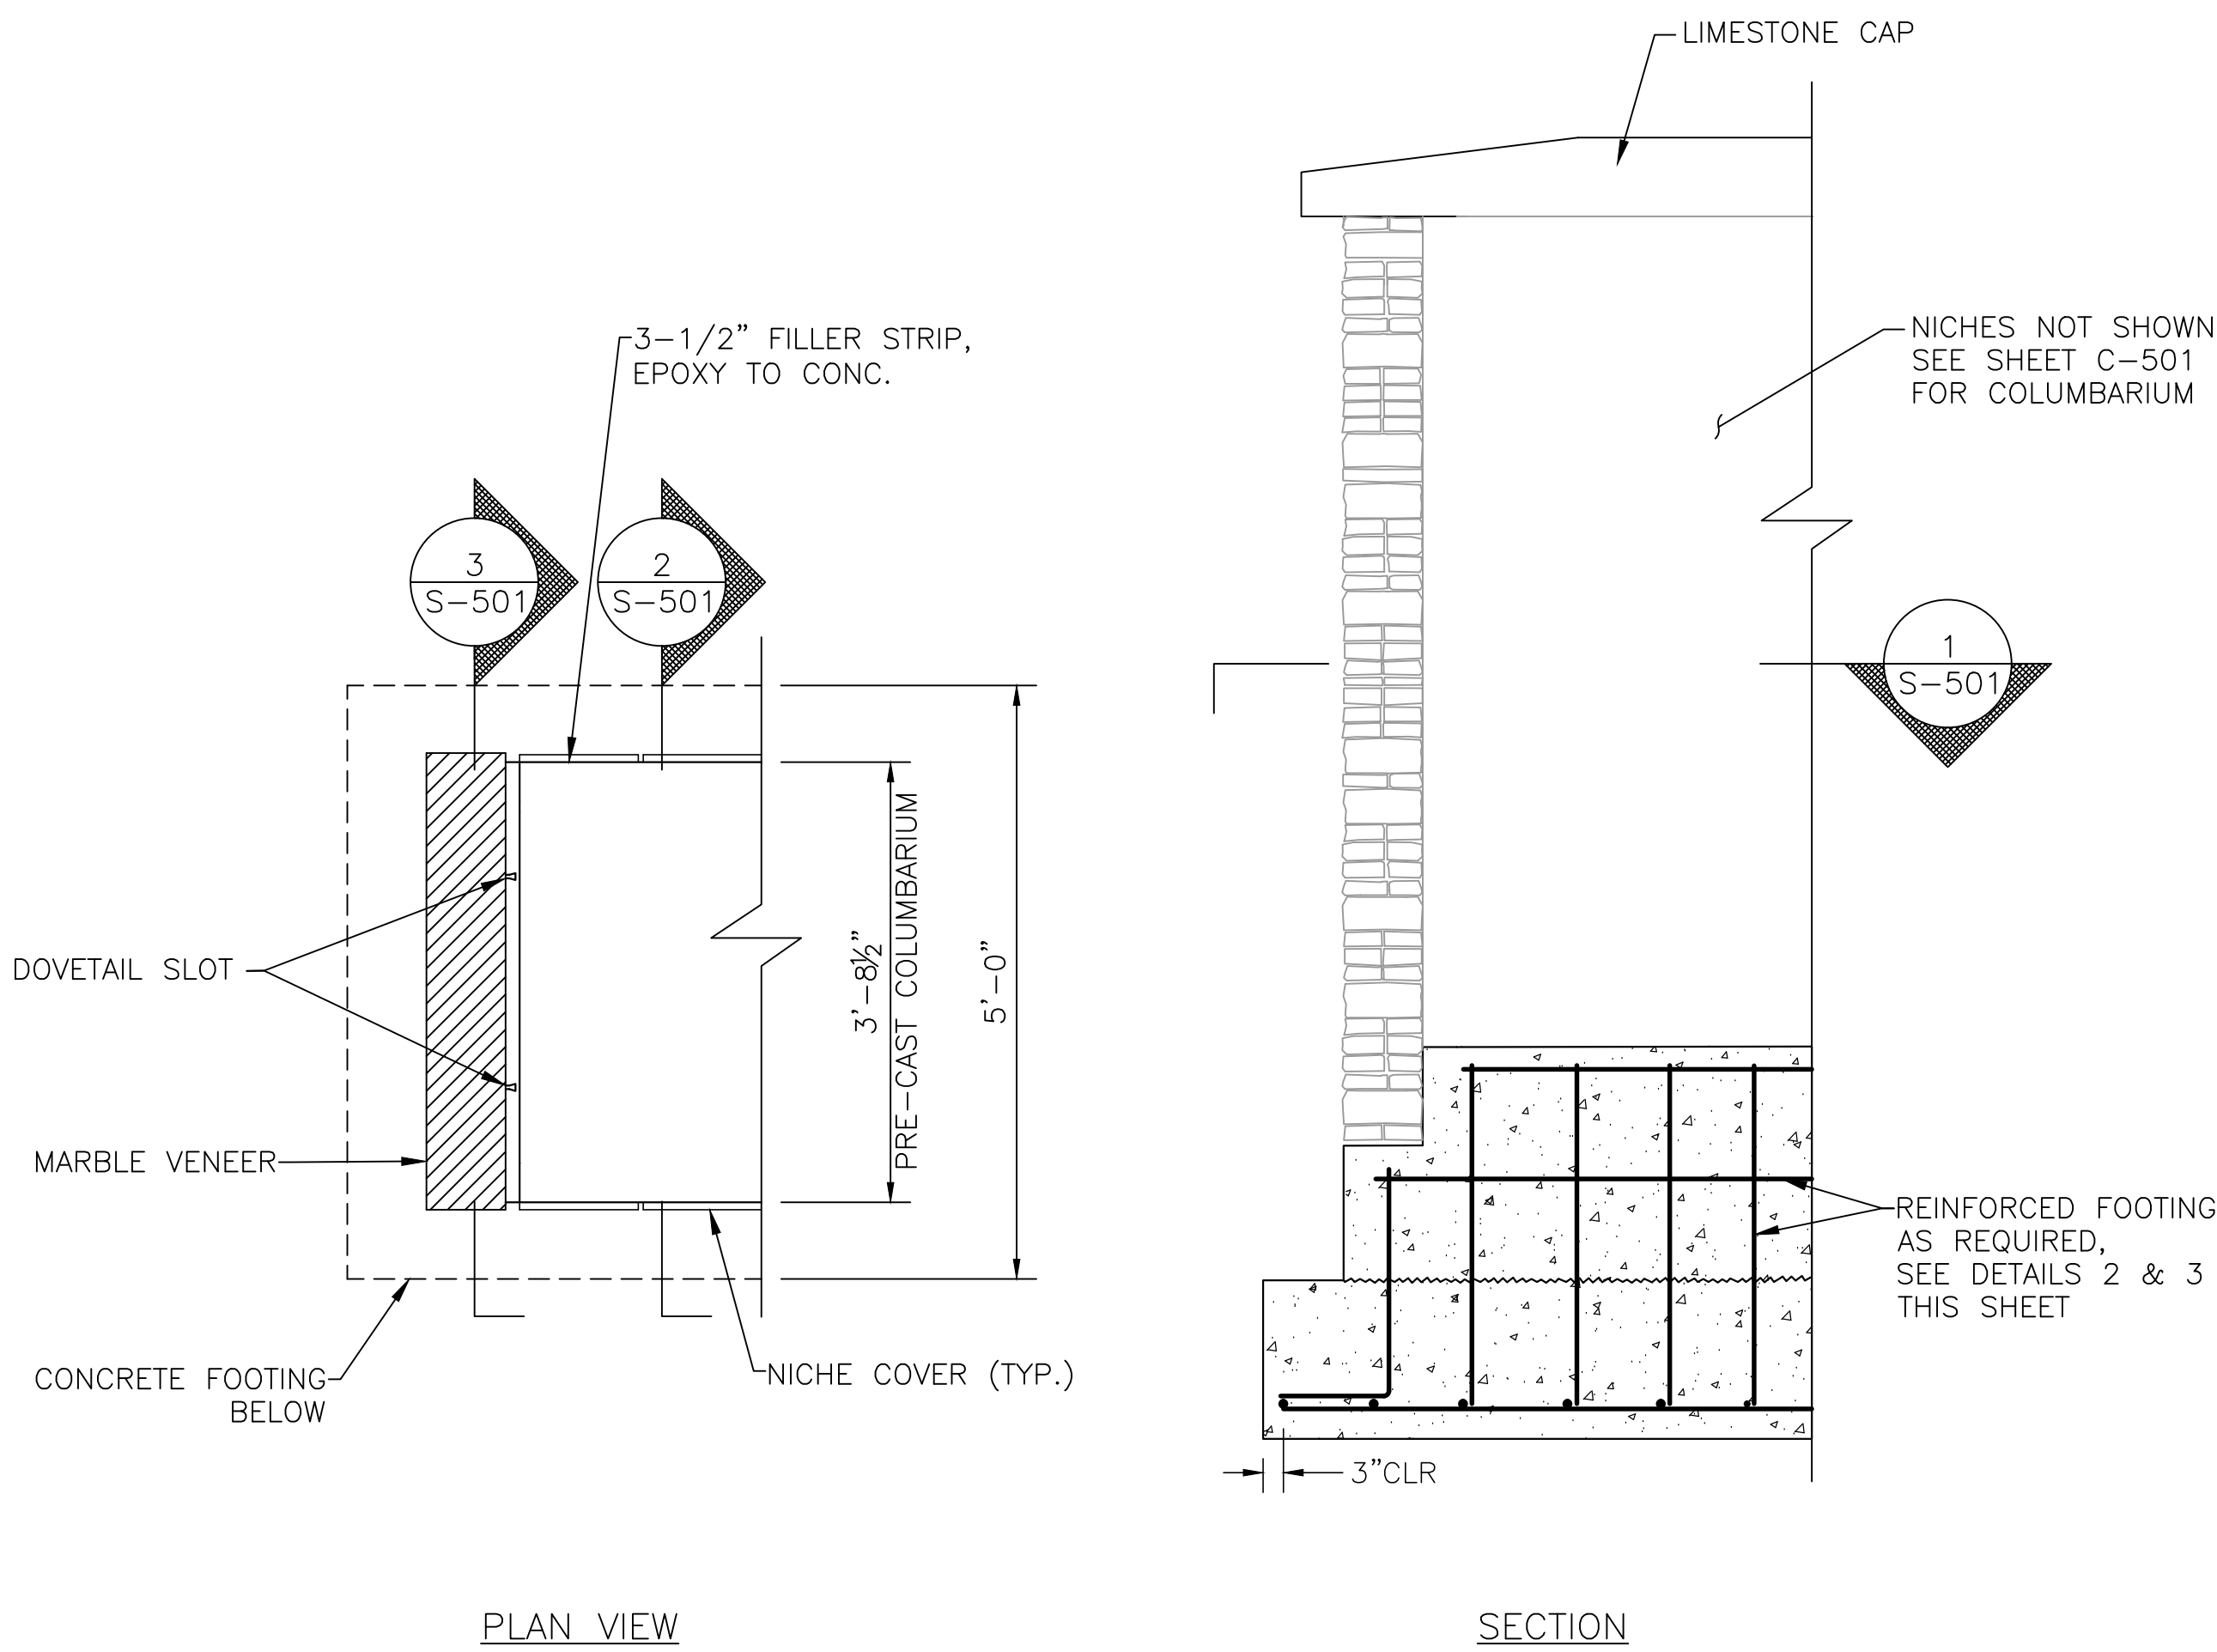

1 COLUMBARIUM FOOTING PLAN & ELEV. SECTION
N.T.S.

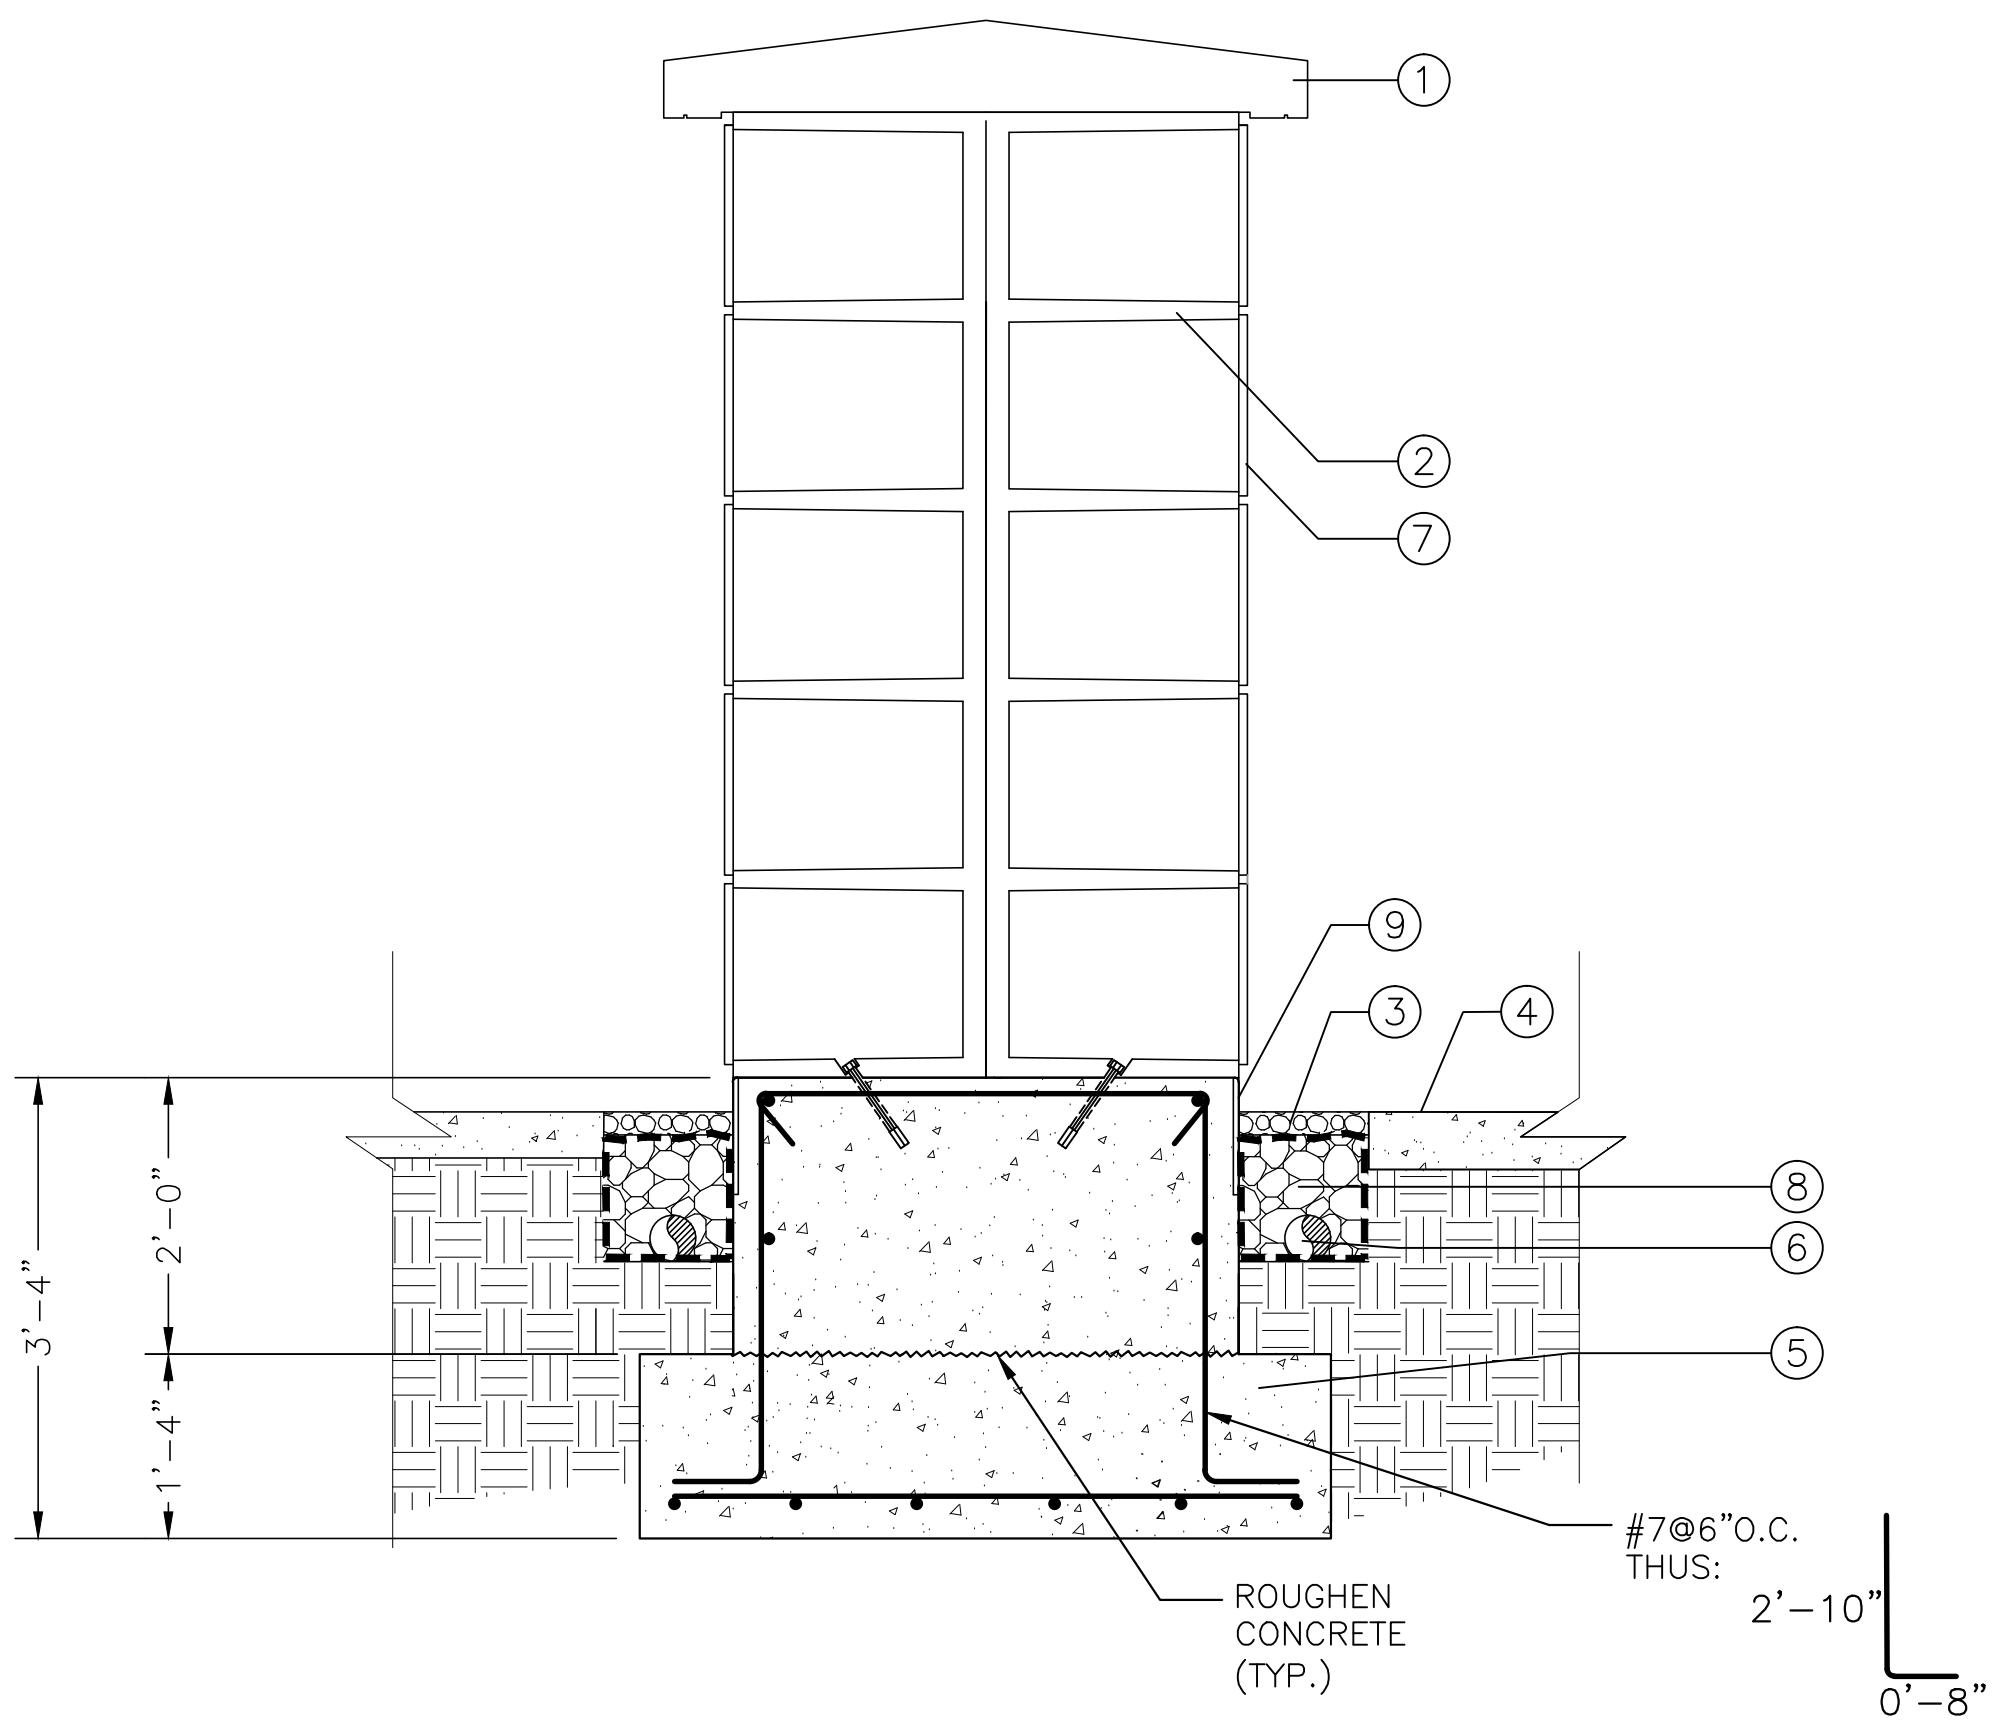

2 COLUMBARIUM FOOTING SECTION 1 OF 2
N.T.S.

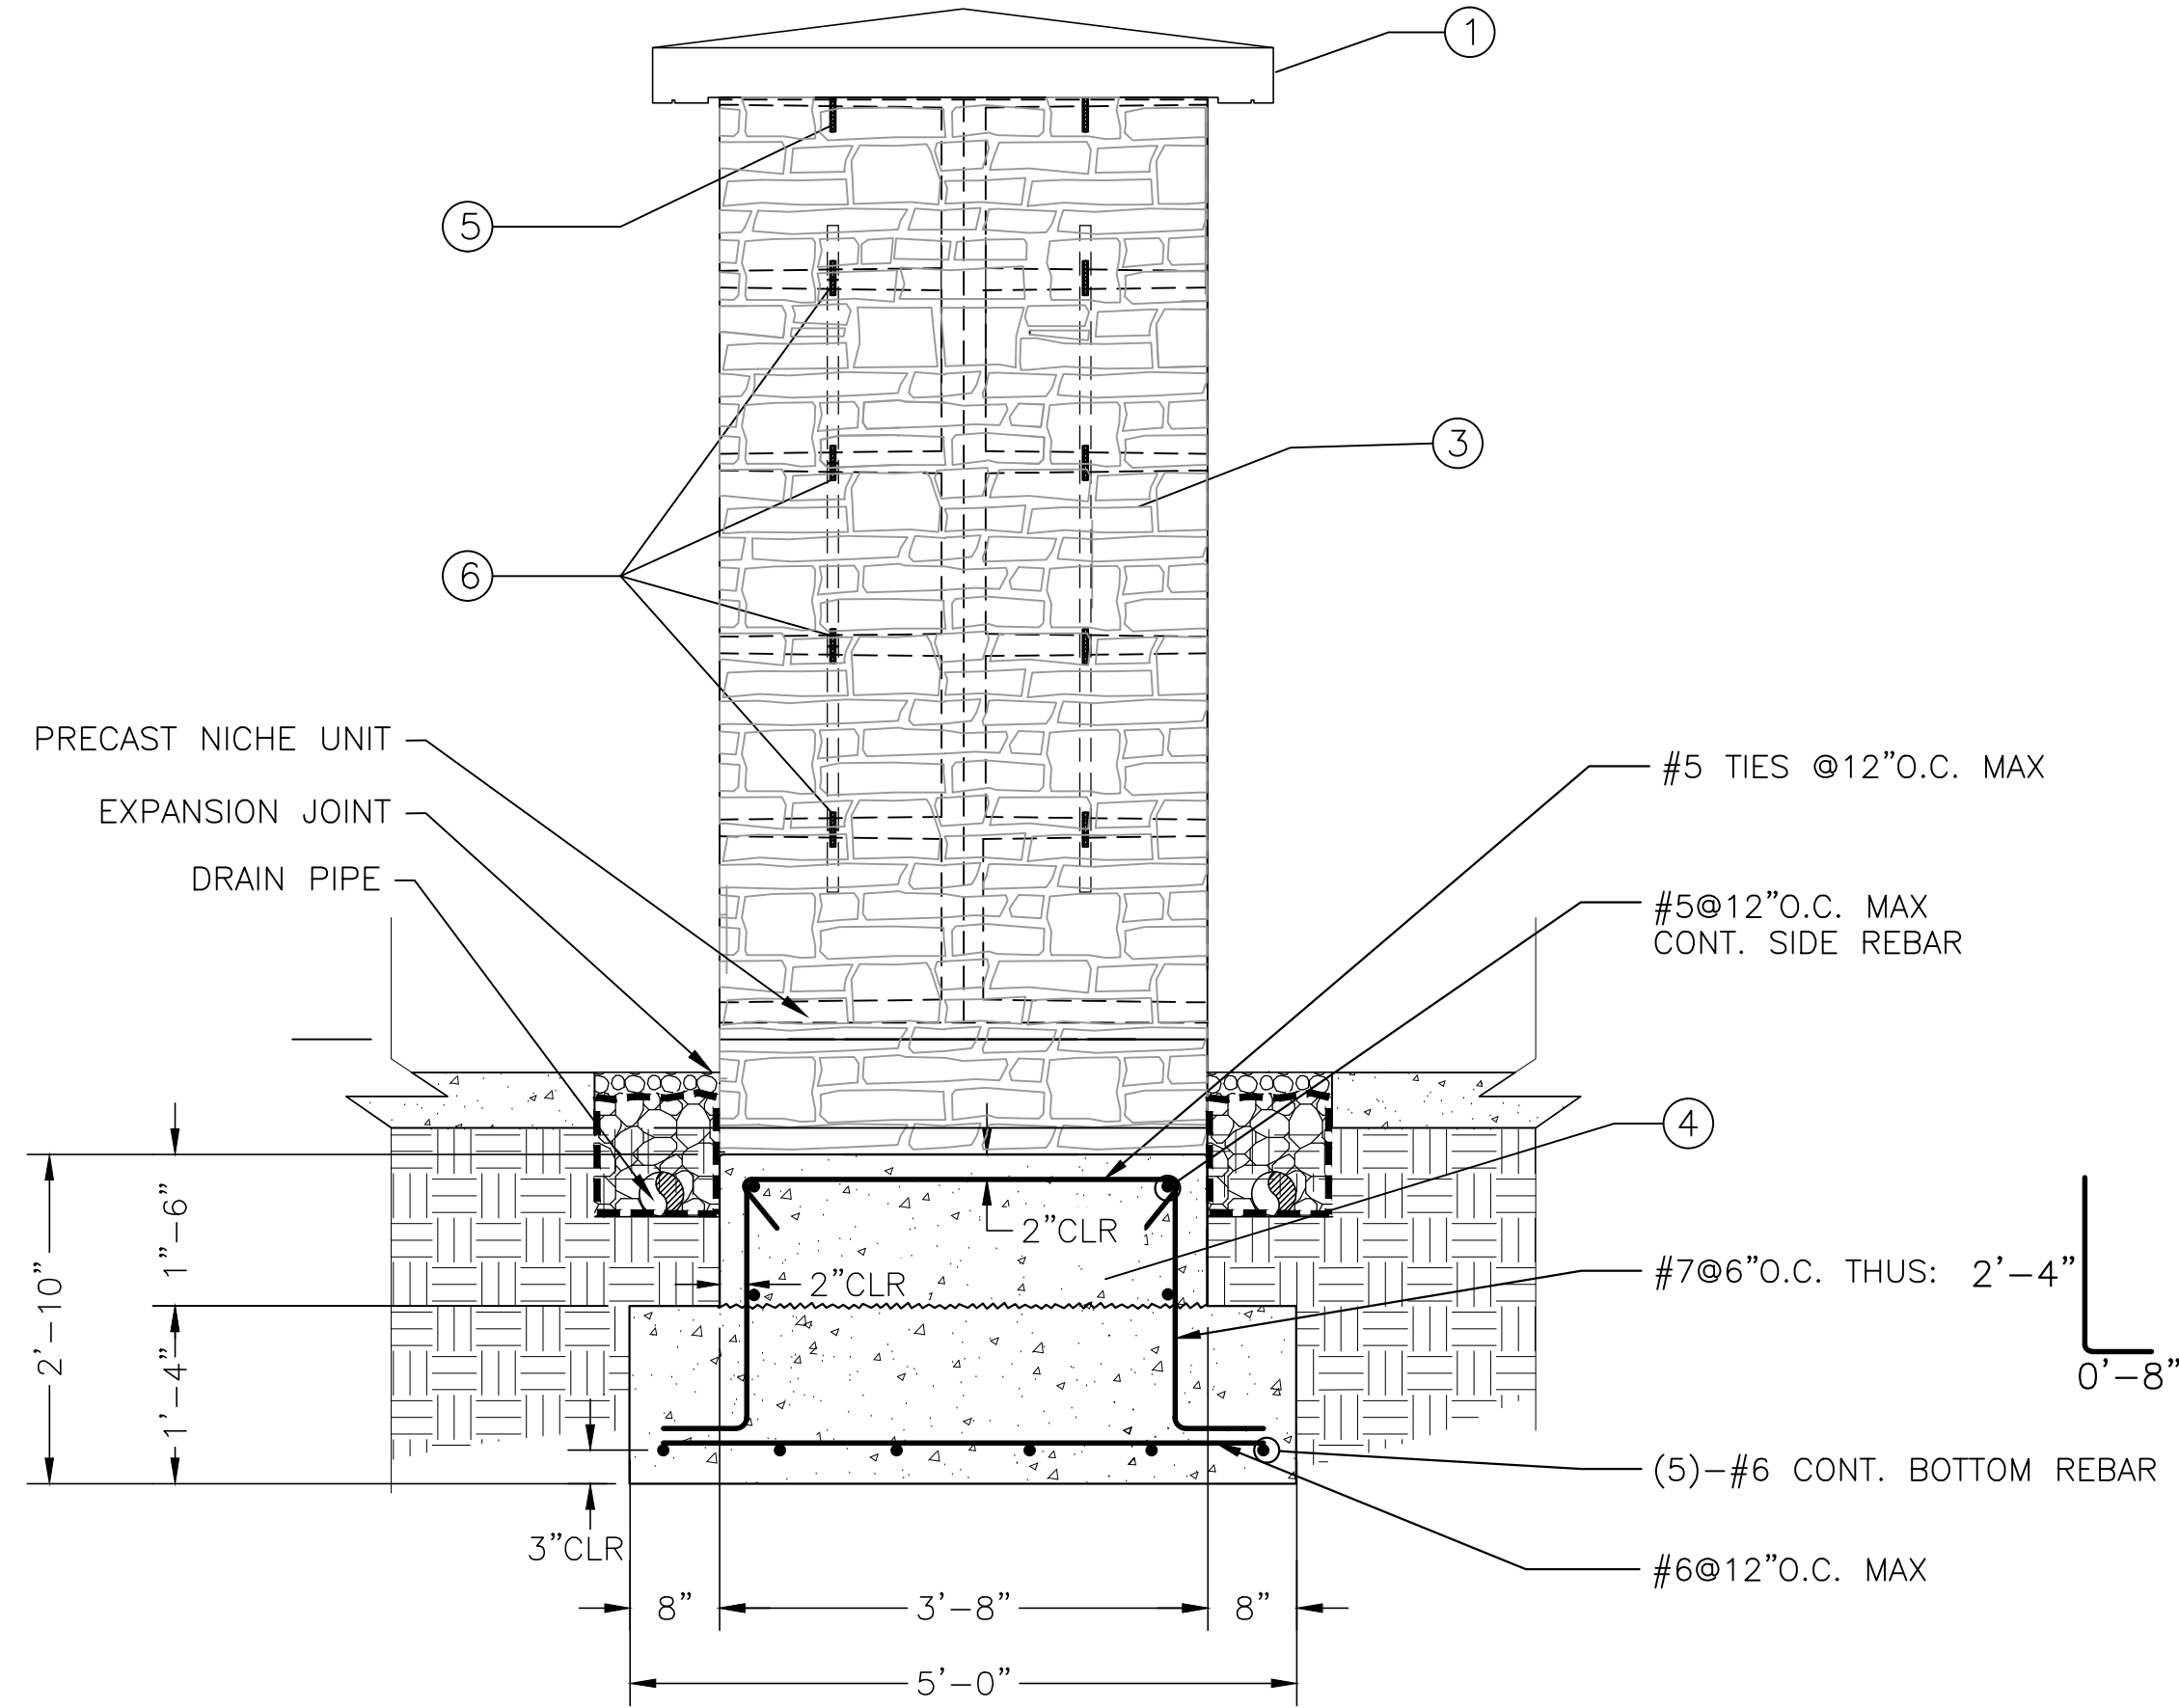

3 COLUMBARIUM FOOTING SECTION 2 OF 2
N.T.S.

- 1 CUT STONE COLUMBARIUM WALL CAP
SEE DETAIL 7 SHEET C-501
- 2 PRECAST COLUMBARIUM WALL UNIT
- 3 12" WIDE DECORATIVE GRAVEL STRIP, 1/2"
BELOW ADJACENT FINISH GRADE. 6" MIN.
DEPTH OF CRUSHED MARBLE GRAVEL
- 4 FINISH GRADE AT CONCRETE WALK
- 5 CAST-IN-PLACE CONCRETE, $f'_c=4\text{KSI}$ WITH
6% AIR-ENTRAINMENT
- 6 4" PVC PERFORATED DRAIN PIPE. CONNECT
TO STORM DRAIN
- 7 NICHE COVER
- 8 WASHED #57 STONE WRAPPED WITH
NON-WOVEN FILTER FABRIC
- 9 12" HIGH POLISHED BLACK GRANITE TILE
3/4" THICK, ON 1" RECESS IN FOOTER

- 1 CUT STONE COLUMBARIUM WALL CAP
SEE DETAIL 7 SHEET C-501
- 2 NOT USED
- 3 MARBLE VENEER, SEE SHEET C-501
- 4 CAST-IN-PLACE CONCRETE,
 $f'_c=4\text{KSI}$ WITH 6% AIR-ENTRAINMENT
- 5 HECKMANN #141 S.S. OR APPROVED EQUAL,
THK MIN. = 3/16"
WIDTH MIN. = 1"
YIELD STR. = 36 KSI
- 6 HECKMANN #103 S.S. DOVETAIL
TRIANGULAR ANCHOR OR APPROVED EQUAL,
YIELD STR. = 36 KSI

BID DOCUMENTS

Revisions	Date	<div><div><div>AMEC FOSTER WHEELER ENVIRONMENT & INFRASTRUCTURE 1075 BIG SHANTY ROAD NW, SUITE 100 KENNESAW, GA. 30144 (770) 421-3400 AMEC PROJECT: 6166-15-0011</div></div></div>	<div><div>MEP ENGINEER:</div><div></div></div>	<div><div></div></div>	<div><div>IRRIGATION DESIGNER:</div><div><div>2231 Weatherstone Circle Conyers, GA 30094 (770) 929-0884, fax (770) 760-8025</div></div></div>	<div><div><div>NATIONAL CEMETERY ADMINISTRATION</div></div></div>	<div>Drawing Title</div> <div>COLUMBARIUM FOOTING DETAILS</div>	<div>Project Title</div> <div>4000 NICHE COLUMBARIUM GEORGIA NATIONAL CEMETERY</div>	<div>Date</div> <div>23 OCTOBER 2015</div>
							<div>Approved: Director, Technical Support Service</div>	<div>Building Number</div> <div></div> <div>Checked</div> <div></div> <div>Drawn</div> <div></div>	<div>Project No.</div> <div>922CM3005</div>
							<div>Approved: Chief, Architectual & Engineering Division</div>	<div>Location</div> <div>1080 VETERANS CEMETERY RD, CANTON, GA 30114</div>	<div>DRAWING NO.</div> <div>S-501</div> <div>Sheet 31 of 31</div>